

4.	IN LIEU OF STRUNG ALO	ONG THE TOP OF PIPE, PROVIDED IT IS T.	PIPE, WIRE MAY BE APED TO THE PIPE				NOT TO S	CALI
UNSWICK.	INSWICK-GUL	DRINGWICK CLANDI JODIT WATER				ВҮ	REVISION	DAT
2				JWS	C 2-9	-	-	-
NI	OISS OISS	& SEWER COMMISSION				-	-	-
NE I		1703 Gloucester Street Phone: (912) 261-7110 Brunswick, Georgia 31520 Fax: (912) 261-7178	PACER WIRE AROUND PVC PIPE, WIRE MAY BE DEPREMENTATION DEPREMENTATION NOT TO SCALE OF PIPE, PROVIDED IT IS TAPED TO THE PIPE NOT TO SCALE OURATE POSITION MAINTAINED DURING BACKFILL. NOT TO SCALE OF OLYNN JOINT WATER TRACER WIRE FR COMMISSION TRACER WIRE Phone: (912) 261-7110 INSTALLATION 520 Fax: (912) 261-7178					
	A & SEWER	Website: www.bgjwsc.org		DATE: 05/26/2022	SCALE: NTS	-	-	-


OF DUCTILE IRON FITTING (VALVE). NEXT WRAP WIRE 2 TURNS AROUND BELL OF FITTING (VALVE) AND WIND WITH A CONTINUOUS LENGTH OF AT LEAST 4 TERMINATE AT FITTING IN A SIMILAR MANNER AS NOTED ABOVE.


1. USE #10 AWG SOLID PLASTIC COATED COPPER WIRE.


NOTE:

- 3 ALL SPLICES MUST BE MADE BY USING COPPER WIRE SPLICE "U" BOLT

- WRAPS PER LENGTH OF PVC PIPE TO THE NEXT DUCTILE IRON FITTING.

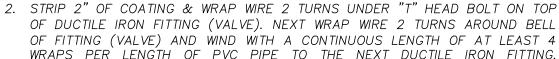

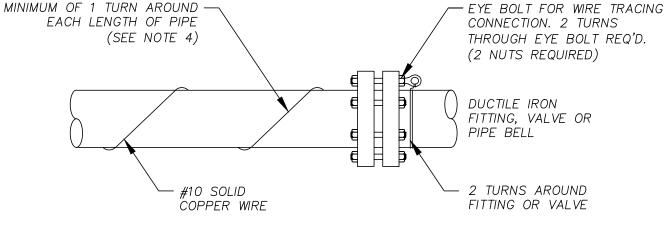

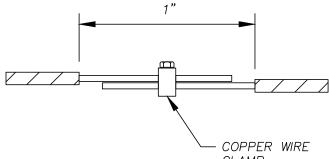

CLAMP

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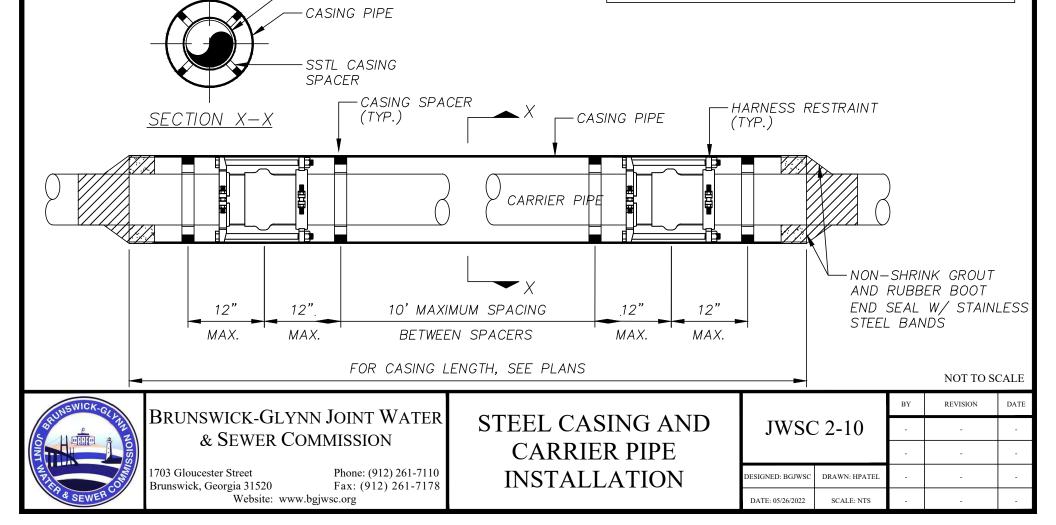
GENERAL NOTES:

- 1. DETAIL SHOWN IS FOR CITY AND COUNTY ROADWAY CROSSINGS.
- 2. INSTALLATIONS UNDER STATE ROADS AND RAILROADS MAY HAVE REQUIREMENTS DIFFERENT FROM THOSE SHOWN. SUCH INSTALLATIONS SHALL MEET ALL APPLICABLE REQUIREMENTS OF THE GEORGIA DEPARTMENT OF TRANSPORTATION OR THE PARTICULAR RAILROAD INVOLVED.
- 3. SEE BGJWSC STANDARD CONSTRUCTION SPECIFICATIONS FOR ADDITIONAL INFORMATION.
- 4. CASING SIZE SHOWN ARE FOR DUCTILE IRON PIPE. FOR PVC PIPE AND HARNESS RESTRAINTS, ADJUST CASING PIPE DIAMETER ACCORDINGLY.
- 5. STEEL CASING SHALL EXTEND 3' BEYOND TOE OF SLOPE OR CENTER OF DITCH, 3' BEYOND BACK OF CURB, 10' BEYOND TOP OF CREEK BANK OR 10' BEYOND EDGE OF PAV'T. WHERE APPLICABLE.

CARRIER PIPE

6. ALL JOINTS WITHIN CASING TO BE RESTRAINED.


CARRIER PIPE DIAMETER (INCHES)	CASING PIPE DIAMETER (INCHES)	WALL THICKNESS* (INCHES)
6	12	0.375
8	16	0.375
10	16	0.375
12	20	0.375
14	22	0.375
16	24	0.375
18	30	0.375
20	30	0.375
24	36	0.375
30	42	0.375
* SEE NOTE 2		1





GENERAL NOTES:

- 1. DETAIL SHOWN IS FOR STATE ROADWAY CROSSINGS.
- 2. INSTALLATIONS UNDER CITY OF BRUNSWICK AND GLYNN COUNTY ROADS MAY HAVE REQUIREMENTS DIFFERENT FROM THOSE SHOWN. INSTALLATIONS SHALL MEET ALL APPLICABLE REQUIREMENTS OF THE GEORGIA DEPARTMENT OF TRANSPORTATION.
- 3. SEE BGJWSC STANDARD CONSTRUCTION SPECIFICATIONS FOR ADDITIONAL INFORMATION.
- 4. CASING SIZES SHOWN ARE FOR C-900 FPVC. CARRIER PIPE SIZES ARE FOR C-900 FPVC DR18 UNLESS OTHERWISE NOTED. CASINGS AND CARRIER PIPE SHALL BE BLUE OR GREEN IN COLOR.

	CARRIER PIPE DIAMETER (INCHES)	CARRIER PIPE OD DIAMETER (INCHES)	CASING PIPE DIAMETER (INCHES)	CASING PIPE ID DIAMETER (INCHES)	WALL THICKNESS* (INCHES)
N.	6	6.90	10	9.79	0.620
	8	9.05	12	11.65	0.720
	10	11.10	14	13.50	0.850
	12	13.20	16	15.35	0.970
	14	15.30	18	17.20	1.080
	16	17.40	24	22.76	1.430
S	18	19.50	24	22.76	1.430
S	20	21.60	30*	28.77	1.520
	24	25.80	30*	28.77	1.520
	30*	32.00	36*	34.43	1.820
	* DR 21				

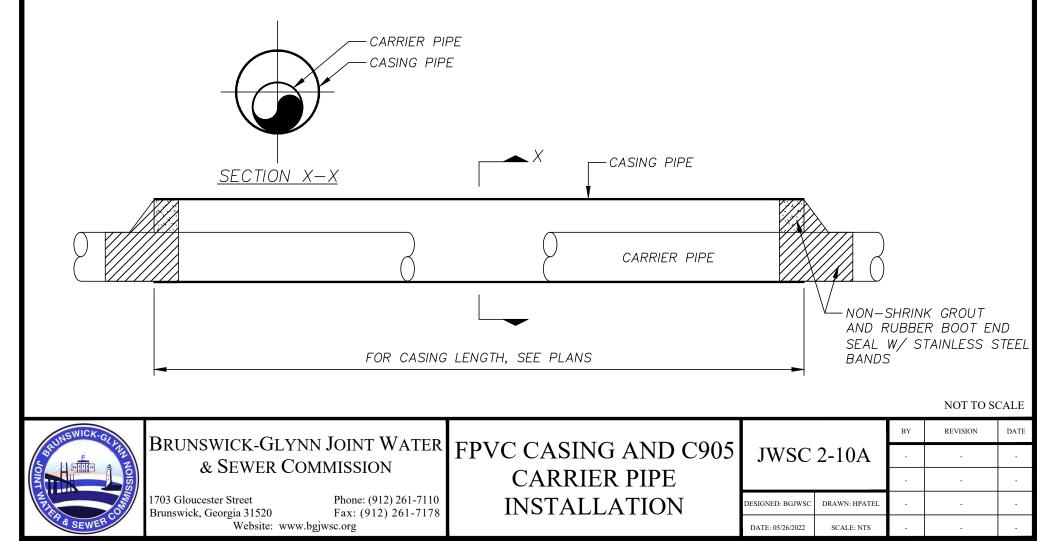

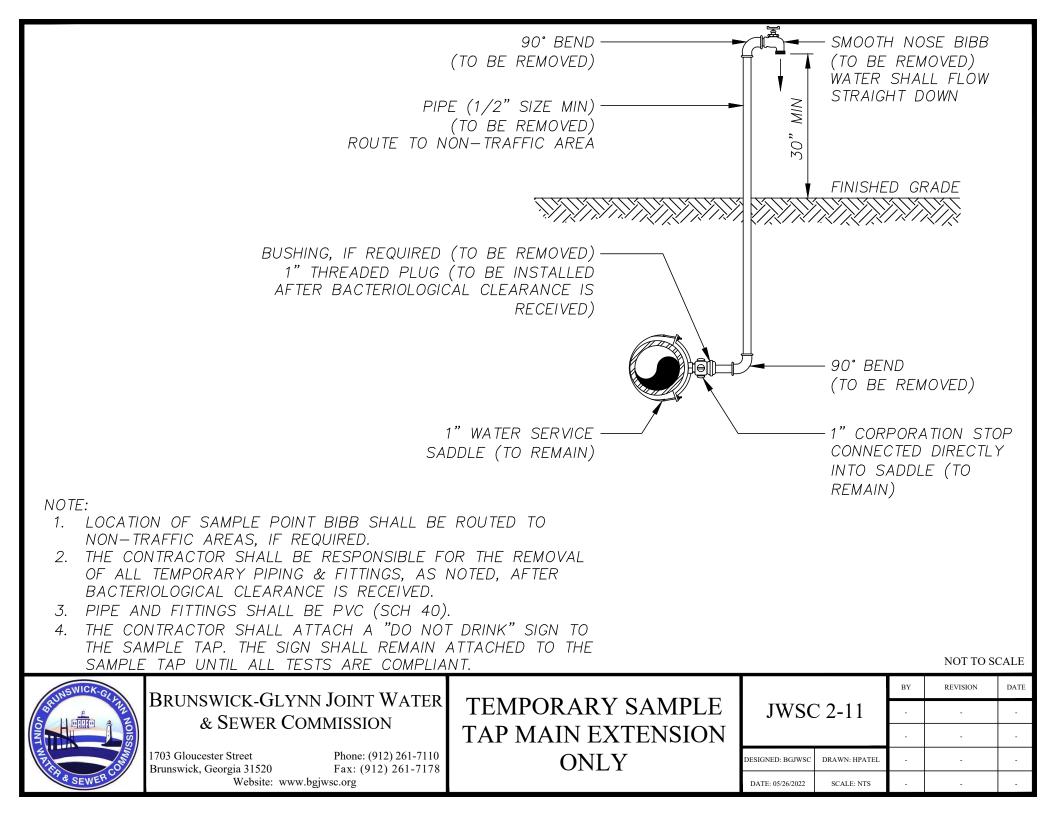


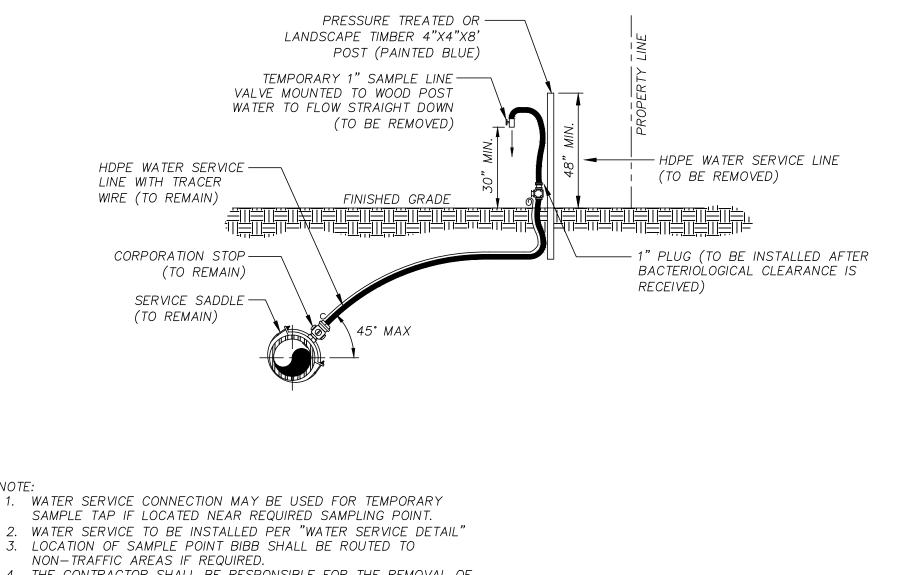



4. THE CONTRACTOR SHALL BE RESPONSIBLE FOR THE REMOVAL OF ALL TEMPORARY PIPING & FITTINGS. AS NOTED. AFTER BACTERIOLOGICAL CLEARANCE IS RECEIVED.


NOTE:


UNSWICK-GU	DRINGWICK CLARN IODIT WATER			JWSC 2-12		BY	REVISION	DATE
	BRUNSWICK-GLYNN JOINT WATER & SEWER COMMISSION	TYPICAL WATER	-			-	-	
		SERVICE/TEMPORARY	-			-	-	
The second	1703 Gloucester Street Brunswick, Georgia 31520	Phone: (912) 261-7110 Fax: (912) 261-7178	SAMPLE TAP	DESIGNED: BGJWSC	DRAWN: HPATEL	-	-	-
A SEWER C	Website: www.b			DATE: 05/26/2022	SCALE: NTS	-	-	-

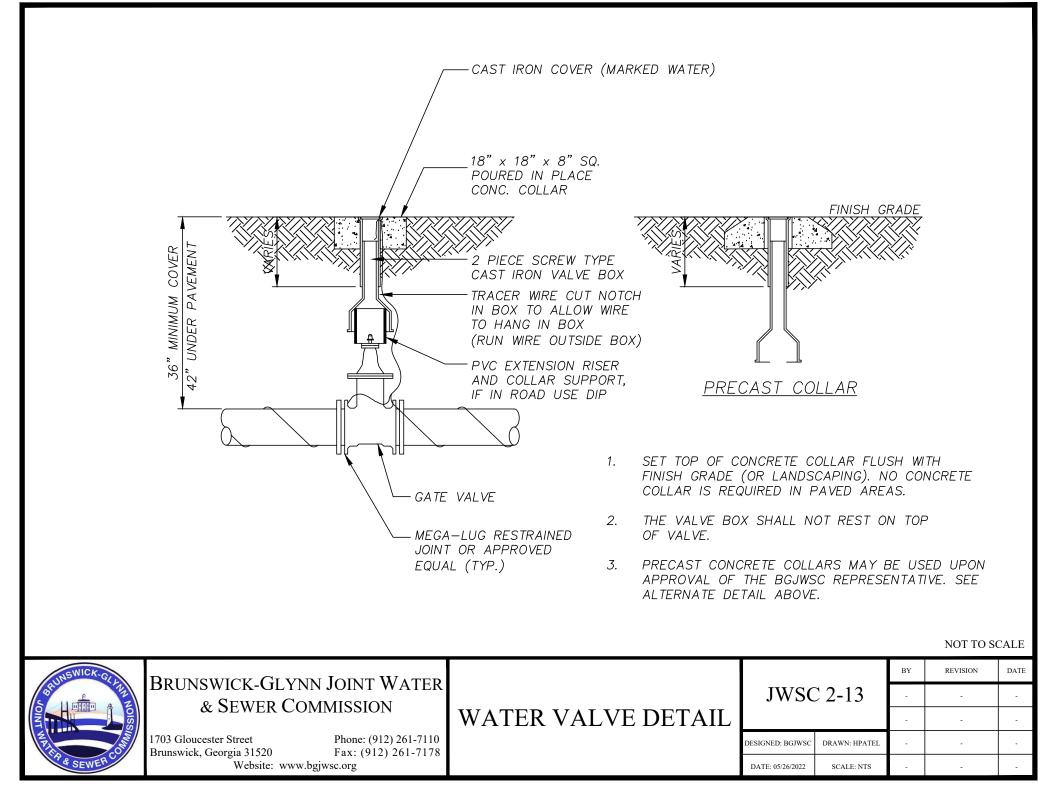

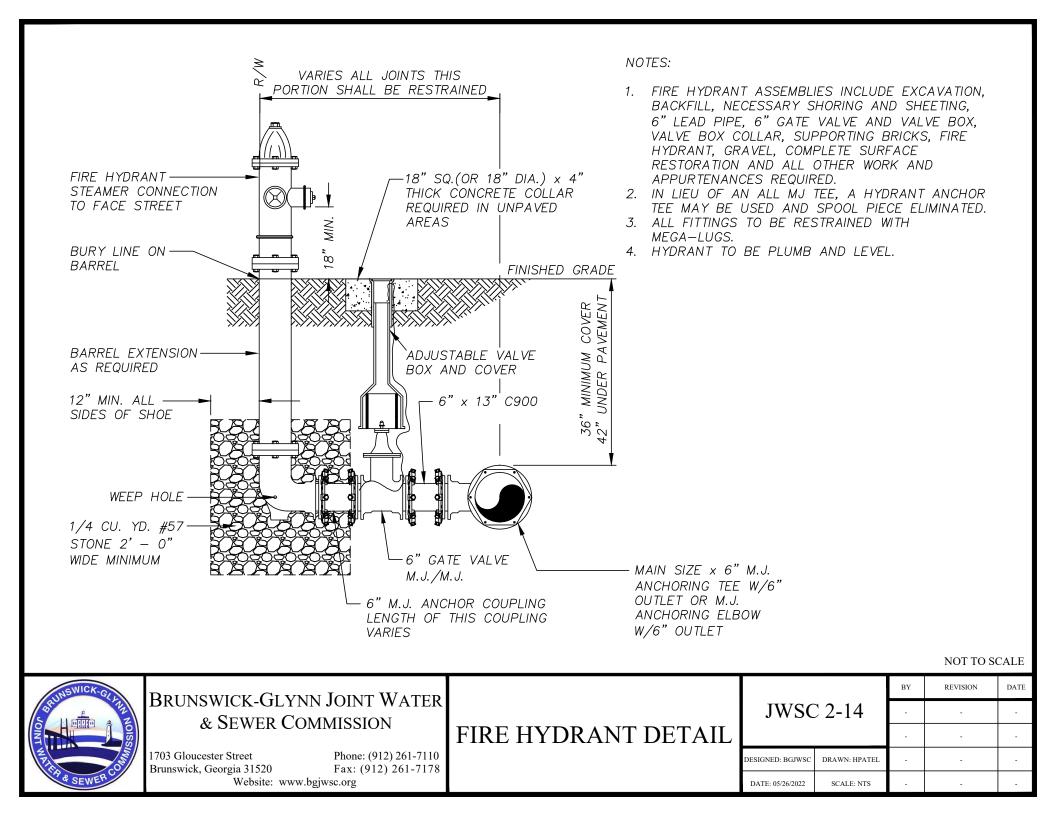

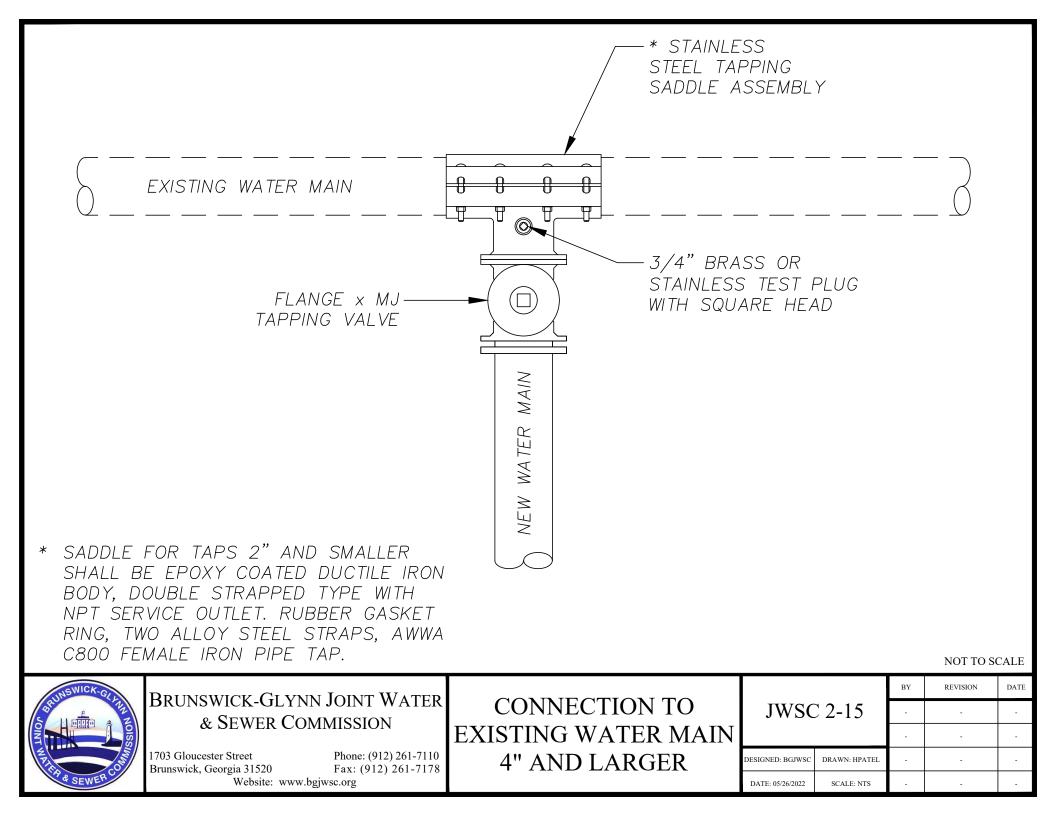

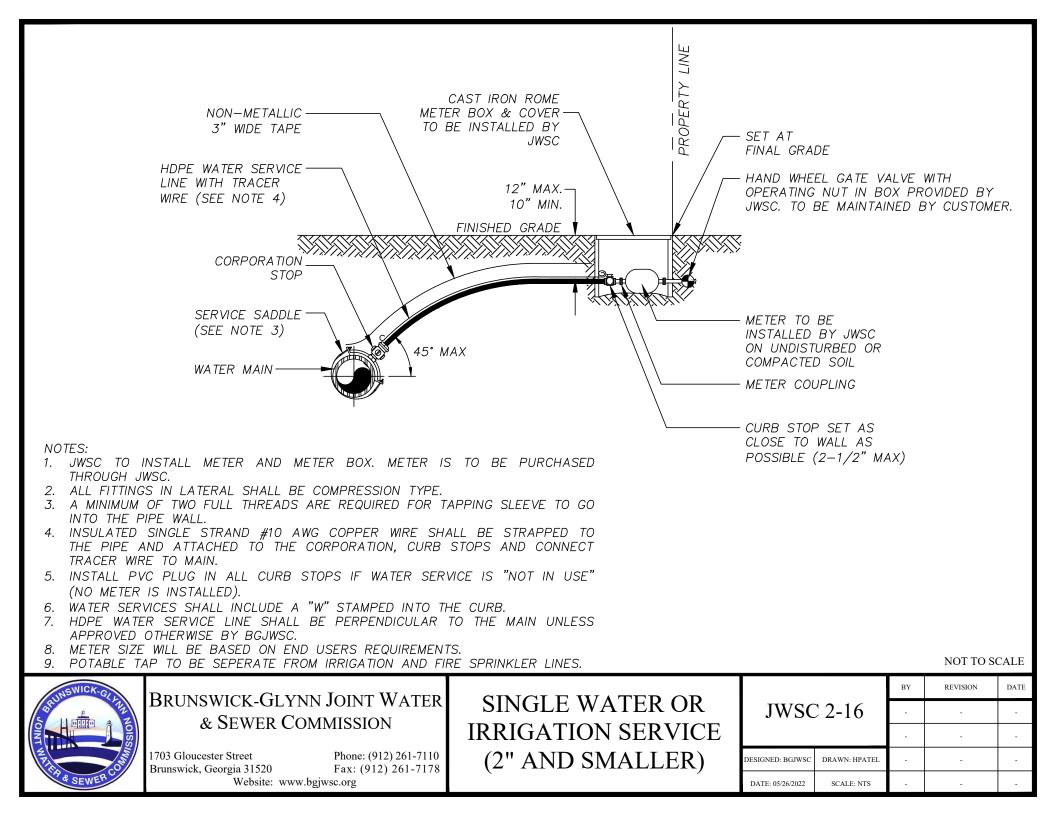

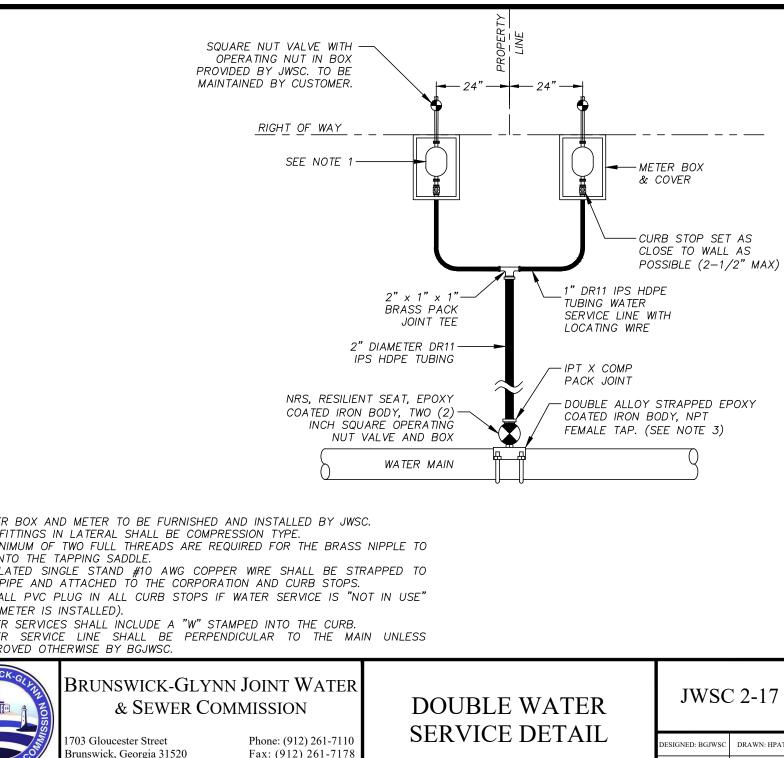



BY REVISION DATE --DRAWN: HPATEL -DATE: 05/26/2022 SCALE: NTS

NOTE:

- 1. METER BOX AND METER TO BE FURNISHED AND INSTALLED BY JWSC.
- ALL FITTINGS IN LATERAL SHALL BE COMPRESSION TYPE. 2.
- 3. A MINIMUM OF TWO FULL THREADS ARE REQUIRED FOR THE BRASS NIPPLE TO GO INTO THE TAPPING SADDLE.
- INSULATED SINGLE STAND #10 AWG COPPER WIRE SHALL BE STRAPPED TO 4. THE PIPE AND ATTACHED TO THE CORPORATION AND CURB STOPS.
- 5. INSTALL PVC PLUG IN ALL CURB STOPS IF WATER SERVICE IS "NOT IN USE" (NO METER IS INSTALLED).
- WATER SERVICES SHALL INCLUDE A "W" STAMPED INTO THE CURB. 6.
- WATER SERVICE LINE SHALL BE PERPENDICULAR TO THE MAIN UNLESS 7. APPROVED OTHERWISE BY BGJWSC.

Website: www.bgjwsc.org

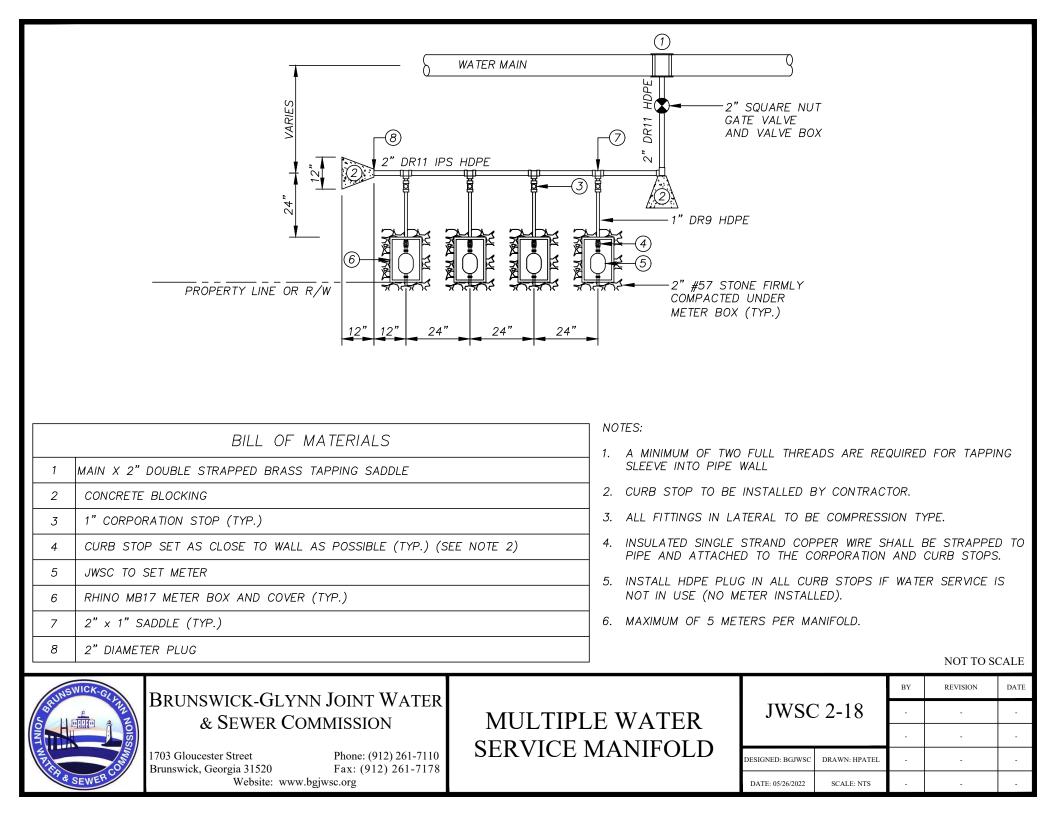

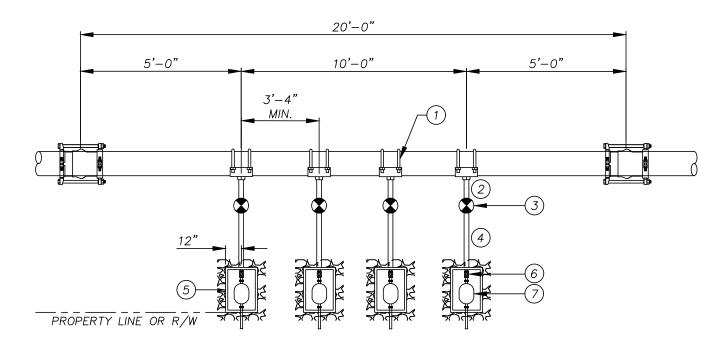

BILL OF MATERIALS								
1	MAIN × 2" DOUBLE STRAPPED BRASS TAPPING SADDLE							
2	2" BRASS NIPPLE							
3	2" NON RISING STEM SQ. NUT VALVE AND VALVE BOX							
4	2" DR9 HDPE TUBING							
5	24" × 36" JUMBO METER BOX BY JWSC							
6	2" COMPRESSION x FIP BRASS CURB STOP							
7	2" METER BY JWSC							

NOTES:

- 1. A MINIMUM OF TWO FULL THREADS ARE REQUIRED FOR TAPPING SLEEVE INTO PIPE WALL.
- 2. CURB STOP TO BE INSTALLED BY CONTRACTOR.
- 3. ALL FITTINGS IN LATERAL TO BE COMPRESSION TYPE.
- 4. INSULATED SINGLE STRAND COPPER WIRE SHALL BE STRAPPED TO PIPE AND ATTACHED TO THE CORPORATION AND CURB STOPS FOR WIRE TRACING.
- 5. INSTALL PVC PLUG IN ALL CURB STOPS IF WATER SERVICE IS NOT IN USE (NO METER INSTALLED)




BRUNSWICK-GLYNN JOINT WATER & SEWER COMMISSION

1703 Gloucester StreetPhone: (912) 261-7110Brunswick, Georgia 31520Fax: (912) 261-7178Website:www.bgjwsc.org

MULTIPLE WATER SERVICE MANIFOLD


		BY	REVISION	DATE
JWSC	2-18A	-	-	-
		-	-	-
DESIGNED: BGJWSC	DRAWN: HPATEL	-	-	-
DATE: 05/26/2022	SCALE: NTS	-	-	-

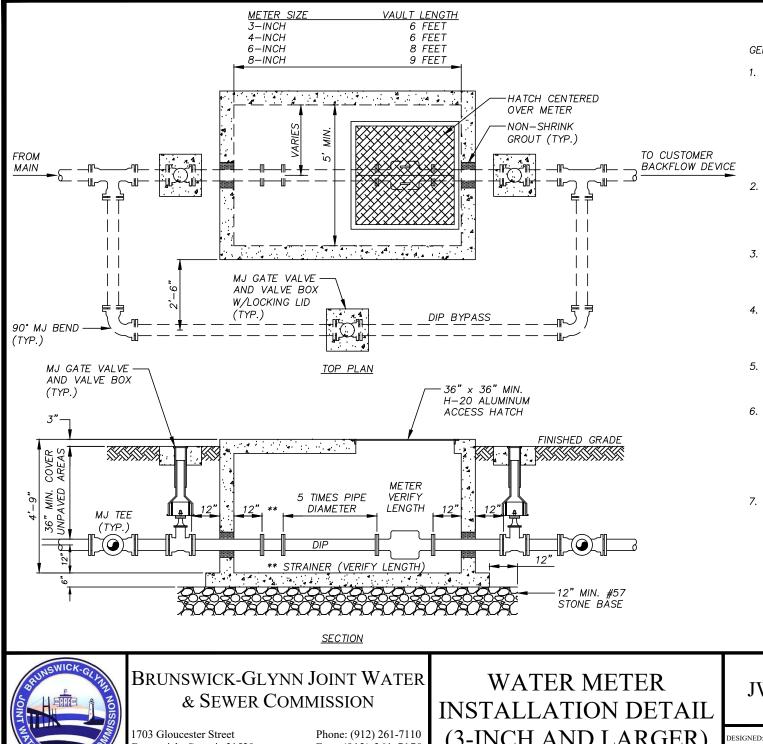



GENERAL NOTES:

- 1. WATER METER TO BE PURCHASED FROM THE BRUNSWICK-GLYNN COUNTY JOINT WATER AND SEWER COMMISSION (JWSC). THE JWSC WILL COORDINATE WITH THE UTILITY CONTRACTOR AND WILL INSTALL THE METER. THE OWNER WILL PAY ALL COSTS FOR THE PURCHASE OF THE METER FROM JWSC AS WELL AS ALL ASSOCIATED CONNECTION AND ACCOUNT SET-UP FEES.
- 2. CONTRACTOR SHALL BE RESPONSBIBLE FOR ALL NECESSARY PIPE, VALVES, FITTINGS, ACCESSORIES, PRECAST VALVE VAULT AND ALL OTHER WORK AND APPURTENANCES REQUIRED.
- 3. PRECAST CONCRETE VALVE VAULT TO BE IN ACCORDANCE WITH ASTM C-478. A FACTORY INSTALLED 10MM BITUMASTIC COATING IS REQUIRED.
- 4. ALL INTERIOR FITTINGS TO BE DUCTILE IRON WITH FLANGED JOINTS. BURIED FITTINGS TO BE DUCTILE IRON WITH MECHANICAL JOINTS UTILIZING MEGA-LUG JOINT RESTRAINTS.
- 5. TRANSMITTER FOR THE WATER METER SHALL BE LOCATED AS DIRECTED BY THE JWSC INSPECTOR.
- 6. ALUMINUM ACCESS COVER SHALL BE MODEL W13636 AS MANUFACTURED BY HALLIDAY PRODUCTS INC. OR APPROVED EQUAL. BEFORE THE VAULT IS DELIVERED TO THE SITE. THE CONTRACTOR SHALL SUBMIT SHOP DRAWINGS FROM THE VAULT MANUFACTURER FOR REVIEW.
- 7. THE Y STRAINER SHALL BE MANUFACTURED BY KECKLEY OR APPROVED EQUAL.

SECTION							SCALE
UNSWICK-GL	DUNGWICK CLAIN IONIT WAT					REVISION	DATE
	BRUNSWICK-GLYNN JOINT WATER & SEWER COMMISSION	WATER METER INSTALLATION DETAIL	JWSC 2-19		-	-	-
	& SEWER COMMISSION				-	-	-
THE SO	1703 Gloucester Street Phone: (912) 261-7 Brunswick, Georgia 31520 Fax: (912) 261-7		DESIGNED: BGJWSC	DRAWN: HPATEL	-	-	-
A SEWER	Website: www.bgjwsc.org		DATE: 05/26/2022	SCALE: NTS	-	-	-

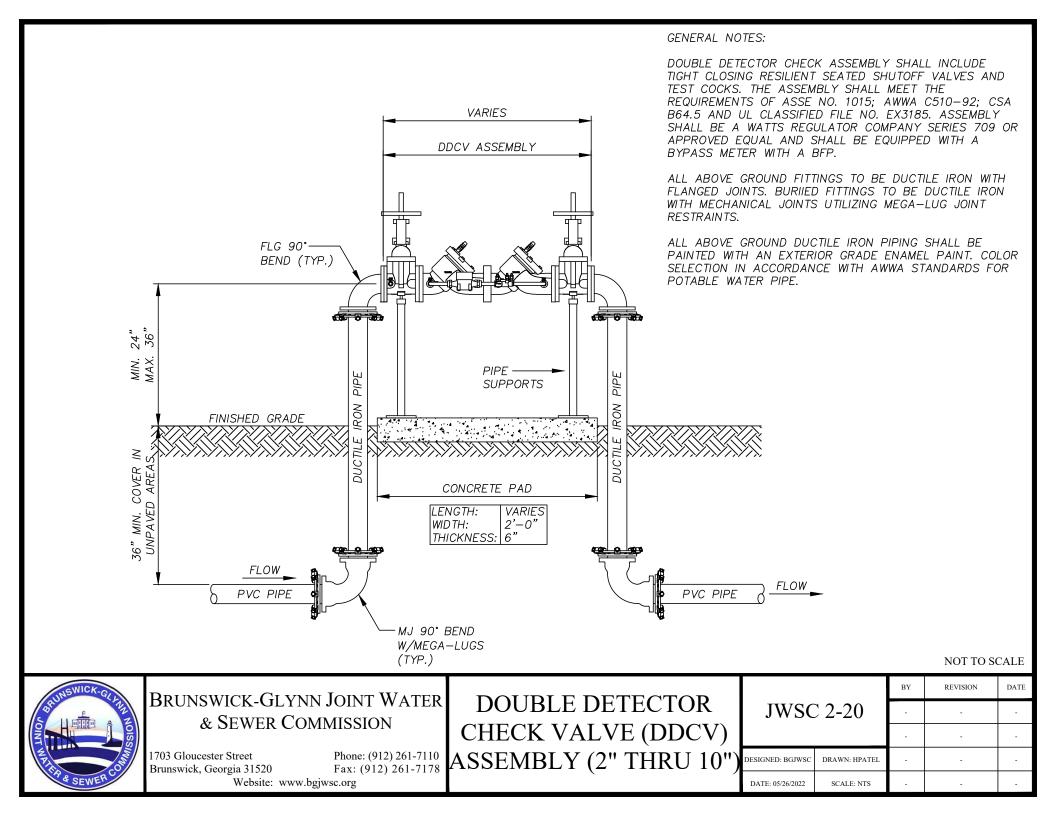

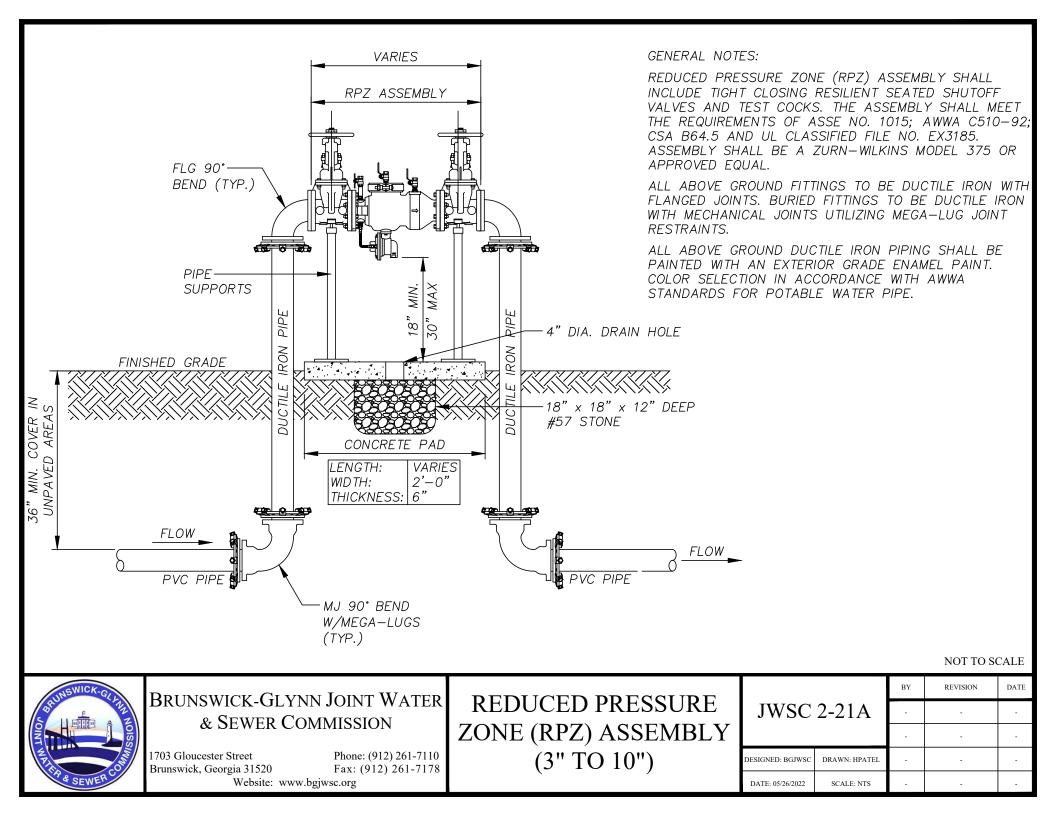

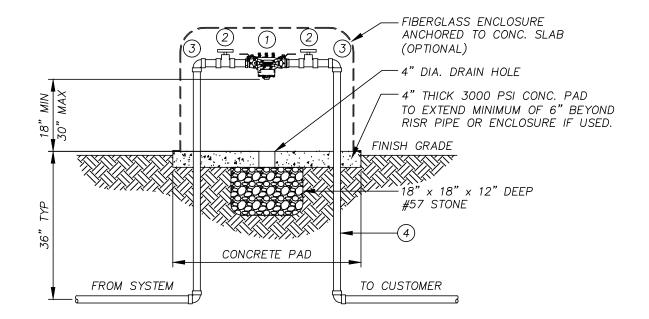

	MATERIALS								
QTY.	DESCRIPTION								
1	1RPZ ASSEMBLY (ZURN-WILKINS OR EQUAL)2FULL PORT BALL VALVE								
2									
3	3 90° ELBOW								
4 BRASS, HARD COPPER OR SCH 80 PVC									
PROVIDE ALL BRASS FITTINGS, NIPPLES, COUPLINGS, ETC. REQUIRED FOR THE COMPLETE INSTALLATION. FOR INSTALLATIONS LOCATED IN OR NEAR PARKING LOTS AND DRIVEWAYS, STEEL PIPE BOLLARDS ARE RECOMMENDED.									



BRUNSWICK-GLYNN JOINT WATER

& SEWER COMMISSION

Website: www.bgjwsc.org

1703 Gloucester Street

Brunswick, Georgia 31520

Phone: (912) 261-7110

Fax: (912) 261-7178

DEDUCED DDESSUDE			BY	REVISION	DATE
REDUCED PRESSURE	JWSC 2-21B		-	-	-
ZONE (RPZ) ASSEMBLY			-	-	-
(2.5" & SMALLER)	DESIGNED: BGJWSC	DRAWN: HPATEL	-	-	-
``````````````````````````````````````	DATE: 05/26/2022	SCALE: NTS	-	-	-

#### ROAD REPAIR REQUIREMENTS:


1. JWSC MUST REVIEW ROAD CUT AND APPROVE FINAL DIMENSIONS OF AREA TO BE PAVED PRIOR TO FINAL PAVING. ALL ROAD CUTS MUST BE NEATLY SQUARE CUT AND PERPENDICULAR TO THE LINES AND GENERAL DIRECTION OF THE ROAD WAY AND A MINIMUM OF 12" BEYOND FINAL DISTURBED AREA. ENTIRE WIDTH OF LANE IS TO BE REPAVED FOR ROAD CUTS THAT ARE UP TO OR EXCEED HALF THE DISTANCE OF THE LANE. ENTIRE WIDTH OF ROAD IS TO BE REPAVED FOR ROAD CUTS THAT ARE UP TO OR EXCEED HALF THE DISTANCE OF THE LANE. ENTIRE WIDTH OF ROAD IS TO BE REPAVED FOR ROAD CUTS THAT ARE UP TO OR EXCEED HALF THE DISTANCE OF THE ROAD. ROAD MUST BE REPAIRED AS OUTLINED BELOW PER THE STANDARD JWSC ROAD REPAIR DETAIL WITHIN 30 DAYS AFTER ROAD IS CUT INCLUDING ANY APPLICABLE ROAD STRIPING. COMPACTION TEST IS REQUIRED TO ENSURE 100% COMPACTION OF BACKFILL AND BASE MATERIAL. COMPACTION TEST RESULTS MUST BE FORWARDED TO JWSC REFLECTING TWO RESULTS OF THE BACKFILL AND BASE MATERIAL.

2. CUTS EXCEEDING 150 FEET IN LENGTH, THE BASE MATERIAL SHALL BE BROUGHT FLUSH TO THE BOTTOM OF THE EXISTING PAVEMENT, EXISTING PAVEMENT SHALL BE SAW CUT TO A STRAIGHT EDGE AND THE ENTIRE WIDTH OF THE ROADWAY RESURFACED WITH A MINIMUM OF 1" OF TYPE "E" ASPHALT TOPPING.

3. DEPENDING ON THE EXISTING ROAD CONDITION, TIE IN POINTS MAY REQUIRE ADDITIONAL MILLING AND BLENDING AS DETERMINED BY JWSC.

4. DEPENDING ON THE EXISTING ROAD CONDITION AND LOCATION OF THE ROAD CUT, FLOWABLE FILL MAY BE REQUIRED AS BACKFILL MATERIAL. TO BE DETERMINED BY JWSC.


5. ANY PAVEMENT REPLACEMENT WITHIN G-DOT, GLYNN COUNTY OR CITY OF BRUNSWICK RIGHTS-OF-WAY PLEASE REFER TO THEIR LATEST DETAIL STANDARDS AND SPECIFICATIONS.

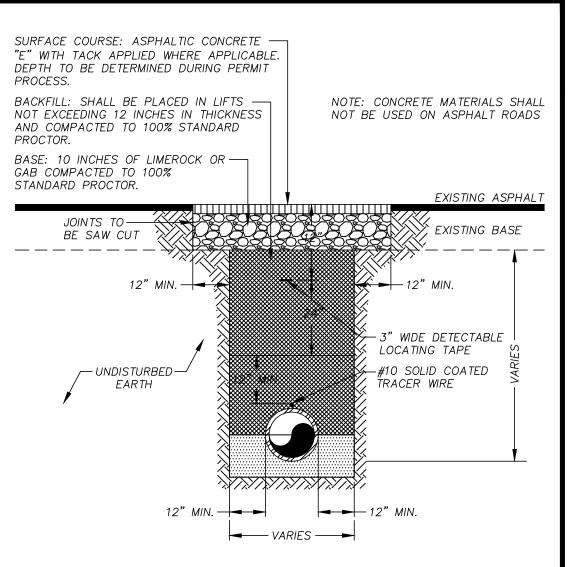



### NOTE:


IF THE EXISTING ROAD SURFACE HAS IRREGULARITIES ON EITHER SIDE OF THE PROPOSED STREET CUT AN ASPHALT OVERLAY MAY BE REQUIRED TO MAKE A SMOOTH RIDING SURFACE. ALL IRREGULARITIES IN EXCESS OF 3/16 INCH IN TEN FEET SHALL BE CORRECTED.


INSWICK-GUN	DDUNGWICK CLYNN	IN JOINT WATER			BY	REVISION	DATE	
	& SEWER COM		ASPHALT PAVEMENT	VEMENT JWSC 2-22	C 2-22	-	-	-
		MISSION	REPLACEMENT			-	-	-
The second second	1703 Gloucester Street      Phone: (912) 261-7110        Brunswick, Georgia 31520      Fax: (912) 261-7178		DESIGNED: BGJWSC	DRAWN: HPATEL	-	-	-	
P& SEWER C	Website: www.bgj	( )		DATE: 05/26/2022	SCALE: NTS	-	-	-

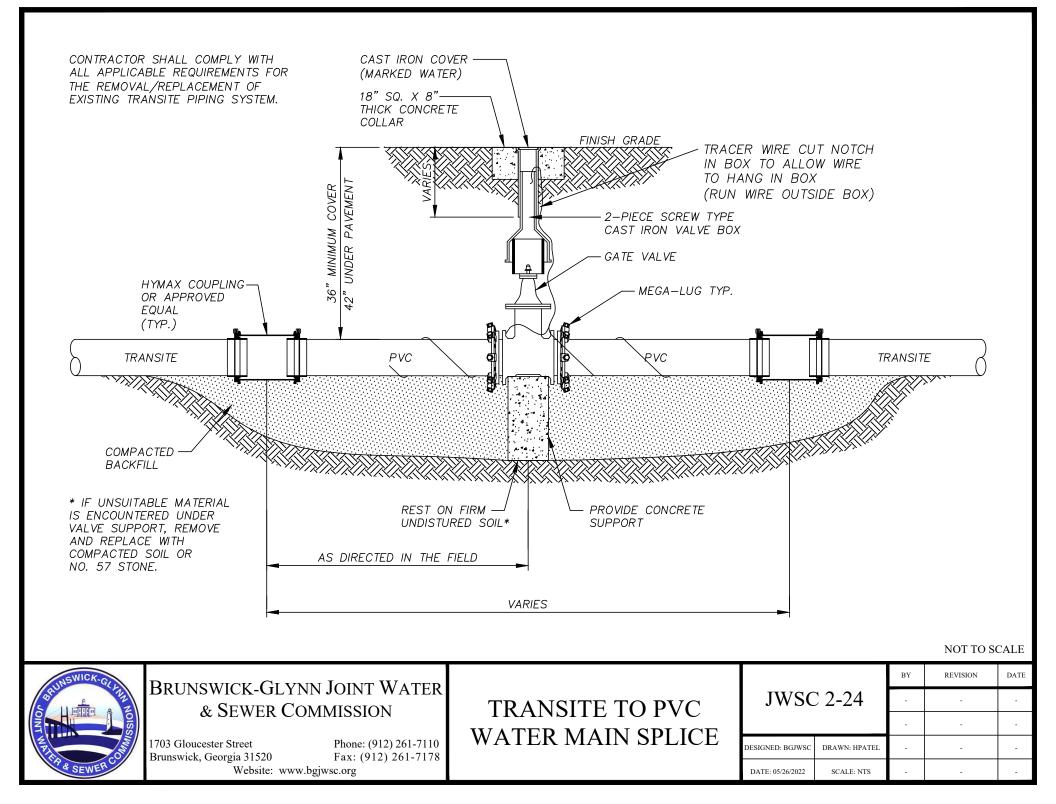


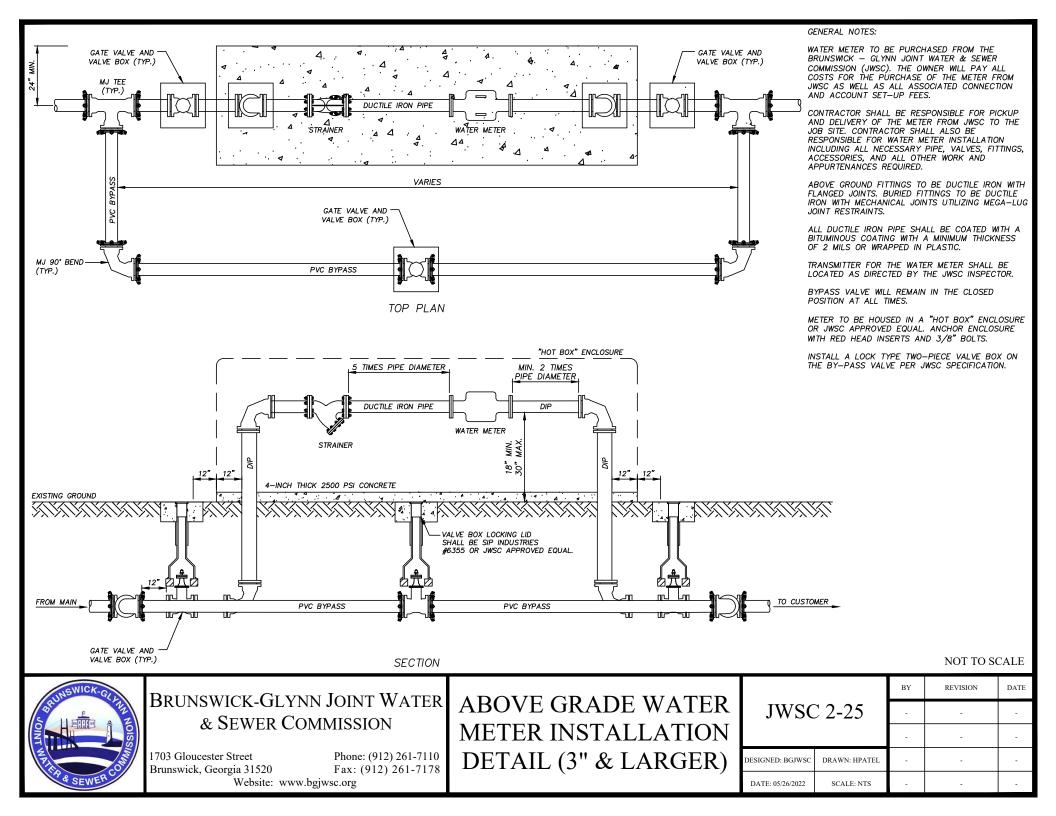


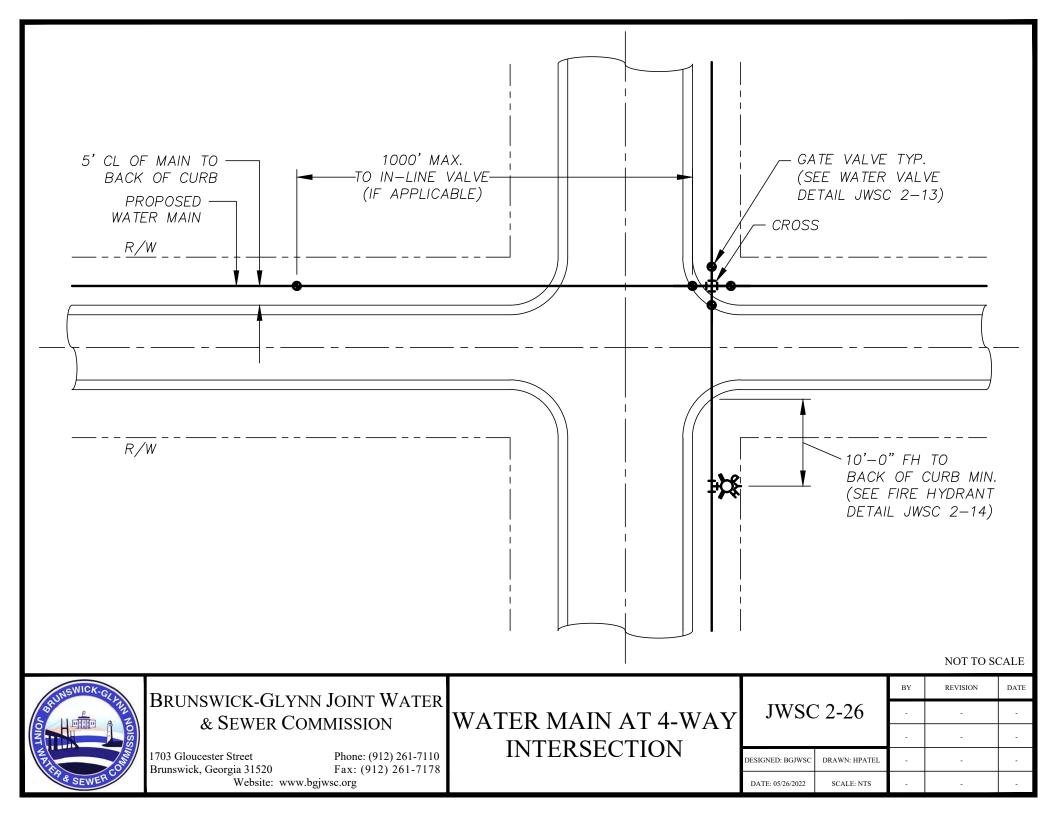


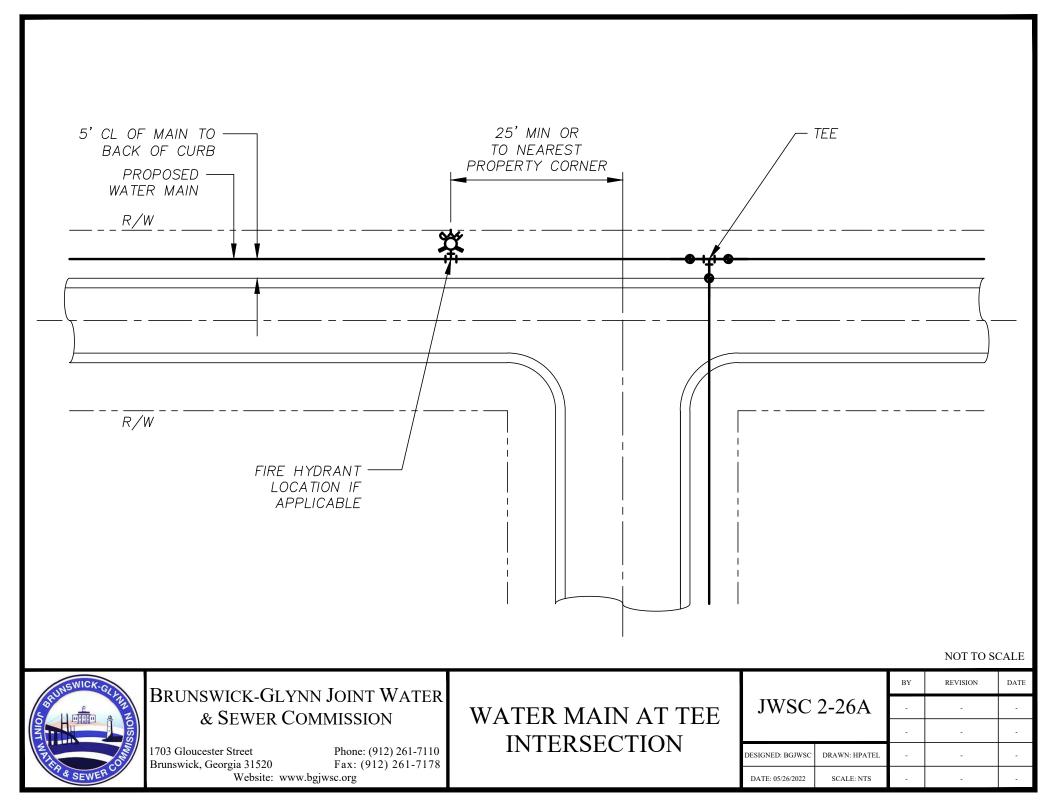


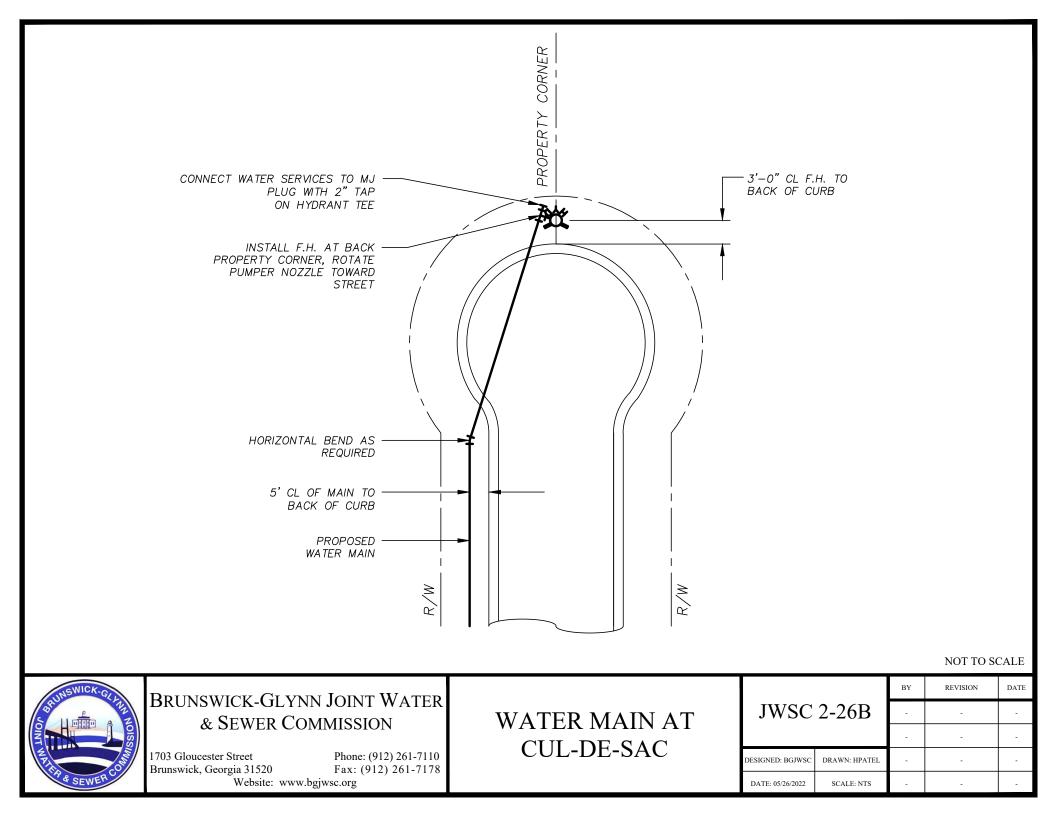


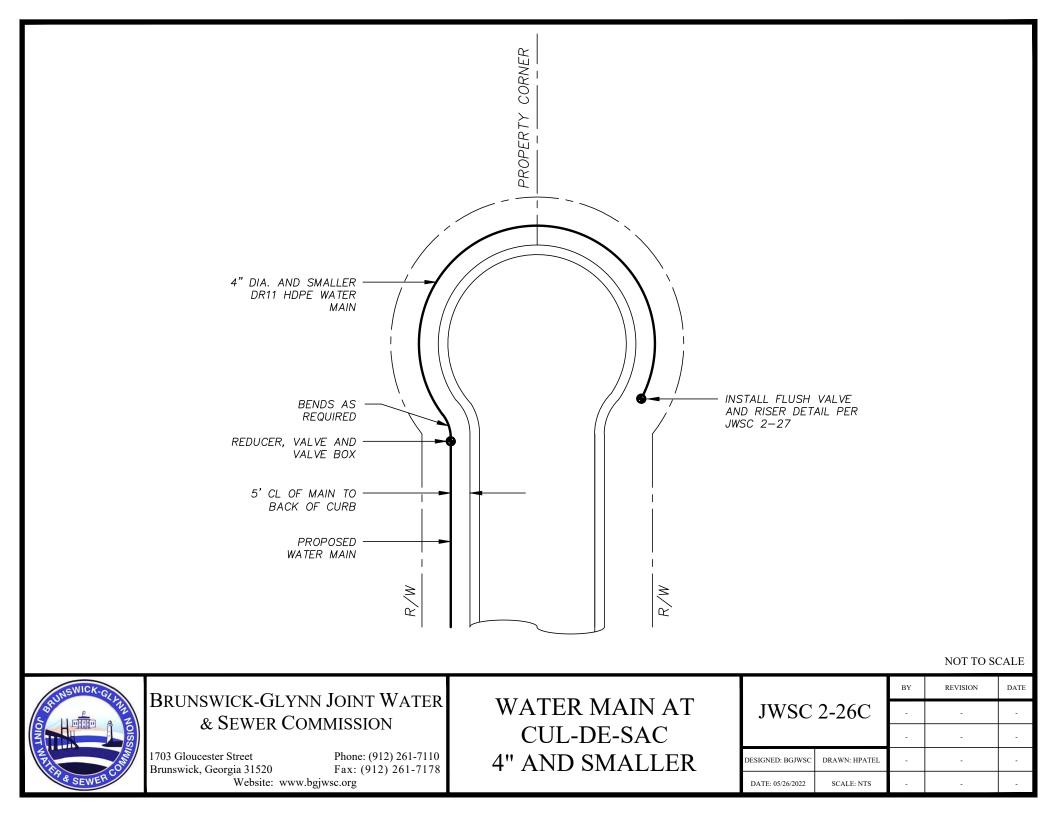


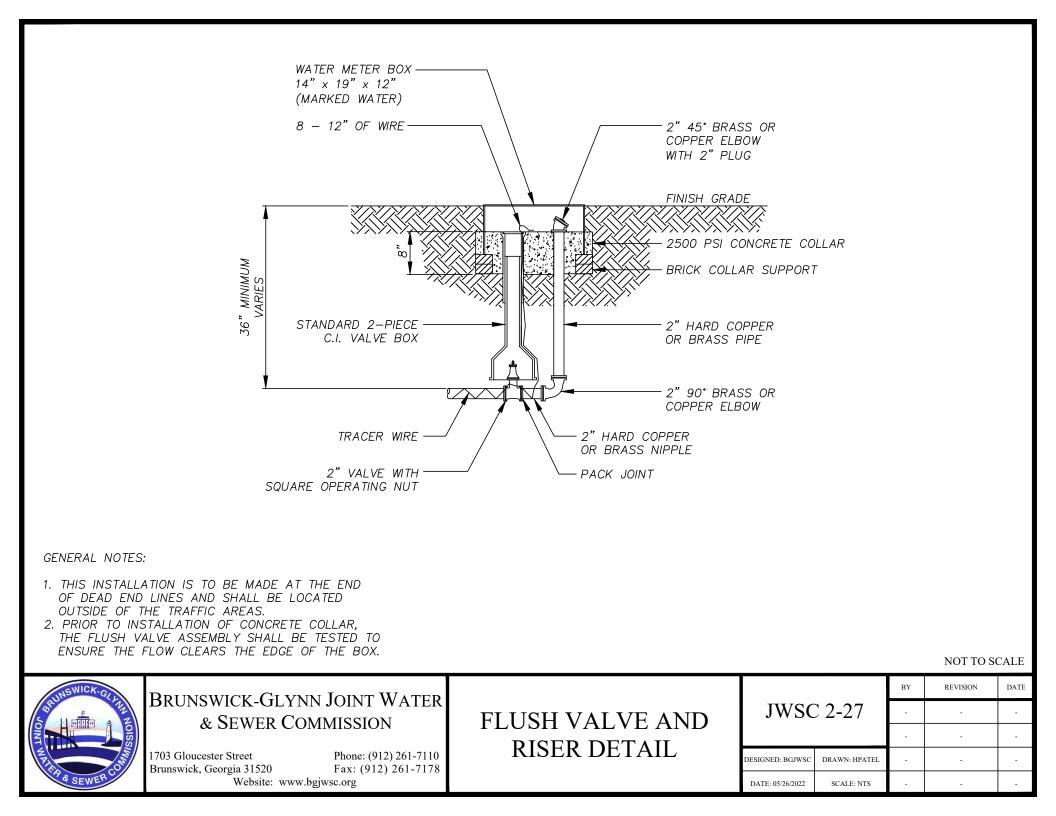


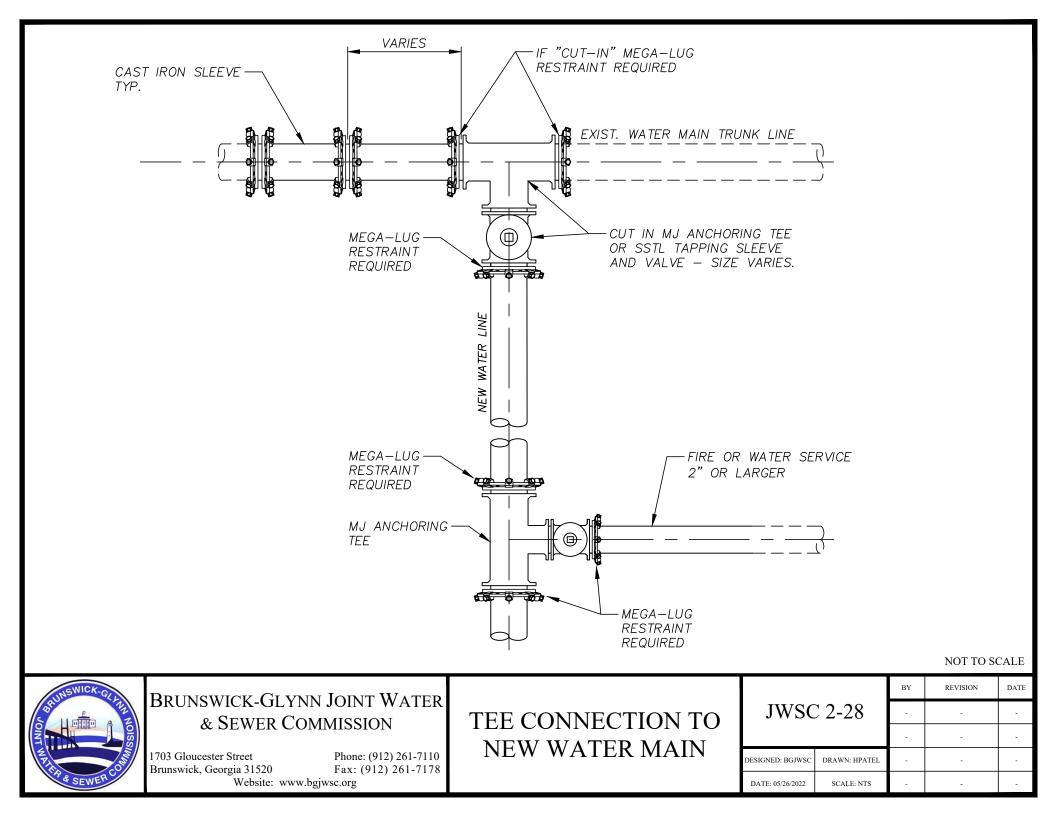


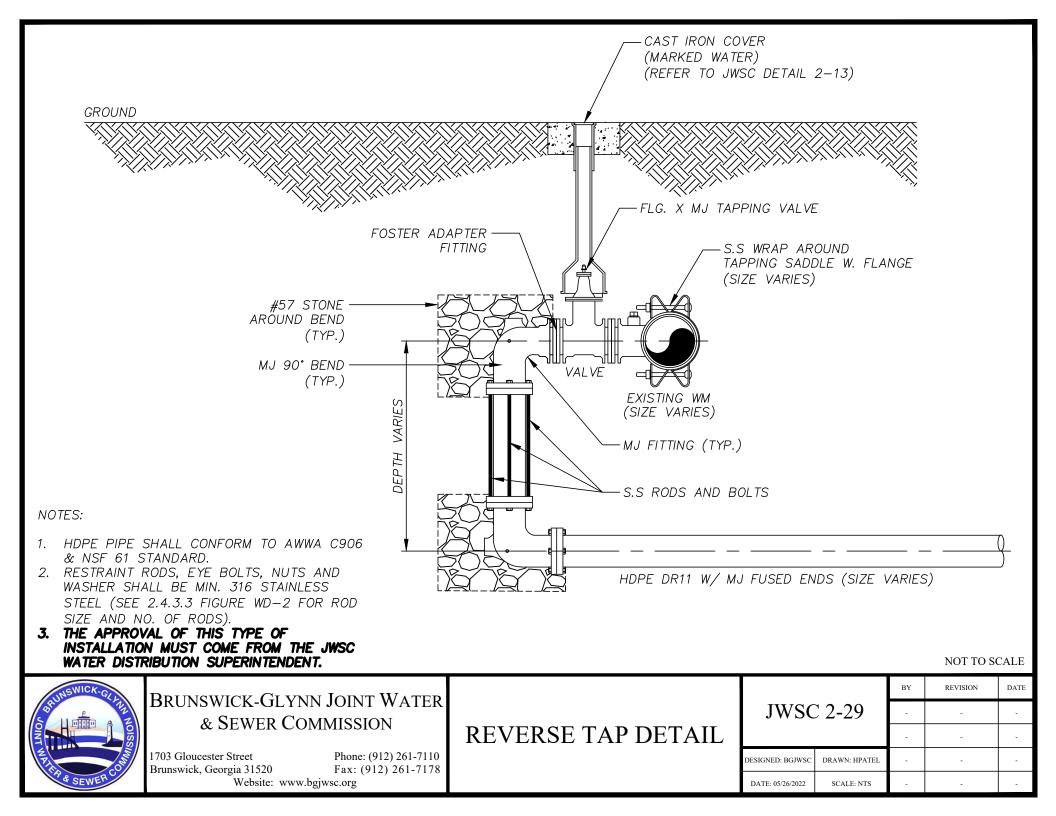


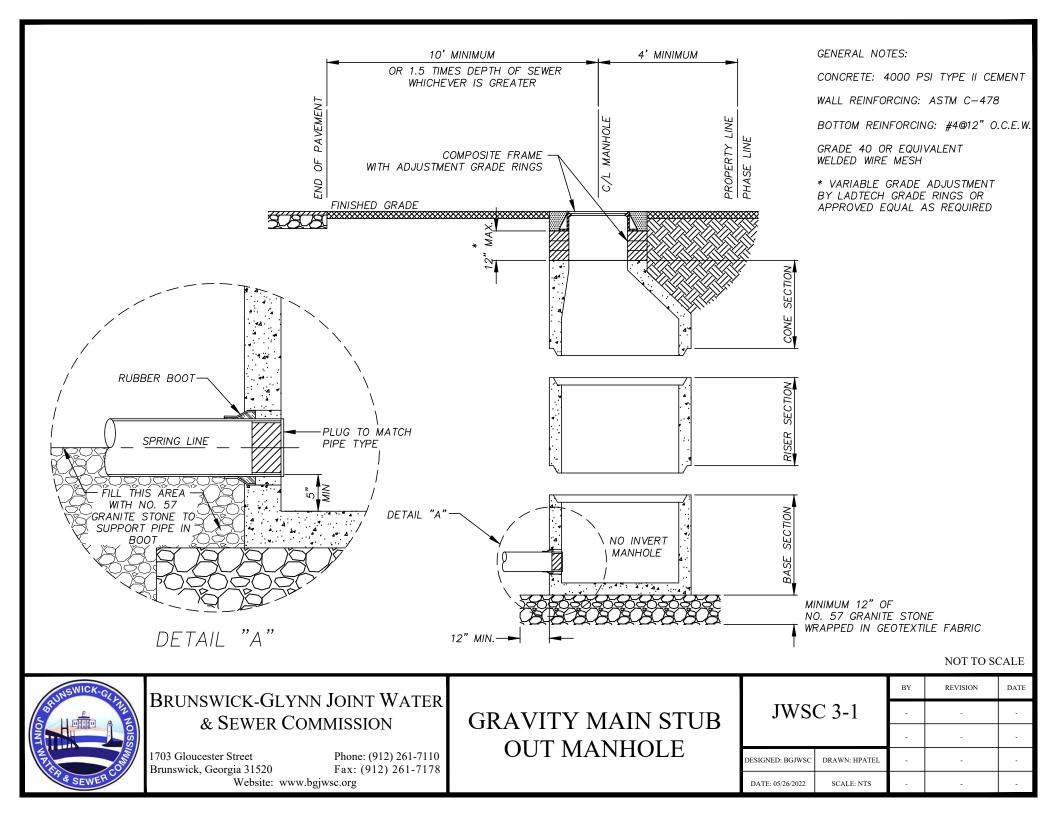

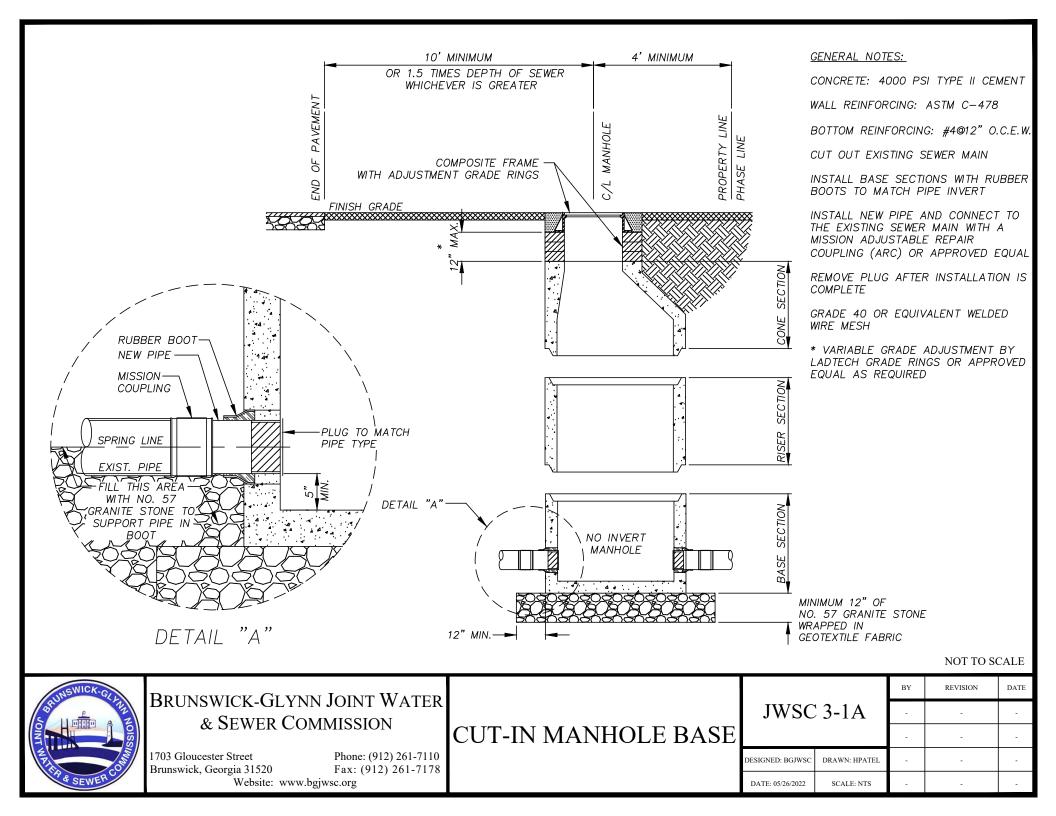

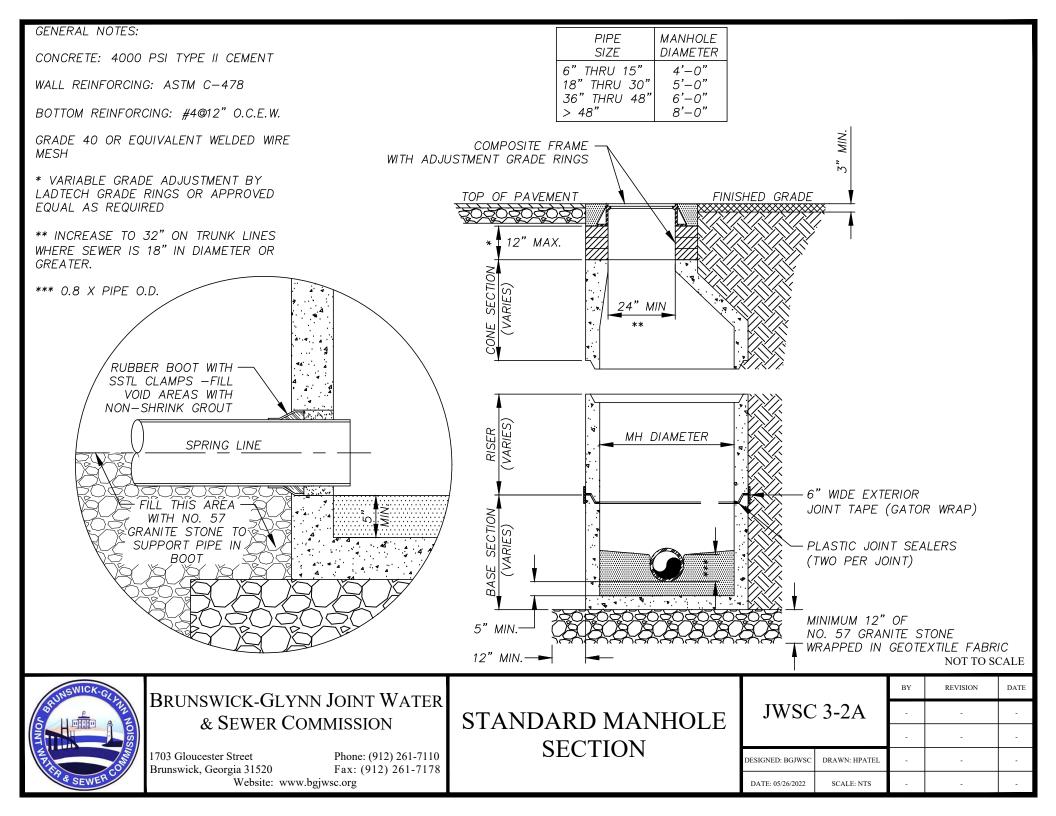

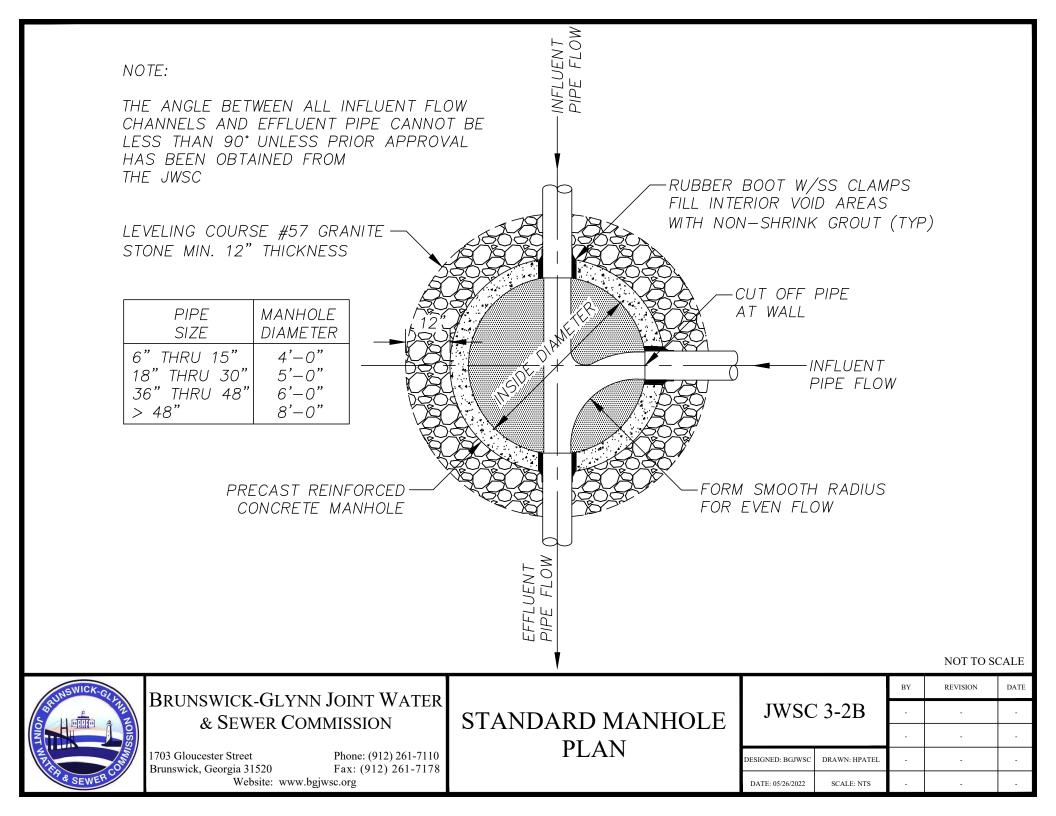

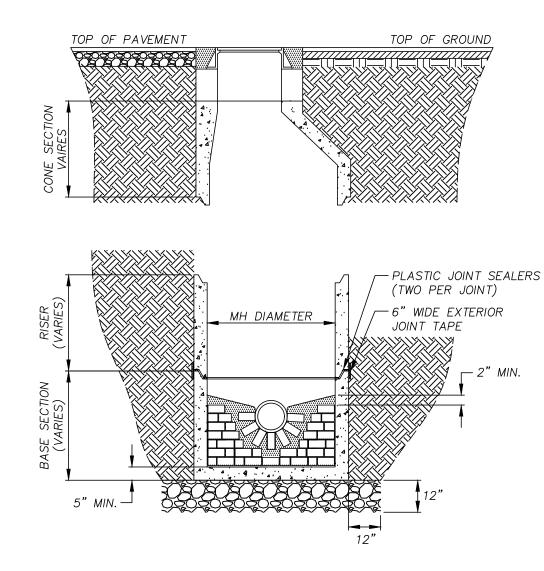

GENERAL NOTES:

CONCRETE USED FOR INVERTS MUST NOT EXCEED 3 PARTS SAND TO 1 PART PORTLAND CEMENT. (MORTAR IS NOT ALLOWED)

PRECAST INVERTS ARE ACCEPTABLE


ENSURE A 0.1 FOOT DROP ACROSS INVERT


INVERTS FOR MANHOLES RECEIVING FORCEMAINS SHALL BE SIMILARLY CONSTRUCTED.


MAXIMUM GROUT SPACING BETWEEN BRICK SHALL BE 3/8"


PIPE SIZE	DEFLECTION	MIN. MH DIA.		
8 INCH & 15 INCH	0° – 90°	4' - 0"		
18 INCH	0° – 60°	4' - 0"		
18 INCH	60° – 90°	5' - 0"		
21 INCH & 24 INCH	0° – 60°	5' – 0"		
21 INCH & 24 INCH	60° – 90°	6' – 0"		


BY REVISION DATE BRUNSWICK-GLYNN JOINT WATER STANDARD MH SECTION JWSC 3-2C -& SEWER COMMISSION BRICK INVERT AND -1703 Gloucester Street Phone: (912) 261-7110 APRON CONSTRUCTION DESIGNED: BGJWS0 DRAWN: HPATEL -Fax: (912) 261-7178 Brunswick, Georgia 31520 Website: www.bgjwsc.org DATE: 05/26/2022 SCALE: NTS

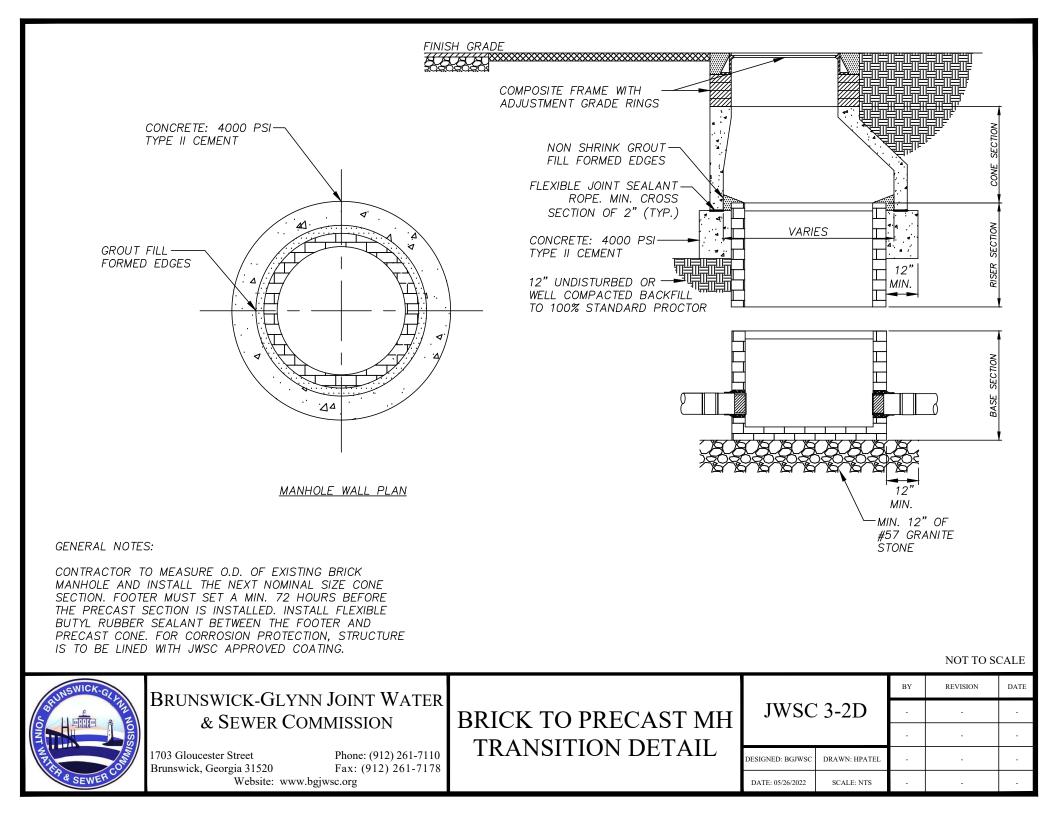


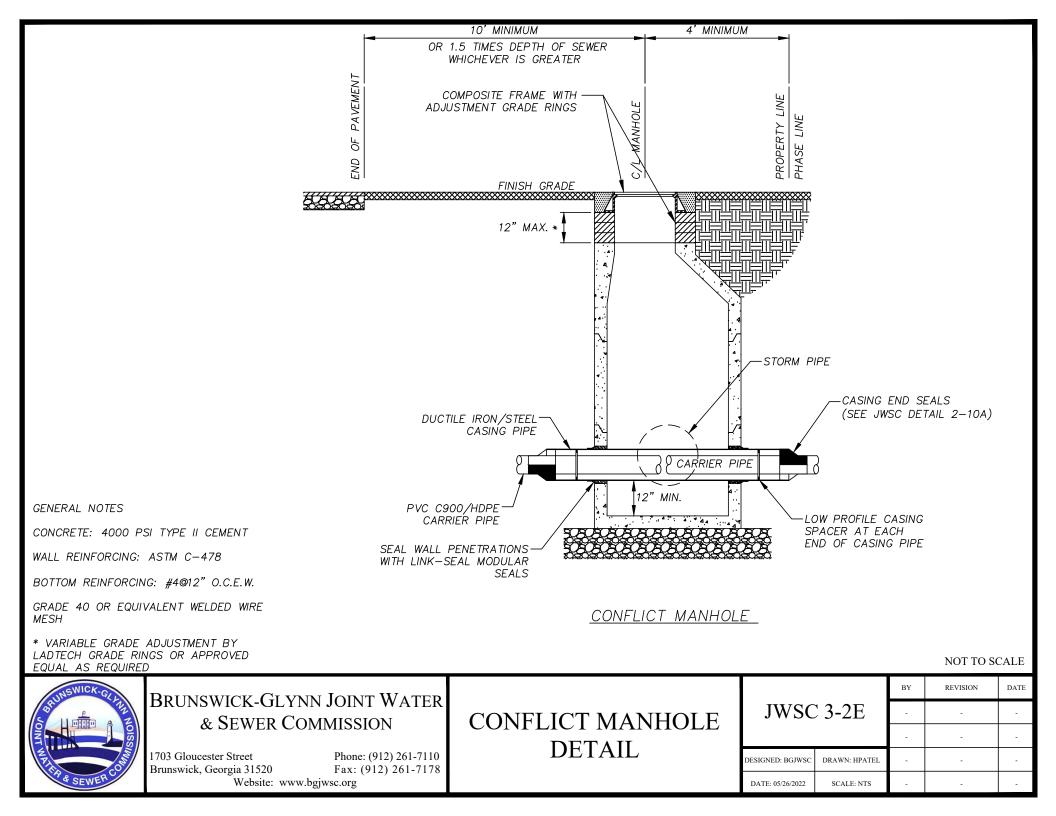


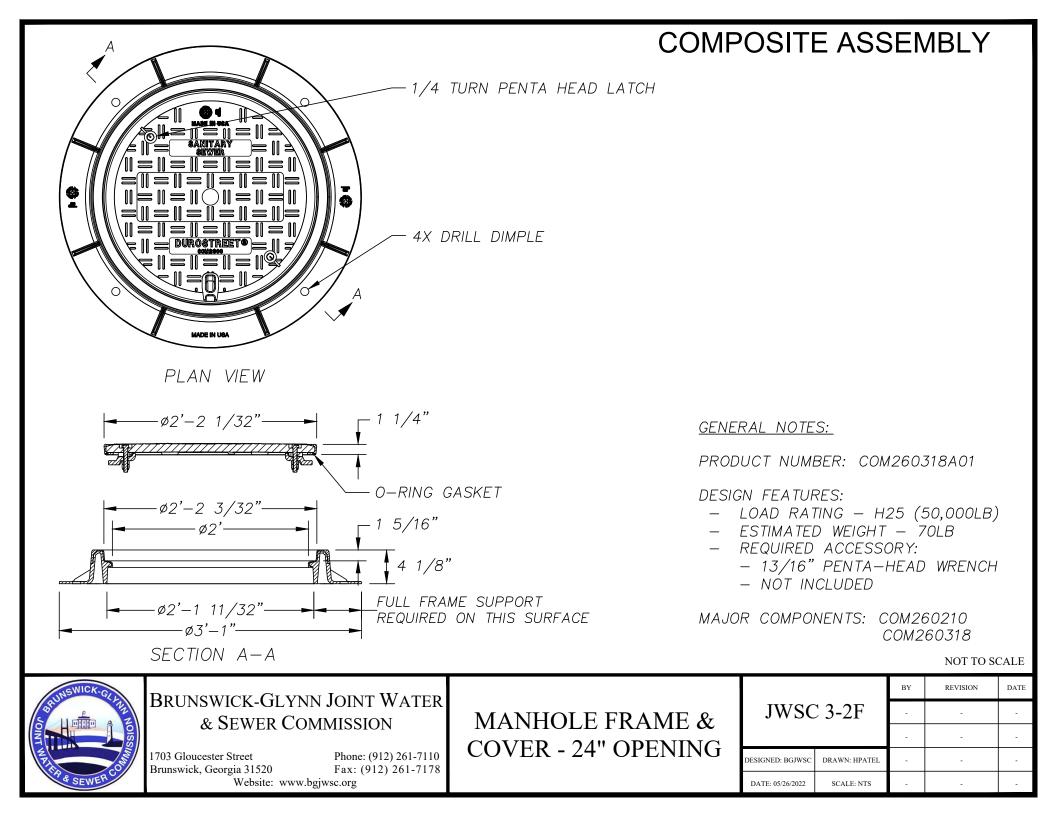


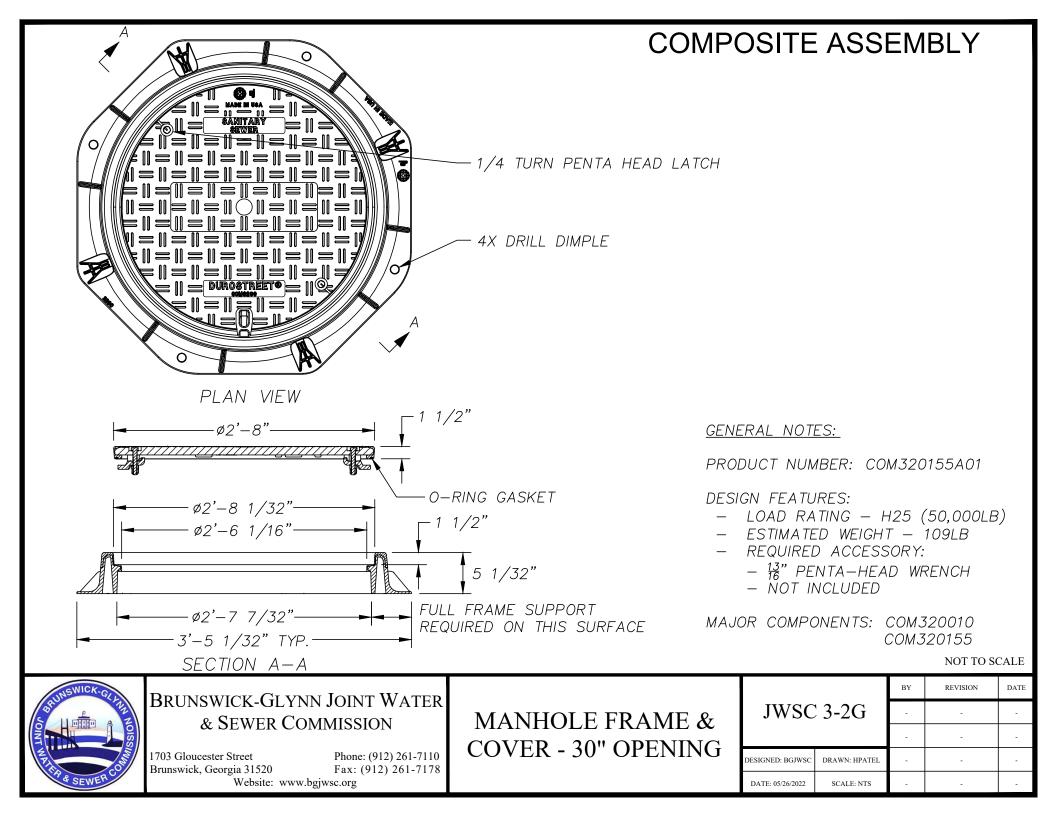


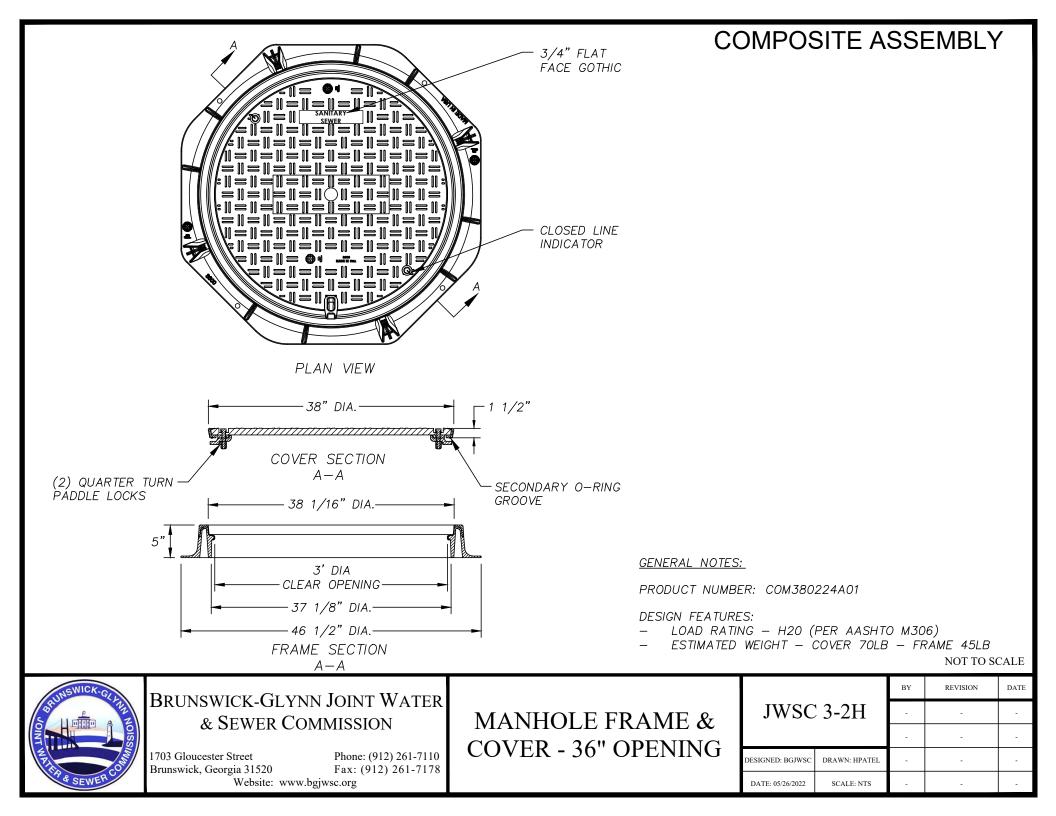

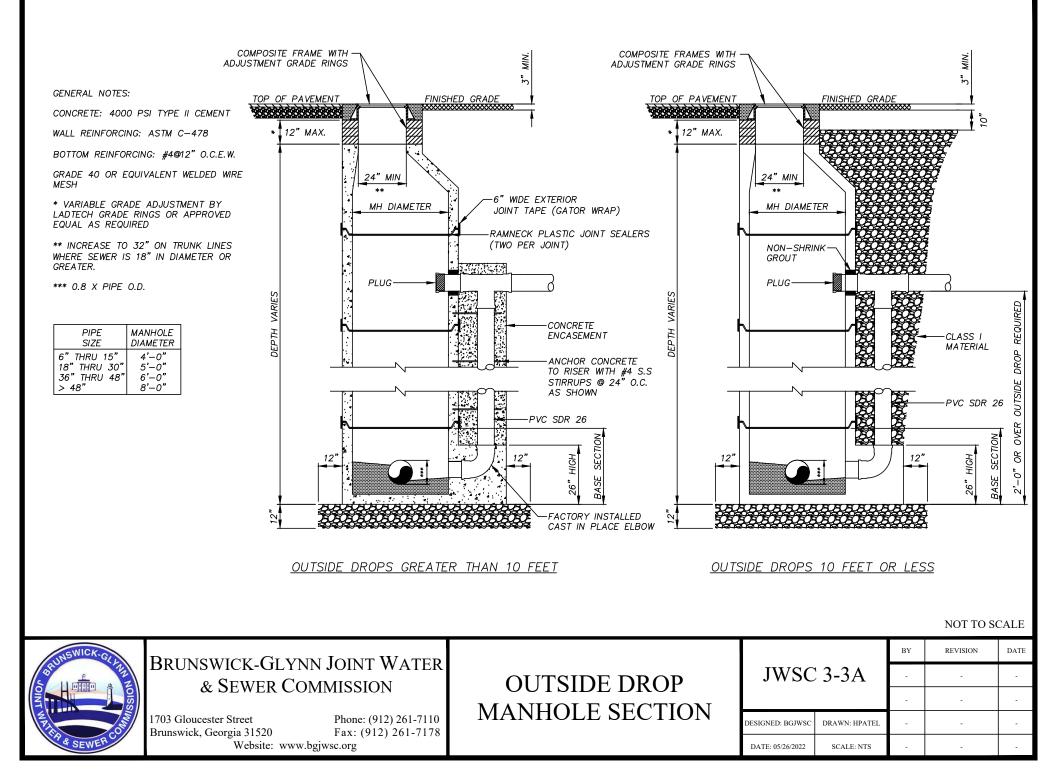

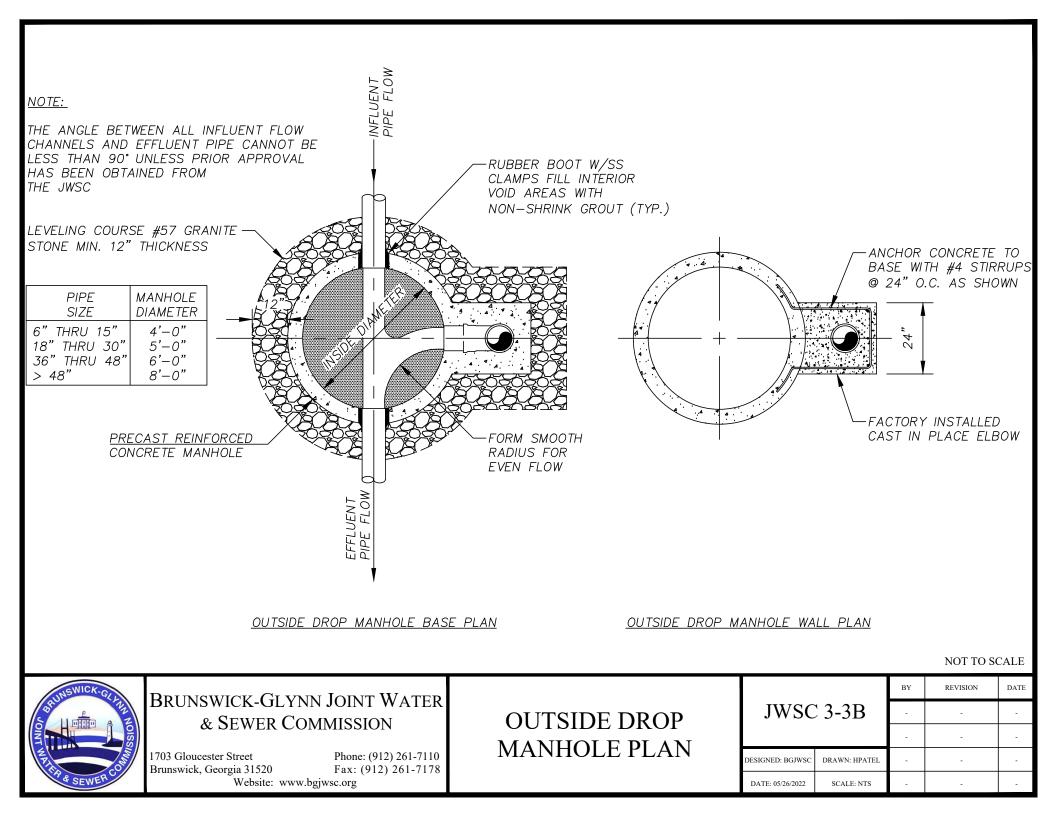


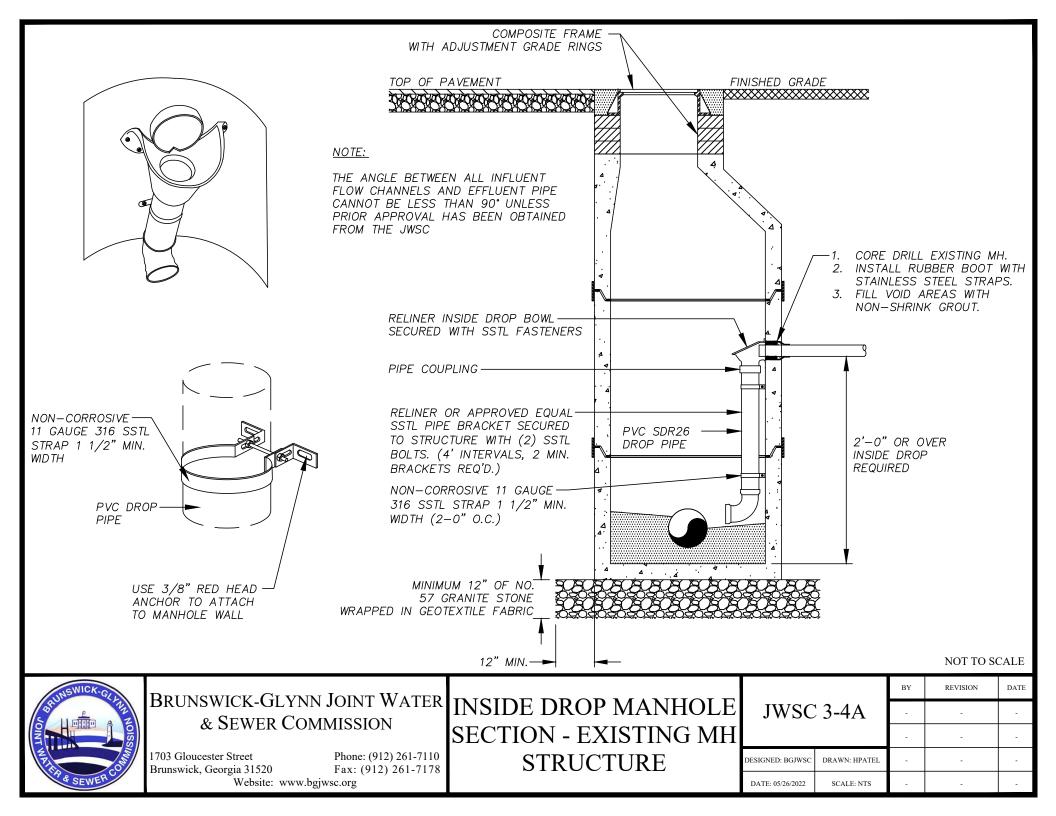


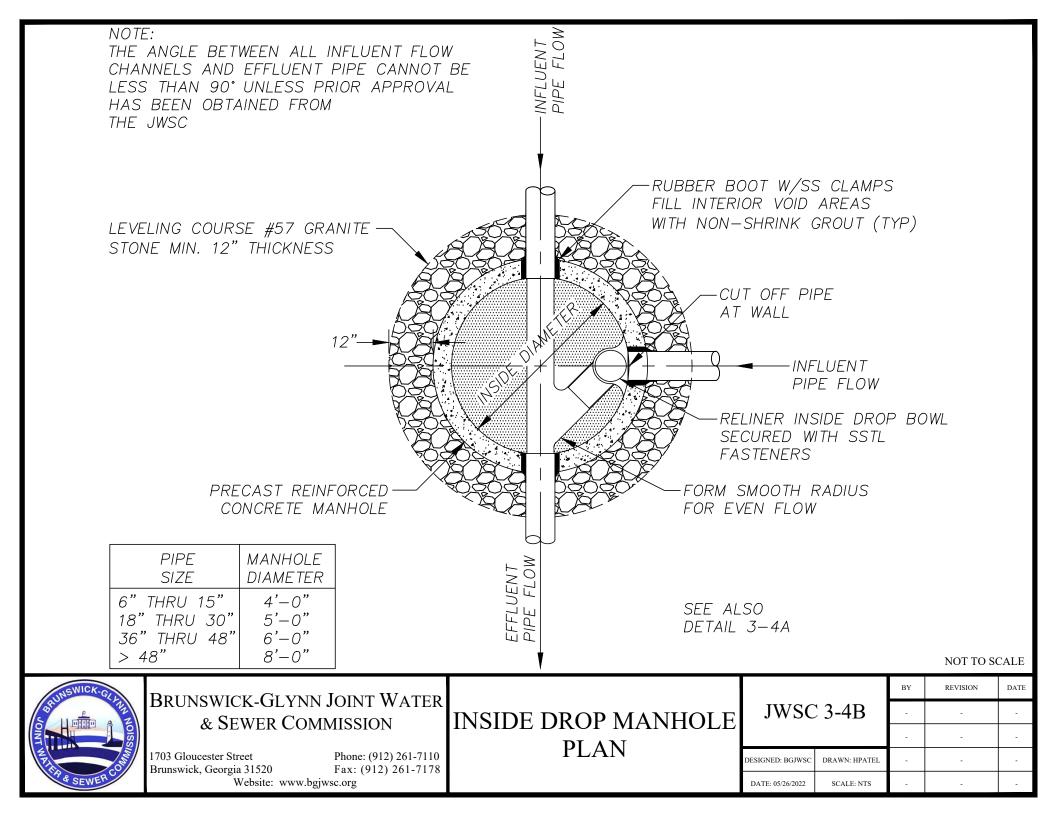



## GENERAL NOTES:


- 1. THE MINIMUM SIZE FOR HOUSE SERVICE LATERALS SHALL BE 4". WHERE DOUBLE SERVICES ARE INSTALLED, A 6" LATERAL SHALL BE USED FROM THE MAIN TO THE PROPERTY LINE. AS DETERMINED BY THE JWSC COMMERCIAL DEVELOPMENTS, SHALL BE REQUIRED TO INSTALL A 6" LATERAL FROM THE MAIN TO THE PROPERTY LINE, RIGHT-OF-WAY OR EASEMENT LINE.
- 2. THE MAXIMUM LENGTH OF A SERVICE LATERAL SHALL NOT EXCEED 60' AS MEASURED FROM THE SEWER MAIN (OR MANHOLE) TO THE PROPERTY LINE.
- 3. THE SEWER SERVICE LATERAL SHALL BE CONSTRUCTED AT A DEPTH TO ALLOW A GRAVITY CONNECTION BY THE CUSTOMER WHERE POSSIBLE. MIN. AND MAX. BURY DEPTHS SHALL COMPLY WITH JWSC SPECIFICATIONS.
- 4. ALL SERVICES SHALL BE RUN PERPENDICULAR TO THE RIGHT-OF-WAY LINE.
- 5. SERVICE CONNECTIONS ARE NOT PERMITTED ON SEWER MAINS OR TRUNK LINES LARGER THAN 15-INCHES IN DIAMETER.
- 6. ALL GRAVITY MAINS AND SEWER SERVICE LATERALS (INCLUDING THE TEE-WYE FITTING) WITH A DEPTH OF CUT SHALL BE NO GREATER GREATER THAN 12 FEET.
- 7. CLEANOUT SHALL BE INSTALLED AT RIGHT-OF-WAY OR EASEMENT LINE UPON CONNECTION OF THE CUSTOMER TO PUBLIC SEWER. SEE CLEANOUT DETAIL FOR ADDITIONAL INFORMATION.
- 8. THE SERVICE LINE DEPTH AT THE RIGHT-OF-WAY OR EASEMENT SHALL HAVE A MINIMUM OF 3'-O" COVER.
- 9. IN LIEU OF SEWER SAFE DIP (PROTECTO 401 COATED OR APPROVED EQUAL) DR18 C900 PVC PIPE MAY BE INSTALLED. FITTINGS SHALL BE DR 18 AS MANUFACTURED BY IPEX OR APPROVED EQUAL. PIPE SHALL BE GREEN IN COLOR.

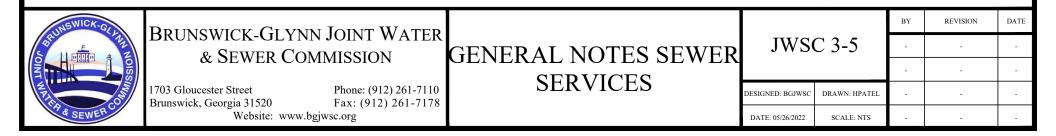


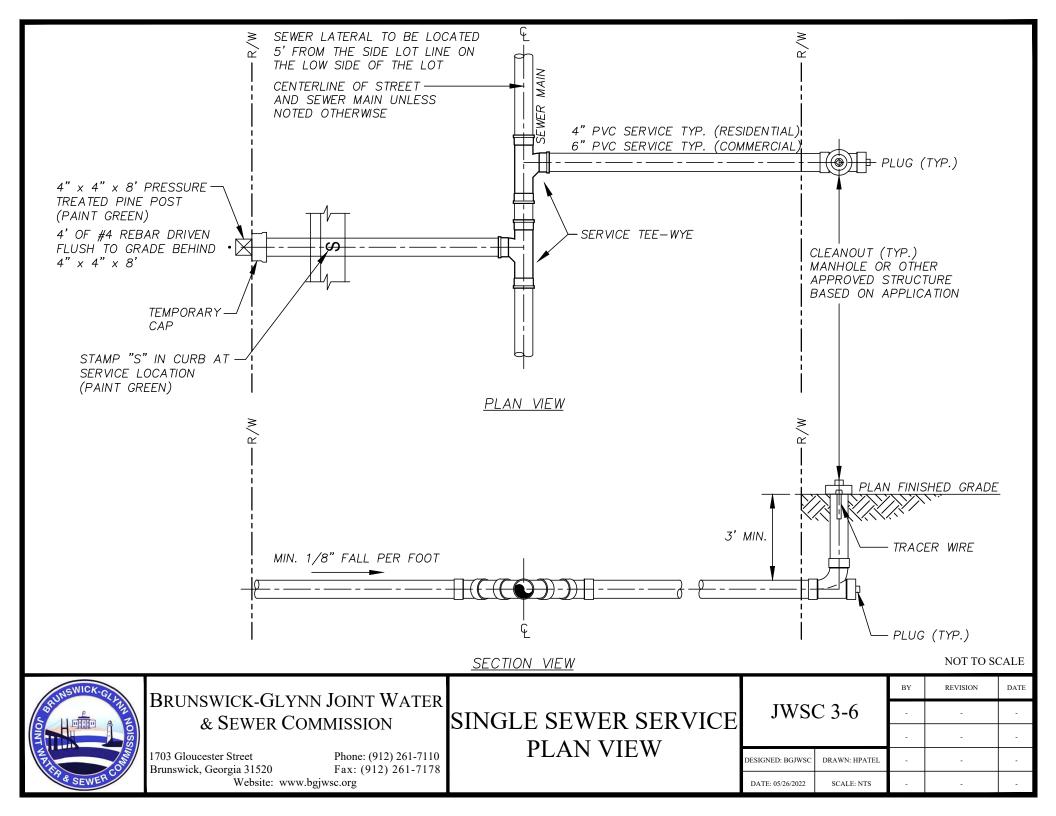


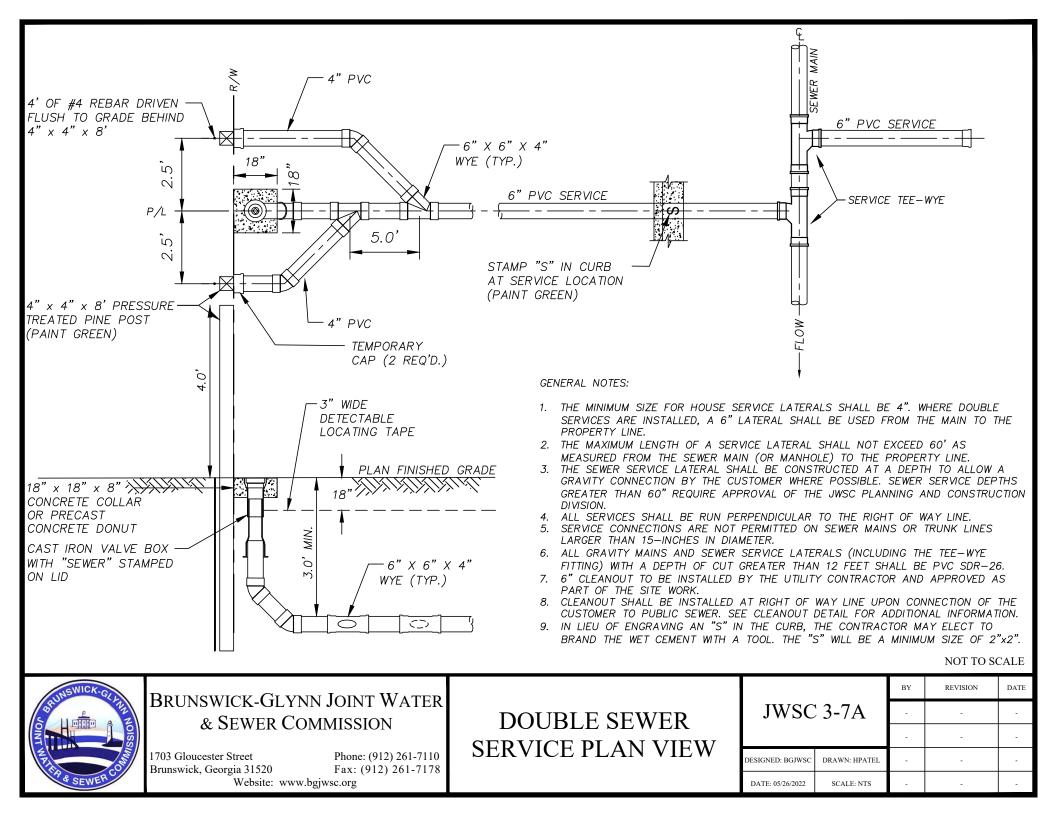

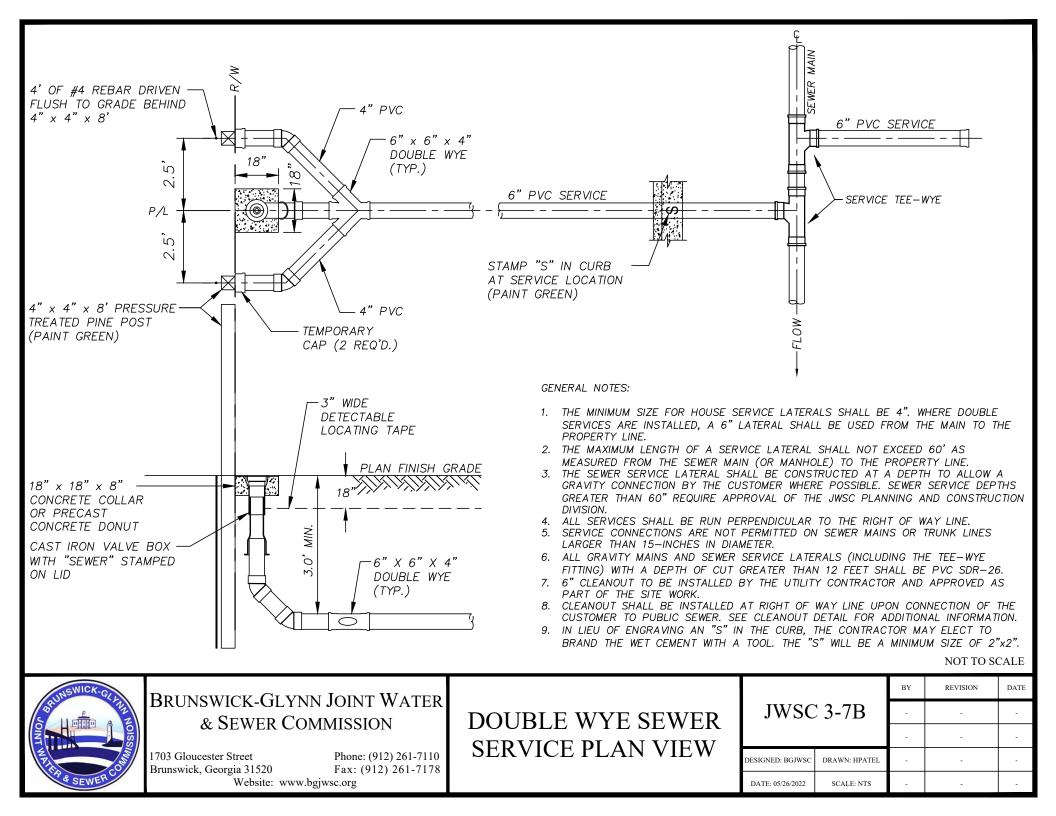

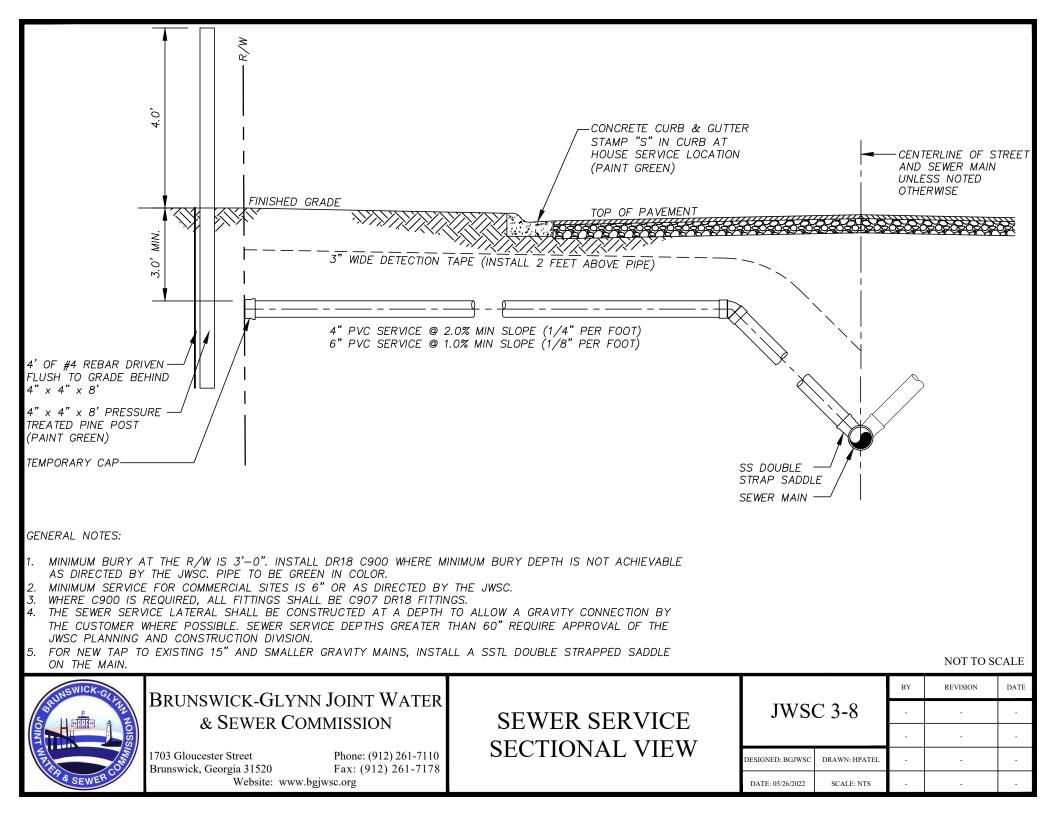

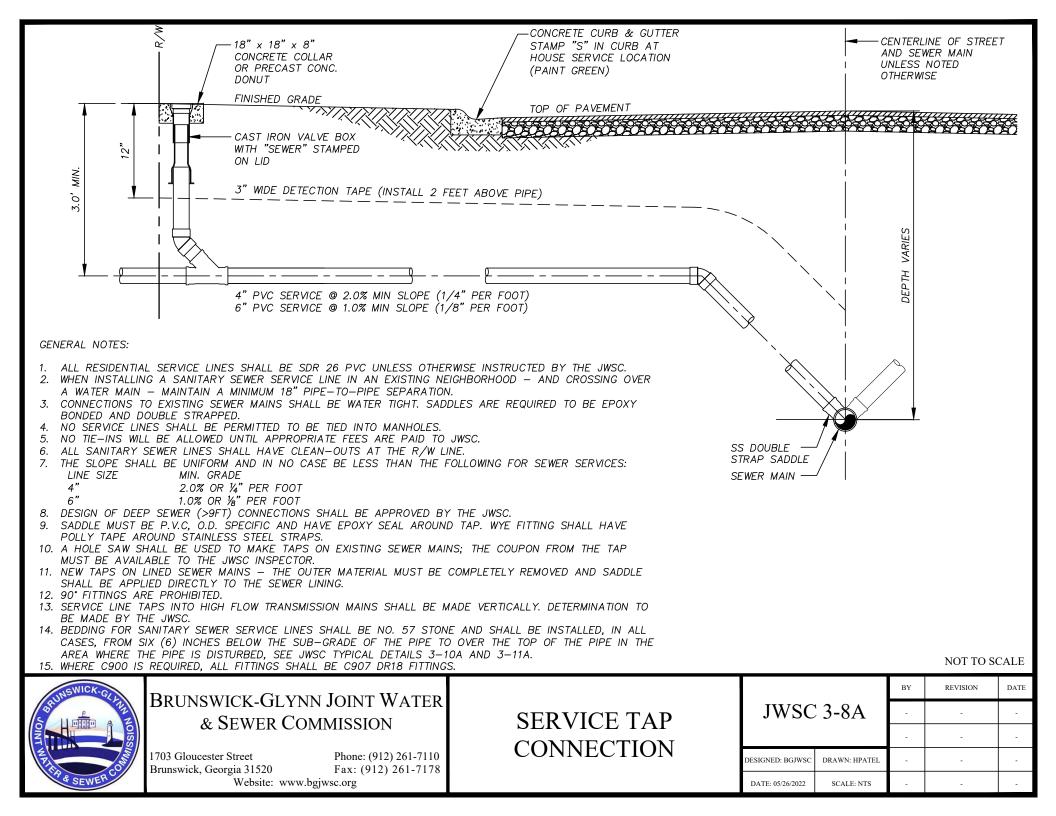


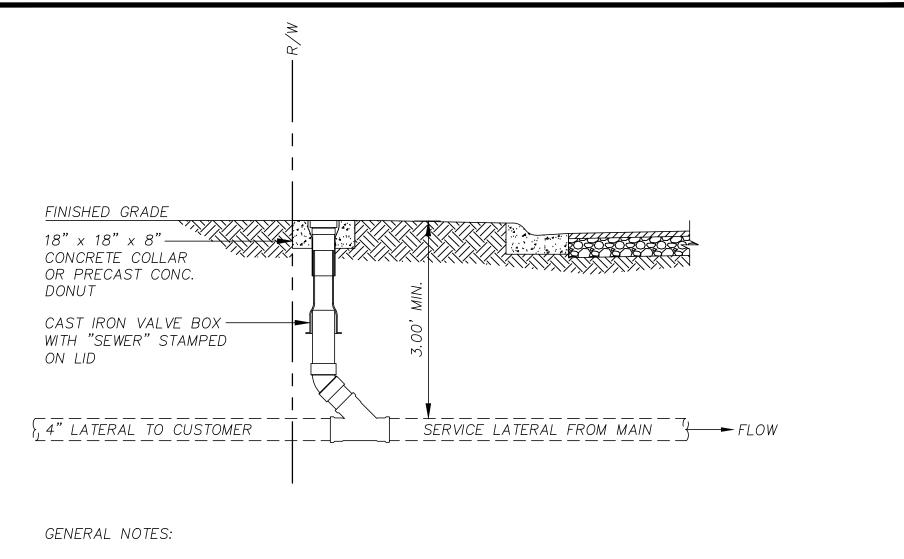


- 1. BOX SHALL BE STAR PIPE PRODUCTS VB562S OR APPROVED EQUAL.
- 2. THE SEWER SERVICE LATERAL SHALL BE CONSTRUCTED AT A DEPTH TO ALLOW A GRAVITY CONNECTION BY THE CUSTOMER WHERE POSSIBLE. SEWER SERVICE DEPTHS GREATER THAN 60" REQUIRE APPROVAL OF THE JWSC PLANNING AND CONSTRUCTION DIVISION.

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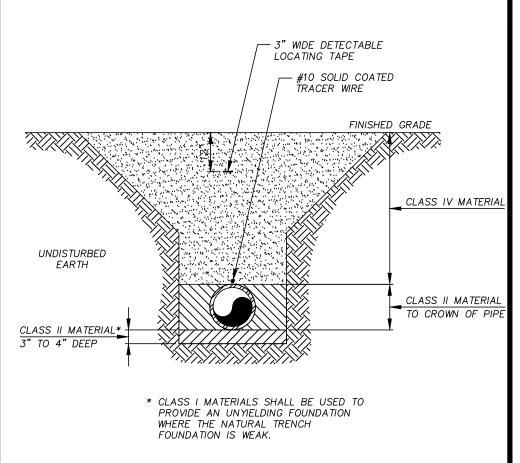


#### GENERAL NOTES:

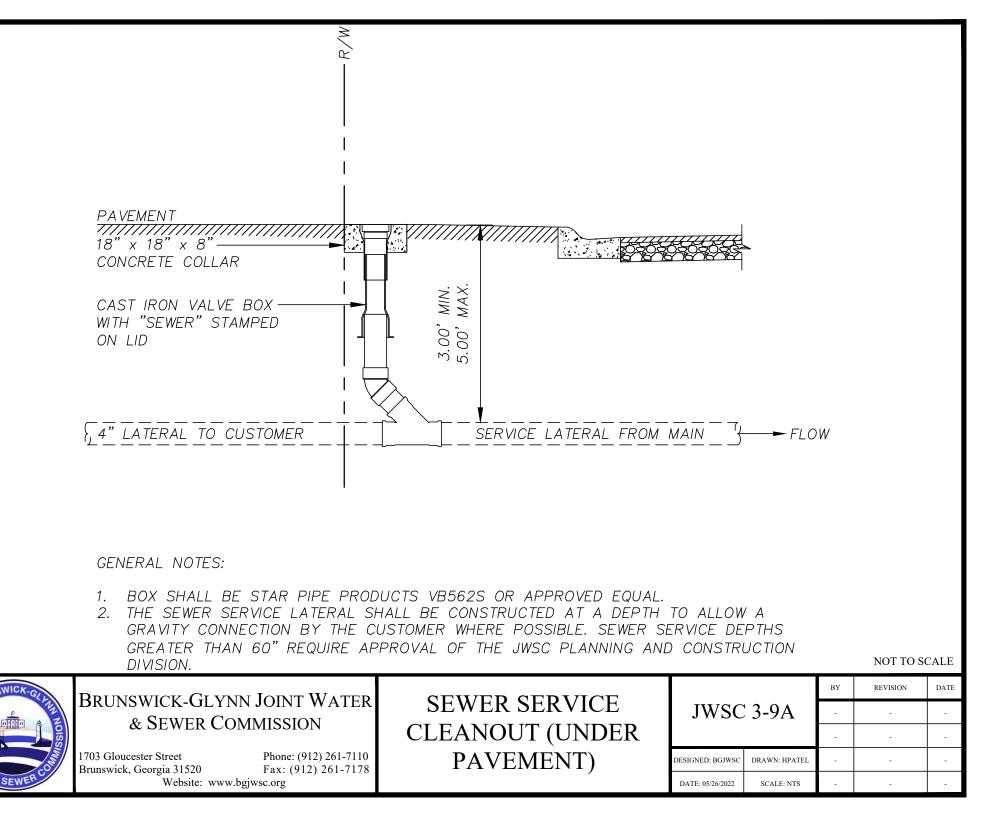- 1. MINIMUM BURY AT THE R/W IS 3'-O". INSTALL DR18 C900 WHERE MINIMUM BURY DEPTH IS NOT ACHIEVABLE AS DIRECTED BY THE JWSC. PIPE TO BE GREEN IN COLOR.
- 2. MINIMUM SERVICE FOR COMMERCIAL SITES IS 6" OR AS DIRECTED BY THE JWSC.
- 3. WHERE C900 IS REQUIRED, ALL FITTINGS SHALL BE C907 DR18 FITTINGS.
- 4. THE SEWER SERVICE LATERAL SHALL BE CONSTRUCTED AT A DEPTH TO ALLOW A GRAVITY CONNECTION BY THE CUSTOMER WHERE POSSIBLE. SEWER SERVICE DEPTHS GREATER THAN 60" REQUIRE APPROVAL OF THE JWSC PLANNING AND CONSTRUCTION DIVISION.
- 5. FOR NEW TAP TO EXISTING 15" AND SMALLER GRAVITY MAINS, INSTALL A SSTL DOUBLE STRAPPED SADDLE ON THE MAIN.

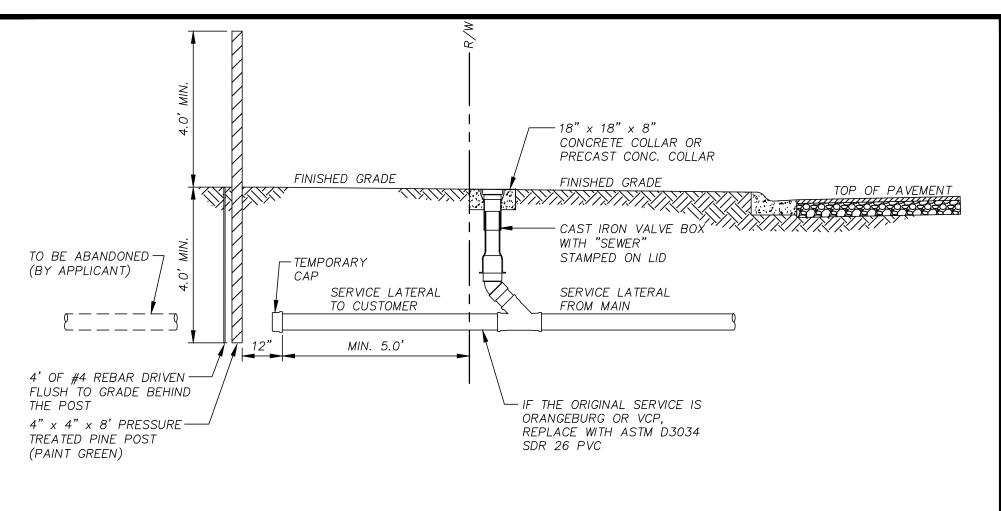BRUNSWICK-GLYNN JOINT WA & SEWER COMMISSION	SEWER SERVICE ABANDONMENT	JWSC	C <b>3-9B</b> DRAWN: HPATEL	BY - -	REVISION - -	DATE
Iswick, Georgia 31520 Fax: (912) 261-7178 Website: www.bgjwsc.org		DESIGNED: BGJWSC DATE: 05/26/2022	DRAWN: HPATEL SCALE: NTS	-	-	-

		PIPE BEDDING MATERIALS			
CLASS	TYPE	DESCRIPTION			
Ι		MANUFACTURED ANGULAR, GRANULAR MATERIAL, 1/4" TO 1 1/2" SIZE, INCLUDING MATERIALS HAVING REGIONAL SIGNIFICANCE SUCH AS CRUSHED STONE OR ROCK			
11	GW	WELL-GRADED GRAVELS AND GRAVEL-SAND MIXTURES, LITTLE OR NO FINES, 50% OR MORE OF COARSE FRACTION RETAINED ON NO. 4 SIEVE. MORE THAN 95% RETAINED ON NO. 200 SIEVE. CLEAN.			
	GP	POORLY GRADED GRAVELS AND GRAVEL–SAND MIXTURES, LITTLE OR NO FINES, 50% OR MORE OF COARSE FRACTION RETAINED ON NO. 4 SIEVE. MORE THAN 95% RETAINED ON NO. 200 SIEVE. CLEAN.			
	SW	WELL–GRADED SANDS AND GRAVELLY SANDS, LITTLE OR NO FINES. MORE THAN 50% OF COARSE FRACTION PASSES NO. 4 SIEVE. MORE THAN 95% RETAINED ON NO. 200 SIEVE. CLEAN.			
	SP	POORLY GRADED SANDS AND GRAVELLY SANDS, LITTLE OR NO FINES. MORE THAN 50% OF COARSE FRACTION PASSES NO. 4 SIEVE. MORE THAN 95% RETAINED ON NO. 200 SIEVE. CLEAN.			
	GM	SILTY GRAVELS, GRAVEL—SAND—SILT MIXTURES, 50% OR MORE OF COARSE FRACTION RETAINED ON NO. 4 SIEVE. MORE THAN 50% RETAINED ON NO. 200 SIEVE.			
	GC	CLAYEY GRAVELS, GRAVEL-SAND-CLAY MIXTURES, 50% OR MORE OF COARSE FRACTION RETAINED ON NO. 4 SIEVE. MORE THAN 50% RETAINED ON NO. 200 SIEVE.			
	SM	SILTY SANDS, SAND–SILT MIXTURES, MORE THAN 50% OF COARSE FRACTION PASSES ON NO. 4 SIEVE. MORE THAN 50% RETAINED ON NO. 200 SIEVE.			
	SC	CLAYEY SANDS, SAND-CLAY MIXTURES, MORE THAN 50% OF COARSE FRACTION PASSES NO. 4 SIEVE. MORE THAN 50% RETAINED ON NO. 200 SIEVE.			
IV	ML	INORGANIC SILTS, VERY FINE SANDS, ROCK FLOUR, SILTY OR CLAYEY FINE SANDS. LIQUID LIMIT 50% OR LESS, 50% OR MORE PASSES NO. 200 SIEVE			
	CL	INORGANIC CLAYS OF LOW TO MEDIUM PLASTICITY, GRAVELLY CLAYS, SANDY CLAYS, SILTY CLAYS, LEAN CLAYS. LIQUID LIMIT 50% OR LESS, 50% OR MORE PASSES NO. 200 SIEVE			
	МН	INORGANIC SILTS, MICACEOUS OR DIATOMACEOUS FINE SANDS OR SILTS, ELASTIC SILTS. LIQUID LIMIT GREATER THAN 50%, 50% OR MORE PASSES NO. 200 SIEVE.			
	СН	INORGANIC CLAYS OF HIGH PLASTICITY, FAT CLAYS. LIQUID LIMIT GREATER THAN 50%, 50% OR MORE PASSES NO. 200 SIEVE.			





# & SEWER COMMISSION

Phone: (912) 261-7110 Fax: (912) 261-7178 Website: www.bgjwsc.org

# TRENCH DETAIL (NON-TRAFFIC AREAS)

JWSC 3-10		BY	REVISION	DATE
		-	-	-
		-	-	-
DESIGNED: BGJWSC	DRAWN: HPATEL	-	-	-
DATE: 05/26/2022	SCALE: NTS	-	-	-

#### ROAD REPAIR REQUIREMENTS:

1. JWSC MUST REVIEW ROAD CUT AND APPROVE FINAL DIMENSIONS OF AREA TO BE PAVED PRIOR TO FINAL PAVING. ALL ROAD CUTS MUST BE NEATLY SQUARE CUT AND PERPENDICULAR TO THE LINES AND GENERAL DIRECTION OF THE ROAD WAY AND A MINIMUM OF 12" BEYOND FINAL DISTURBED AREA. ENTIRE WIDTH OF LANE IS TO BE REPAVED FOR ROAD CUTS THAT ARE UP TO OR EXCEED HALF THE DISTANCE OF THE LANE. ENTIRE WIDTH OF ROAD IS TO BE REPAVED FOR ROAD CUTS THAT ARE UP TO OR EXCEED HALF THE DISTANCE OF THE ROAD. ROAD MUST BE REPAIRED AS OUTLINED BELOW PER THE STANDARD JWSC ROAD REPAIR DETAIL WITHIN 30 DAYS AFTER ROAD IS CUT INCLUDING ANY APPLICABLE ROAD STRIPING. COMPACTION TEST IS REQUIRED TO ENSURE 100% COMPACTION OF BACKFILL AND BASE MATERIAL. COMPACTION TEST AND BASE MATERIAL.

2. CUTS EXCEEDING 150 FEET IN LENGTH, THE BASE MATERIAL SHALL BE BROUGHT FLUSH TO THE BOTTOM OF THE EXISTING PAVEMENT, EXISTING PAVEMENT SHALL BE SAW CUT TO A STRAIGHT EDGE AND THE ENTIRE WIDTH OF THE ROADWAY RESURFACED WITH A MINIMUM OF 1" OF TYPE "E" ASPHALT TOPPING.


3. DEPENDING ON THE EXISTING ROAD CONDITION, TIE IN POINTS MAY REQUIRE ADDITIONAL MILLING AND BLENDING AS DETERMINED BY JWSC.

4. DEPENDING ON THE EXISTING ROAD CONDITION AND LOCATION OF THE ROAD CUT, FLOWABLE FILL MAY BE REQUIRED AS BACKFILL MATERIAL. TO BE DETERMINED BY JWSC. SURFACE COURSE: ASPHALTIC CONCRETE "E" WITH TACK APPLIED WHERE APPLICABLE. DEPTH TO BE DETERMINED DURING PERMIT PROCESS. BACKFILL: SHALL BE PLACED IN LIFTS -NOTE: CONCRETE MATERIALS SHALL NOT EXCEEDING 12 INCHES IN THICKNESS NOT BE USED ON ASPHALT ROADS AND COMPACTED TO 100% STANDARD PROCTOR. BASE: 10 INCHES OF LIMEROCK OR-GAB COMPACTED TO 100% STANDARD PROCTOR. EXISTING ASPHALT 8888888 JOINTS TO EXISTING BASE BE SAW CUT AAAAAAA 12" MIN. 12" MIN. 3" WIDE DETECTABLE LOCATING TAPE ES UNDISTURBED #10 SOLID COATED TRACER WIRE EARTH 12" MIN. -12" MIN. -VARIES

NOTE:

IF THE EXISTING ROAD SURFACE HAS IRREGULARITIES ON EITHER SIDE OF THE PROPOSED STREET CUT AN ASPHALT OVERLAY MAY BE REQUIRED TO MAKE A SMOOTH RIDING SURFACE. ALL IRREGULARITIES IN EXCESS OF 3/16 INCH IN TEN FEET SHALL BE CORRECTED.

#### BY REVISION DATE **BRUNSWICK-GLYNN JOINT WATER JWSC 3-11** TRENCH DETAIL -& SEWER COMMISSION (TRAFFIC AREAS) 1703 Gloucester Street Phone: (912) 261-7110 DESIGNED: BGJWSC DRAWN: HPATEL -Brunswick, Georgia 31520 Fax: (912) 261-7178 Website: www.bgjwsc.org SEV DATE: 05/26/2022 SCALE: NTS

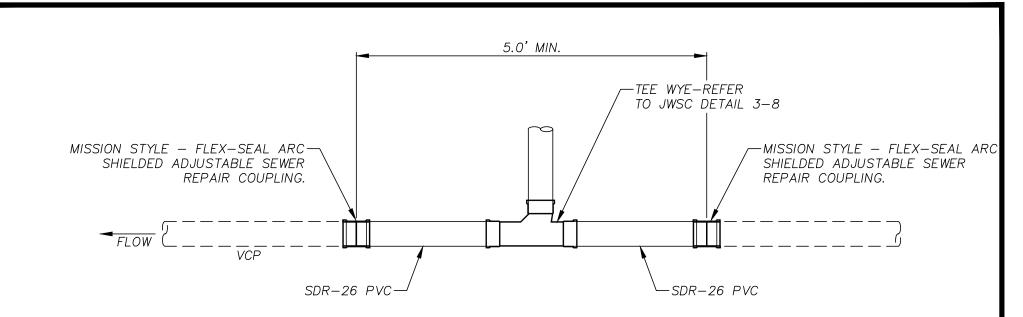


#### NOTES:

- 1. CONTRACTOR TO CUT AND REMOVE A MIN 5.0' SECTION OF THE EXISTING VCP. THE CONTRACTOR MEASURES AND MARKS WHERE THE PIPE NEEDS TO BE CUT. THE CONTRACTOR WILL UTILIZE A RECIPROCATING SAW, HACK SAW, SNAP CUTTER OR ANGLE GRINDER TO ACCOMPLISH THE CUT.
- 2. CONTRACTOR TO COORDINATE PLUGGING OF ACTIVE SEWER MAINS WITH THE UTILITY INSPECTOR AND SYSTEM PUMPING AND MAINTENANCE. IN SOME CASES A BY-PASS MAY BE REQUIRED.
- 3. WASTEWATER DISCHARGING INTO THE TRENCH WILL BE COLLECTED BY A VAC-CON STYLE TRUCK AND DISCHARGED AT A JWSC WASTEWATER POLLUTION CONTROL PLANT.


& SEWER COMMISSION


Website: www.bgjwsc.org

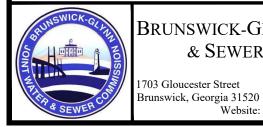



### BRUNSWICK-GLYNN JOINT WATER SEWER TAP ON **EXISTING VCP** Phone: (912) 261-7110 Fax: (912) 261-7178


#### BY REVISION DATE **JWSC 3-12** ---DESIGNED: BGJWSC DRAWN: HPATEL -DATE: 05/26/2022 SCALE: NTS

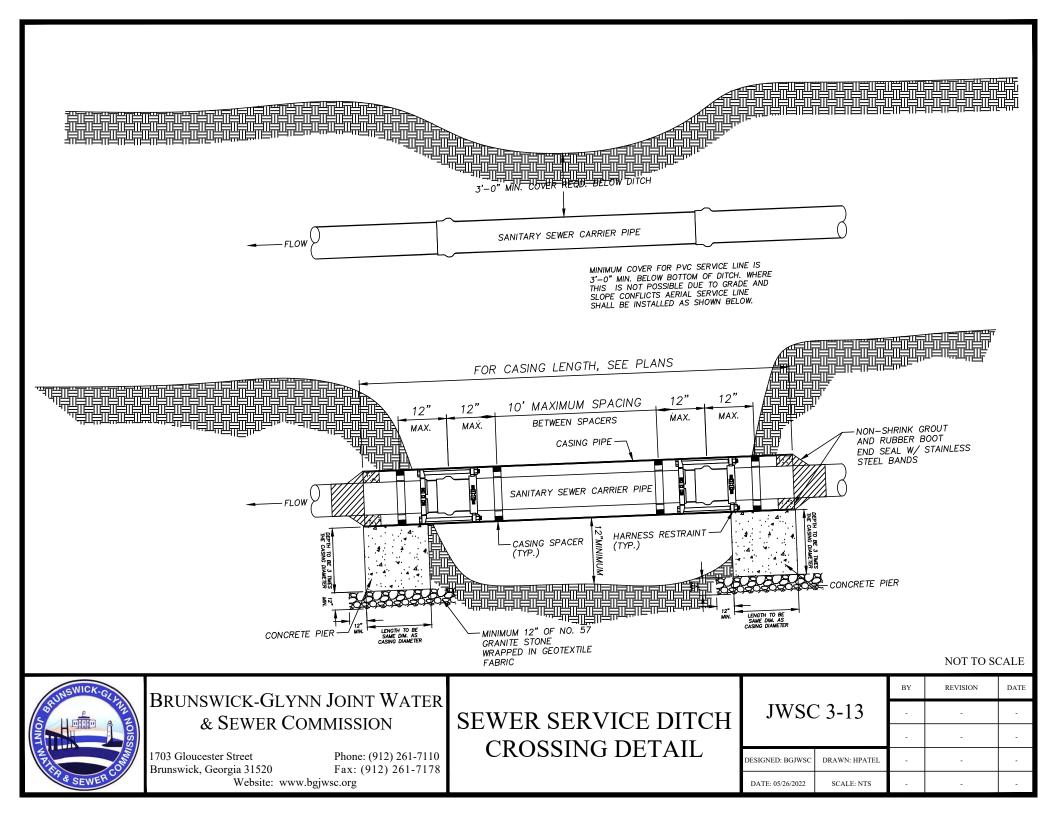


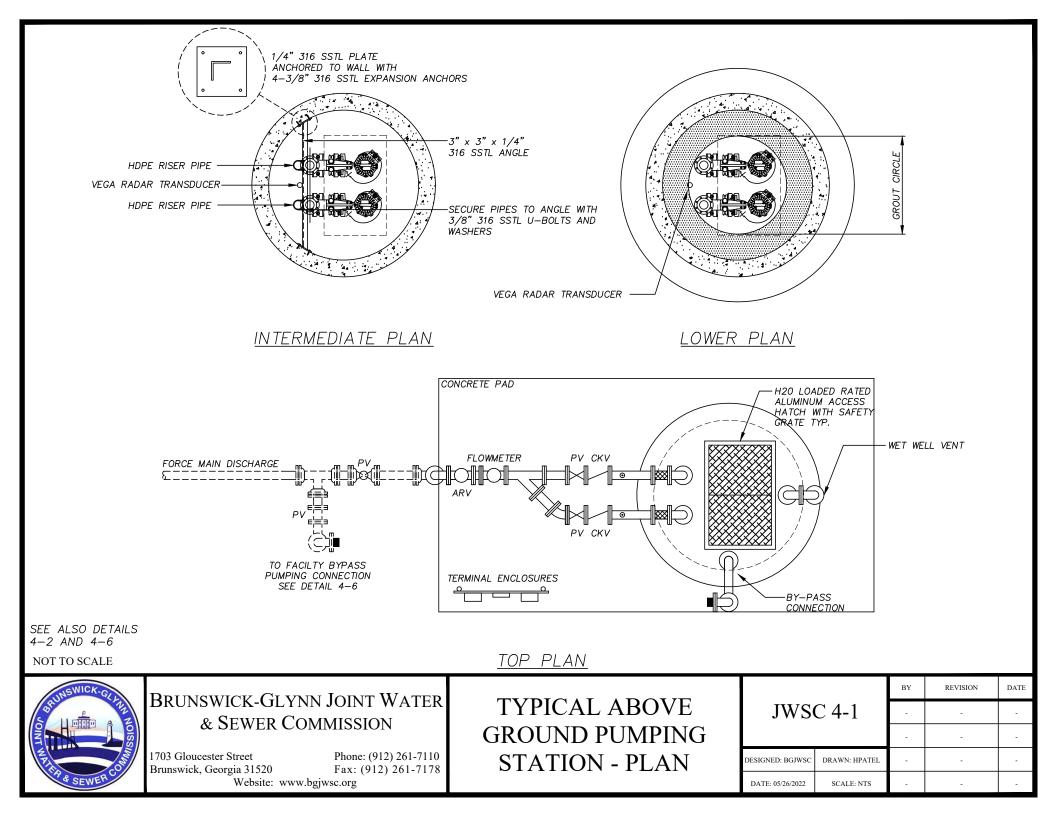


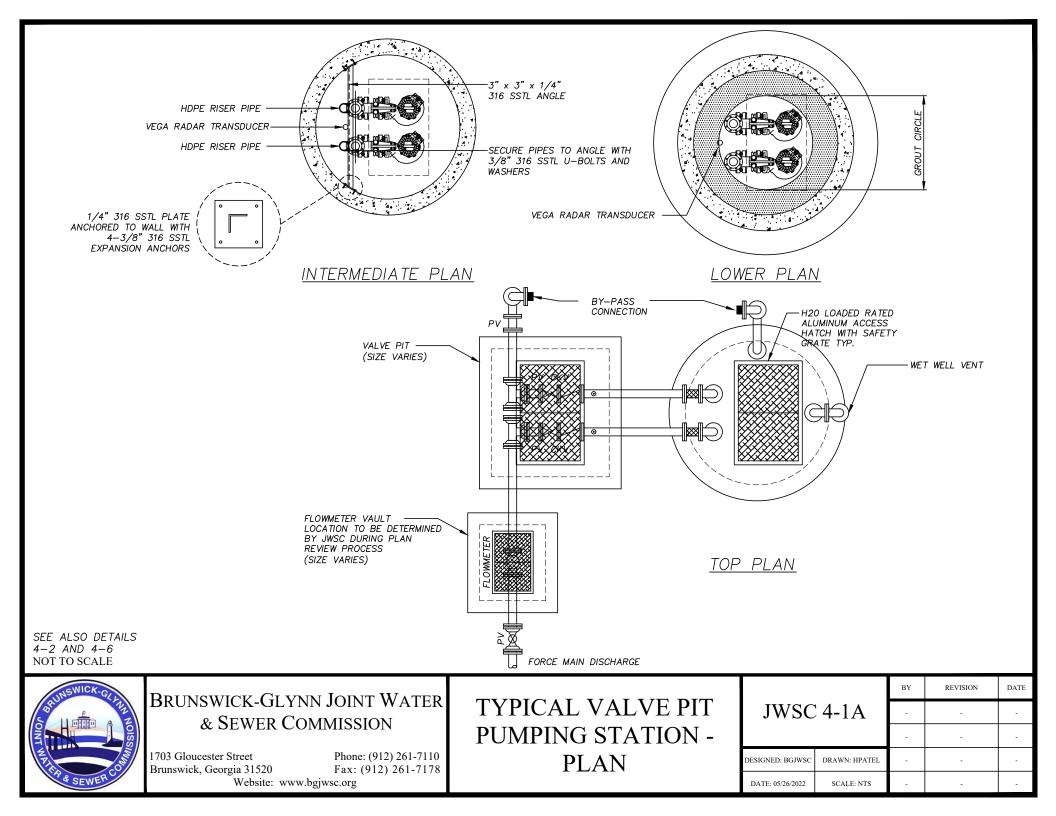


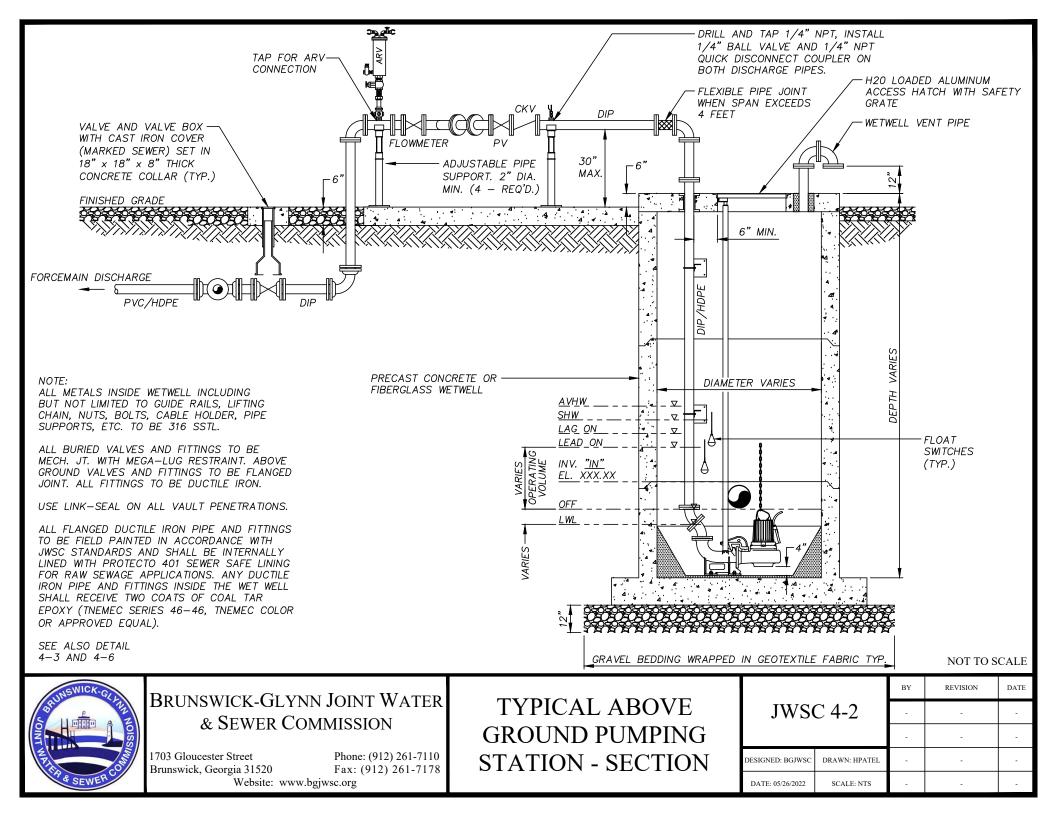


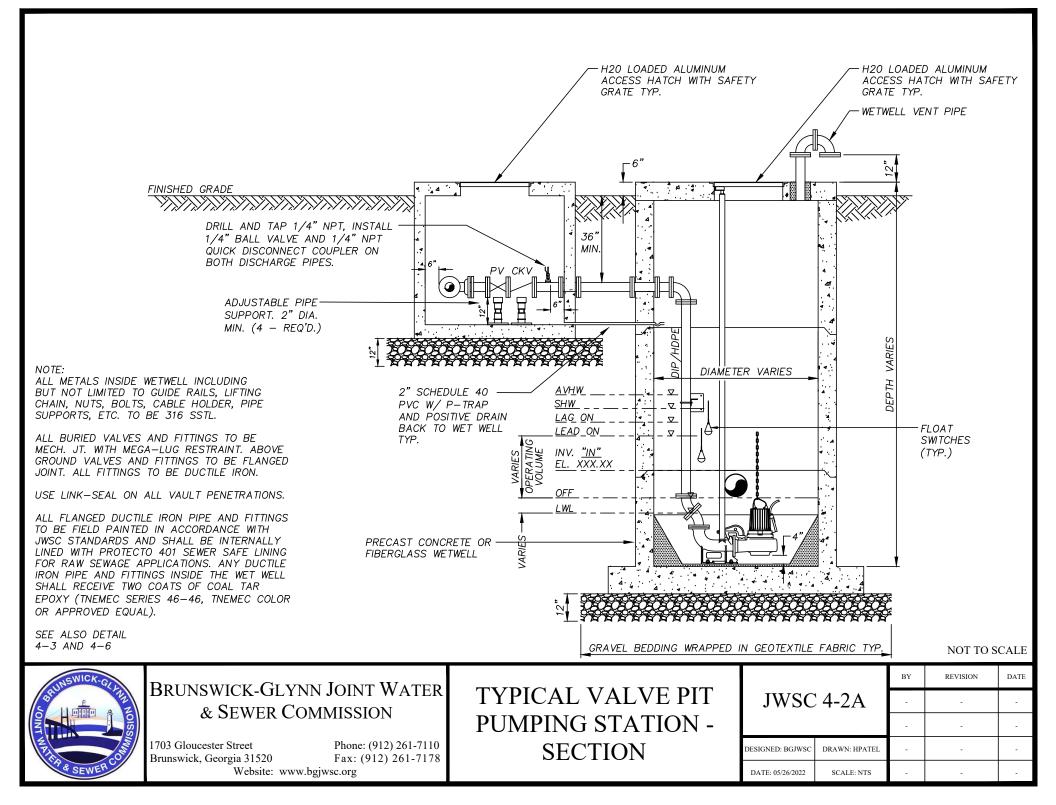


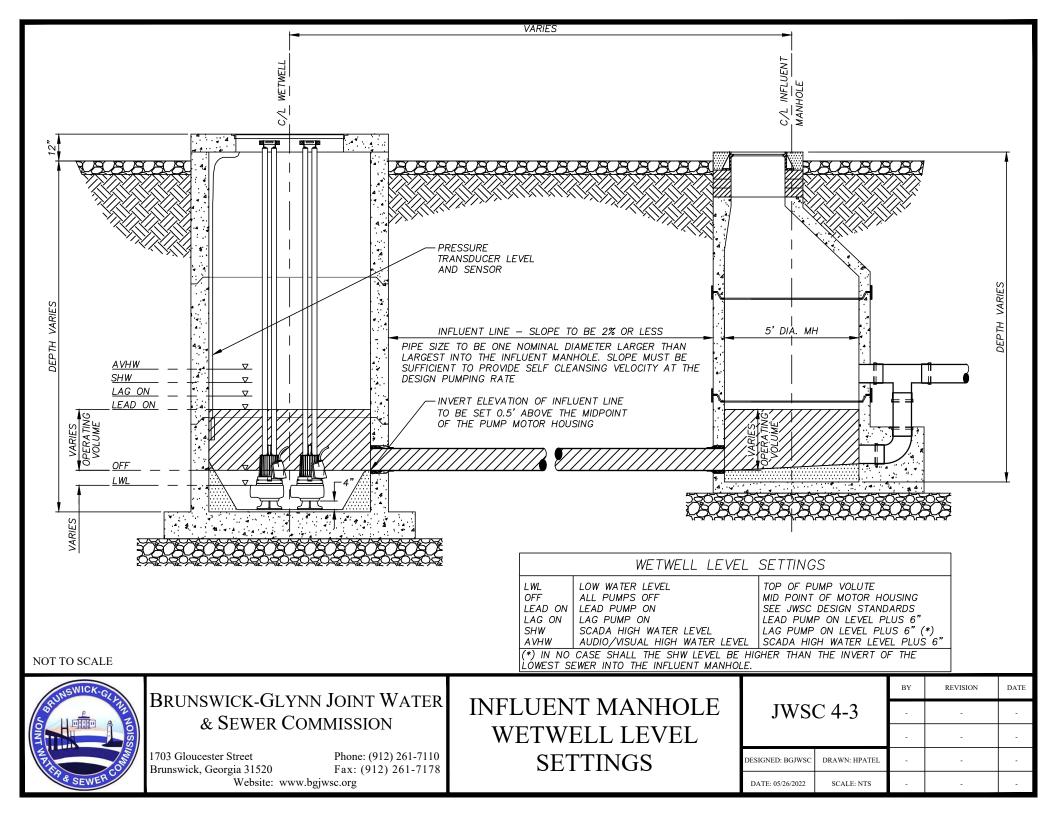


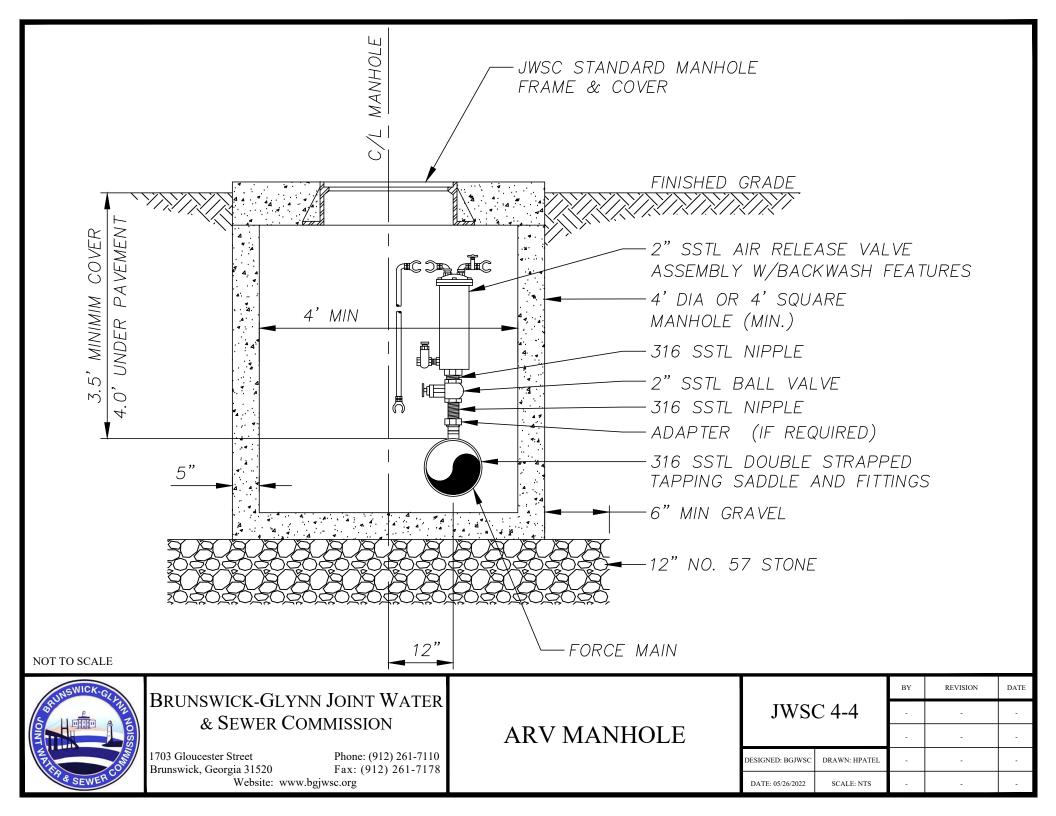


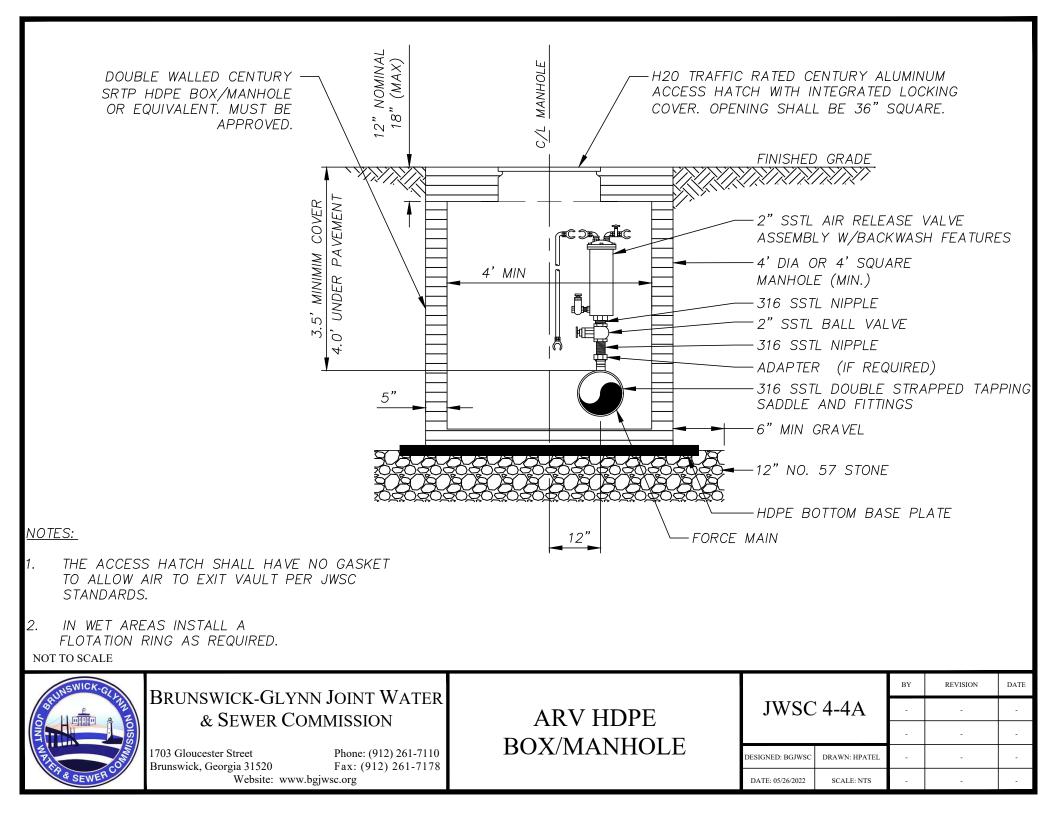


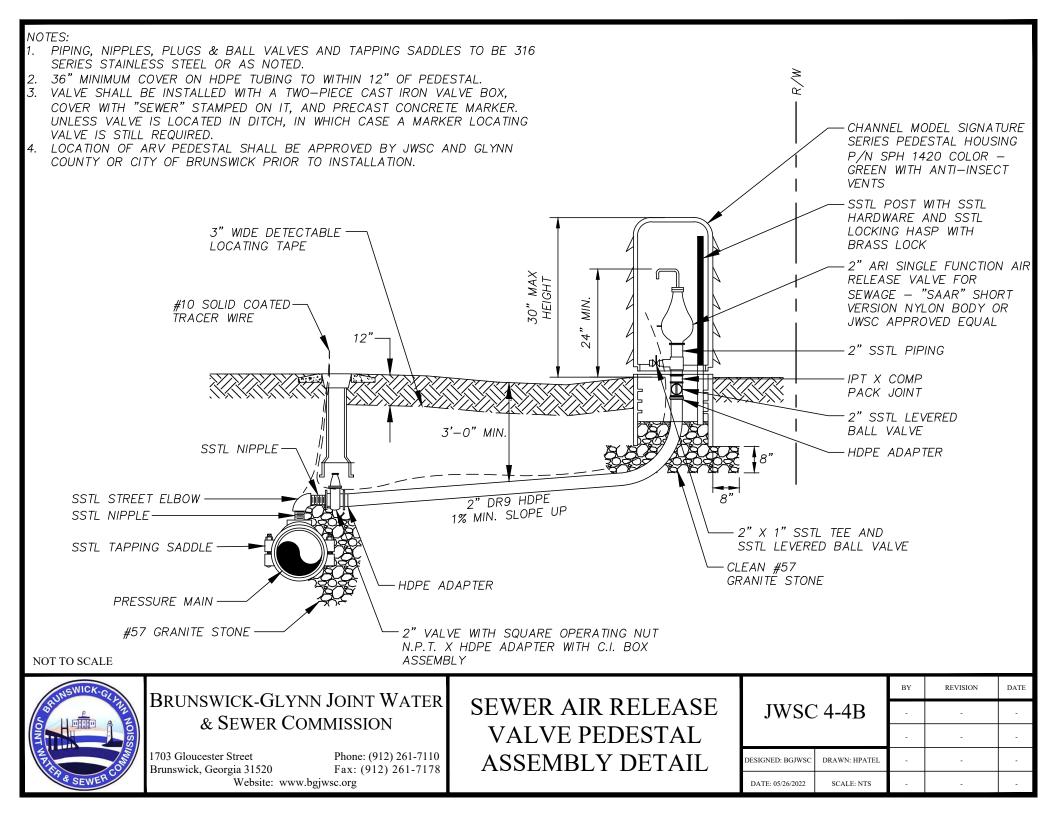


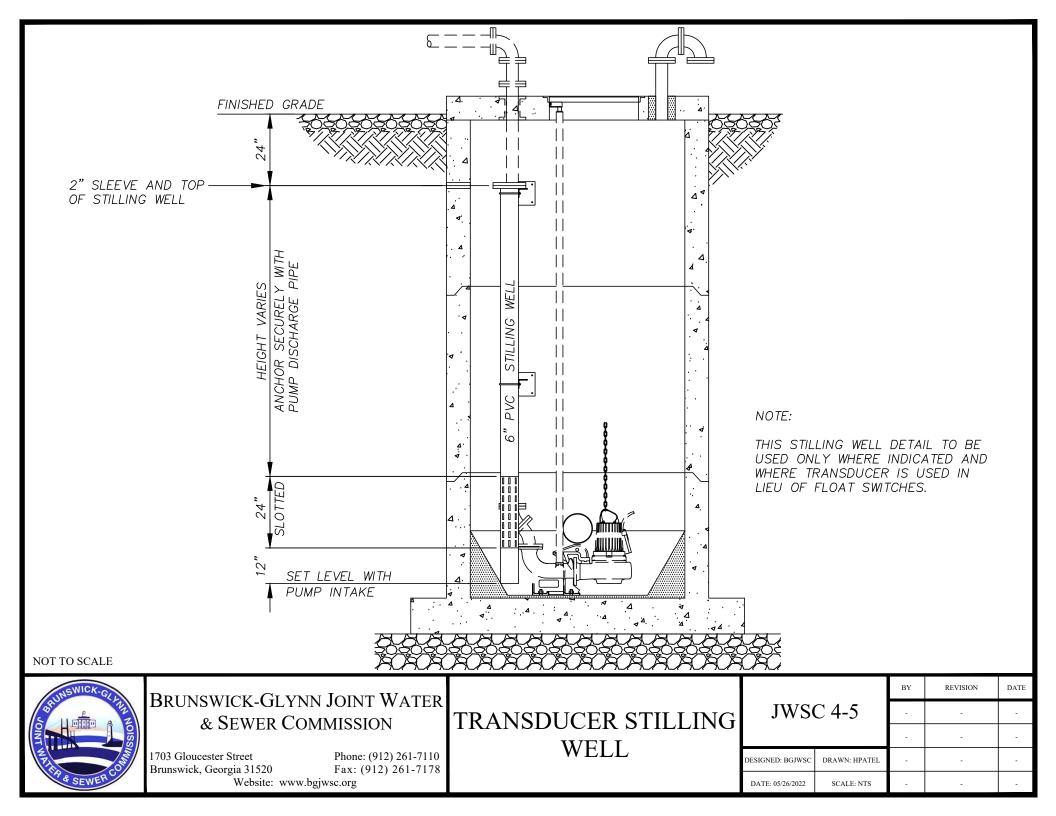


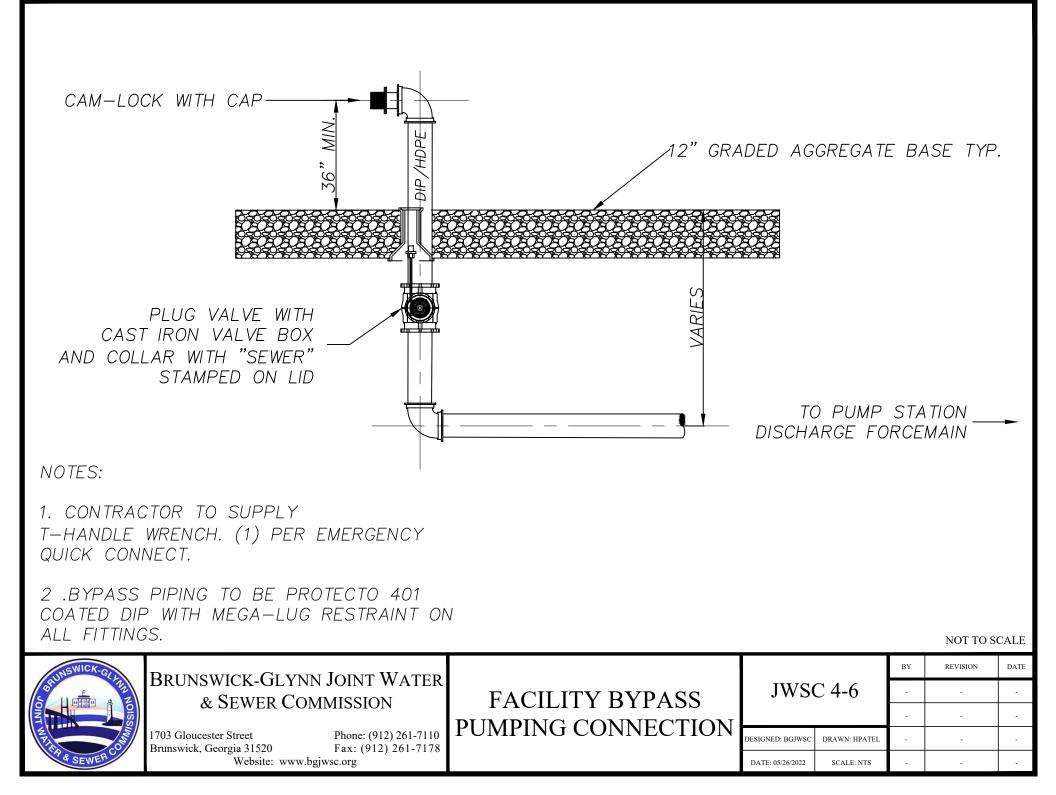


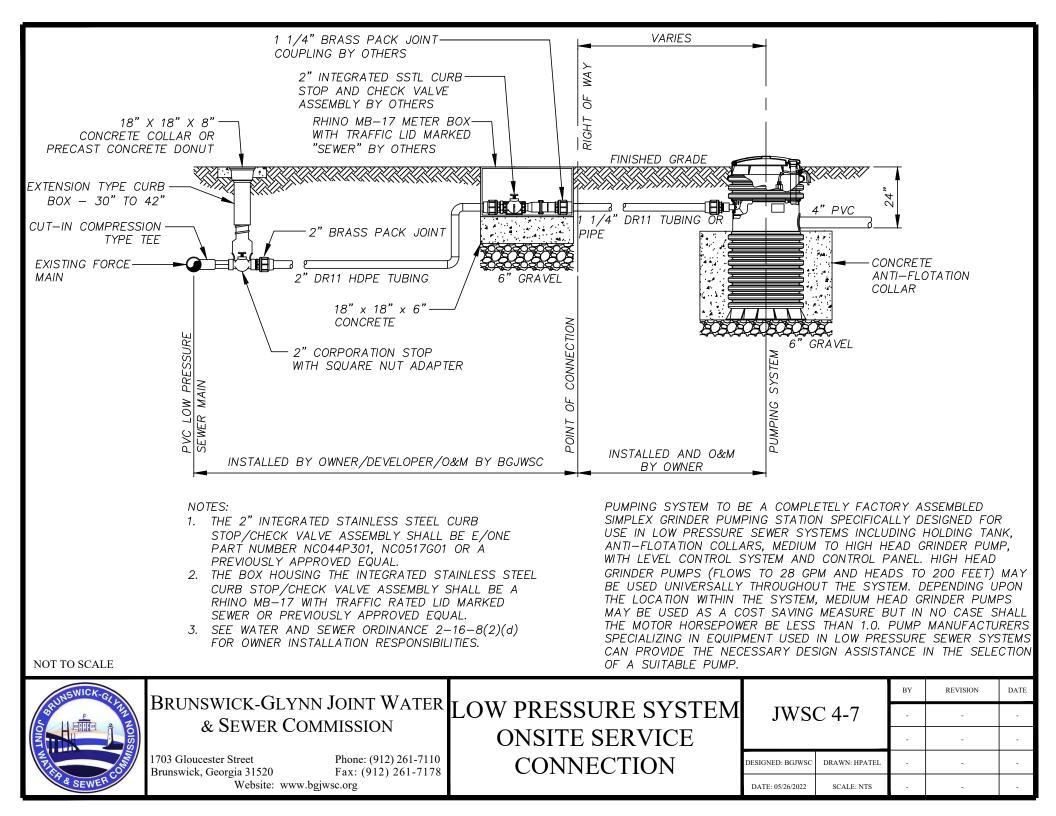


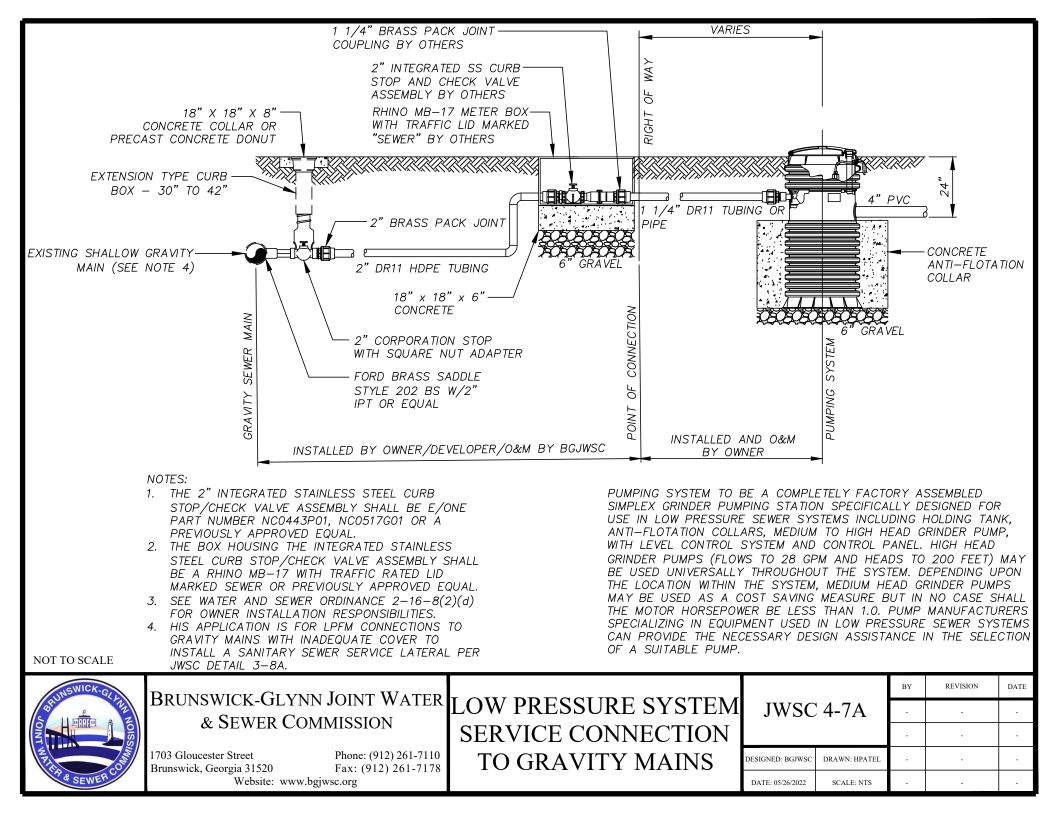


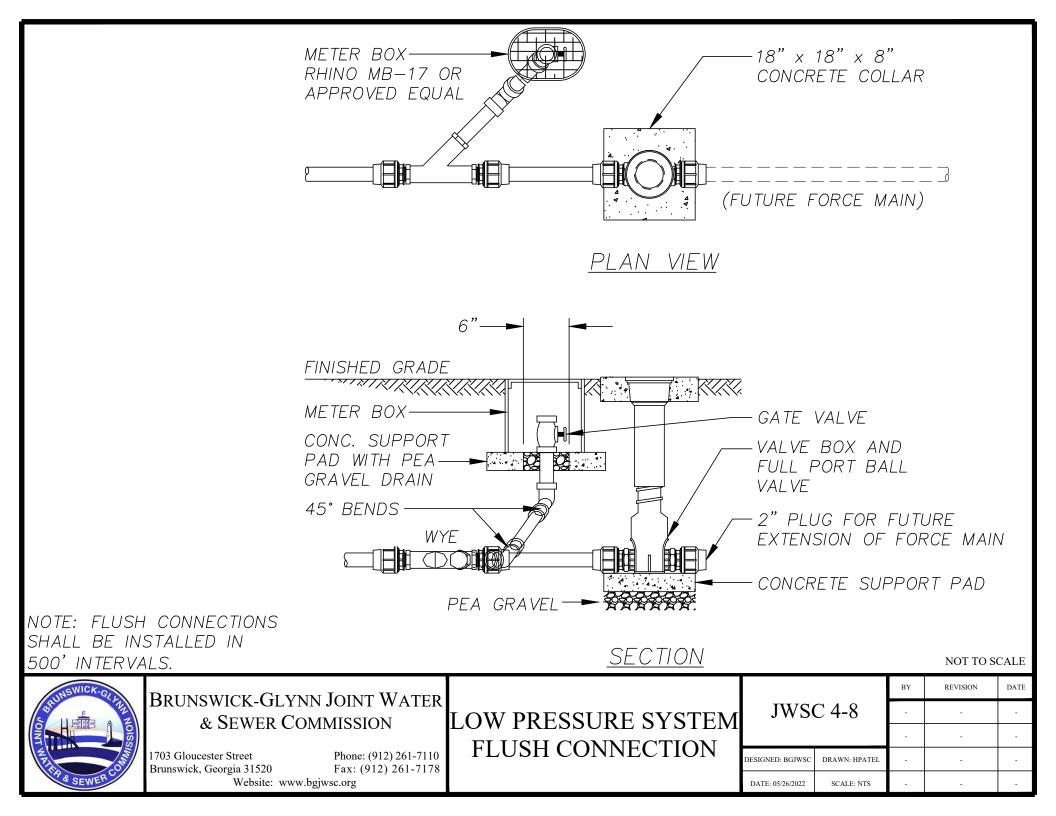


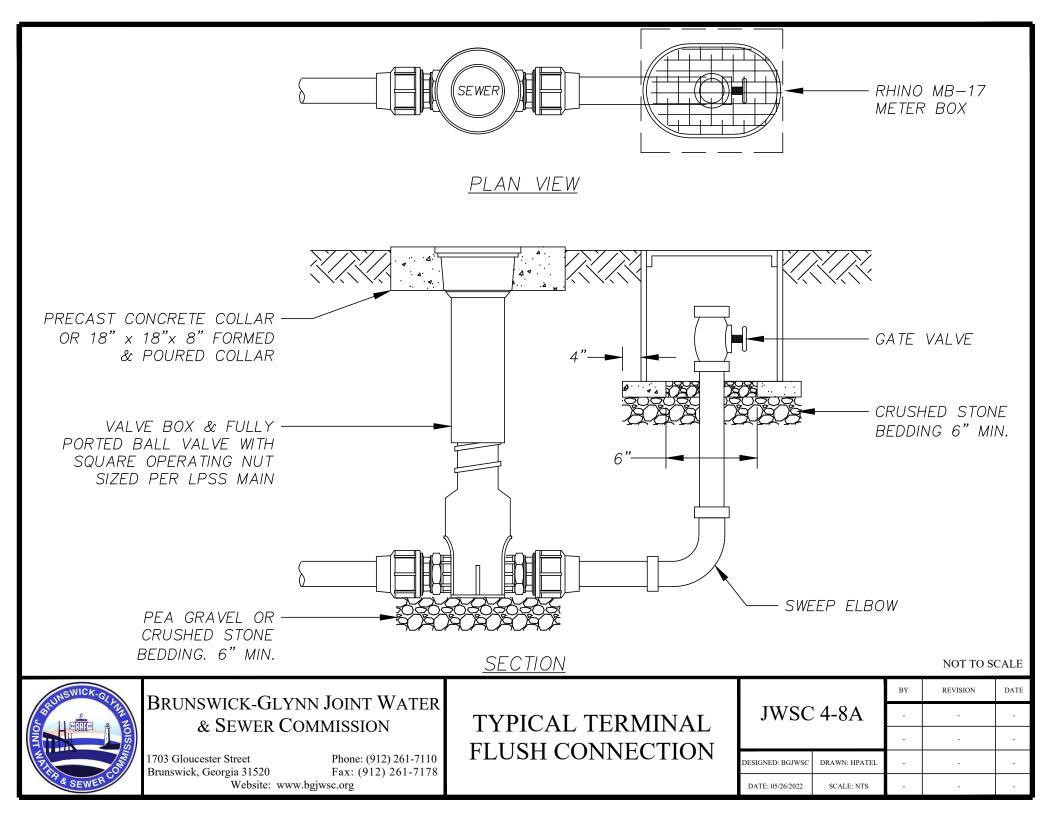


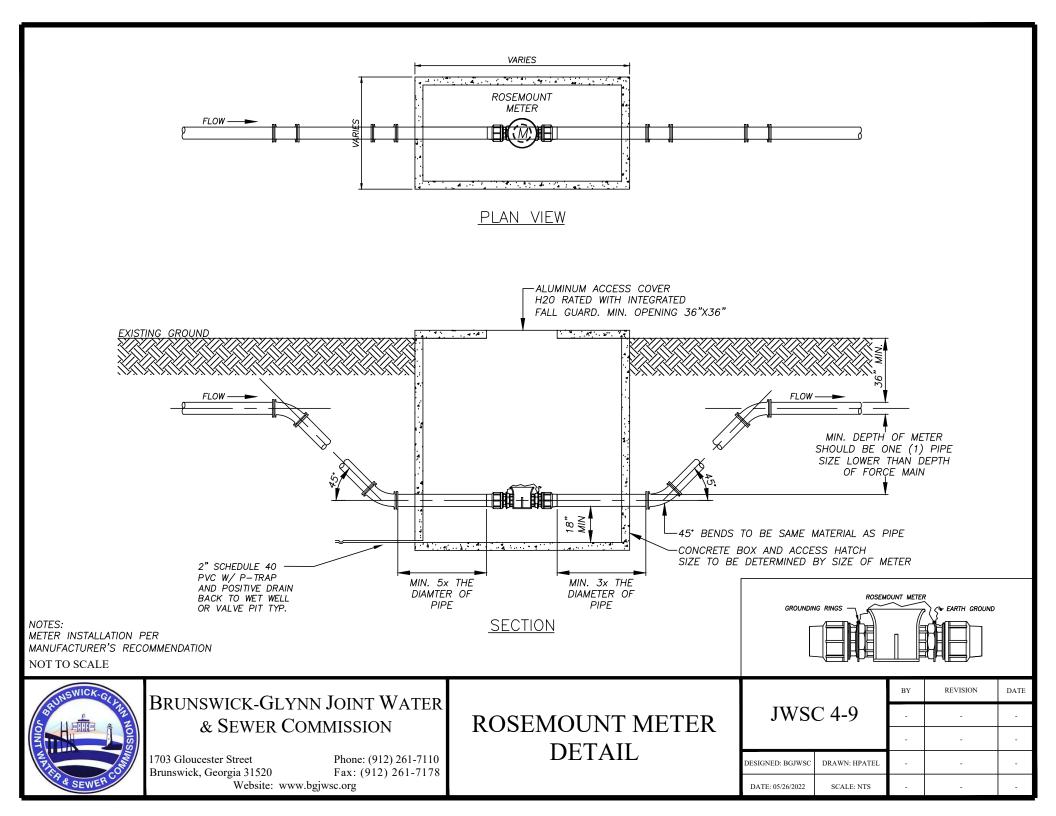

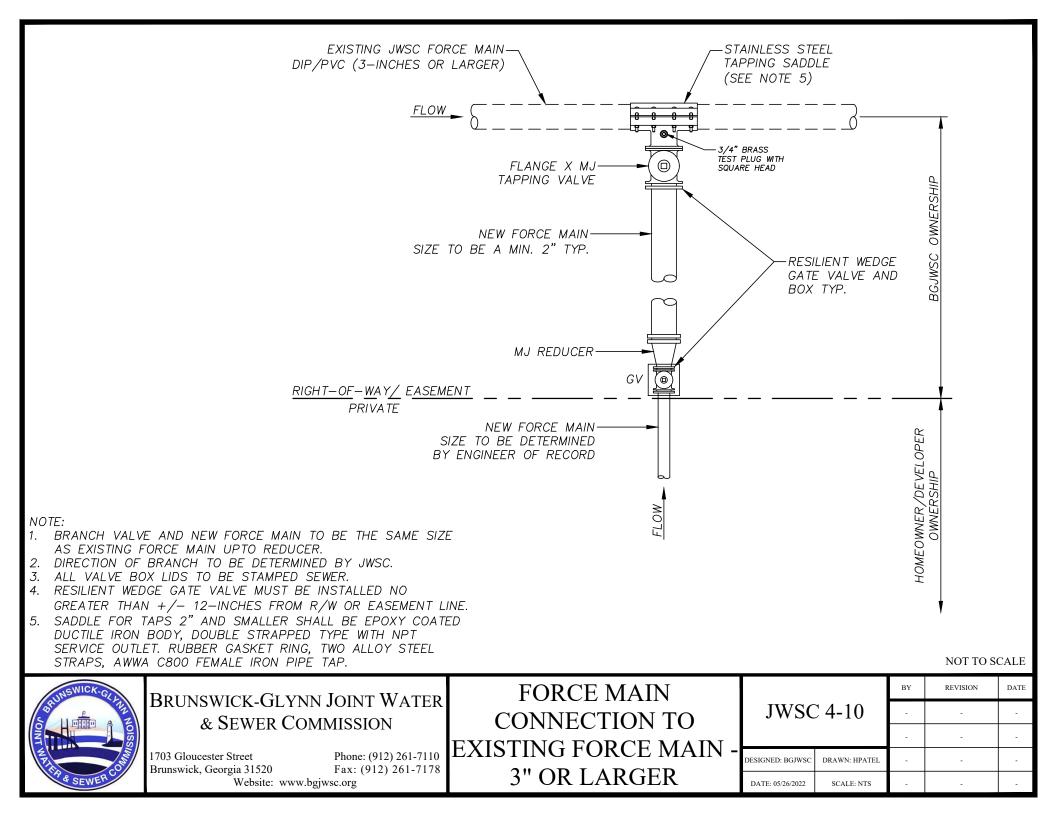


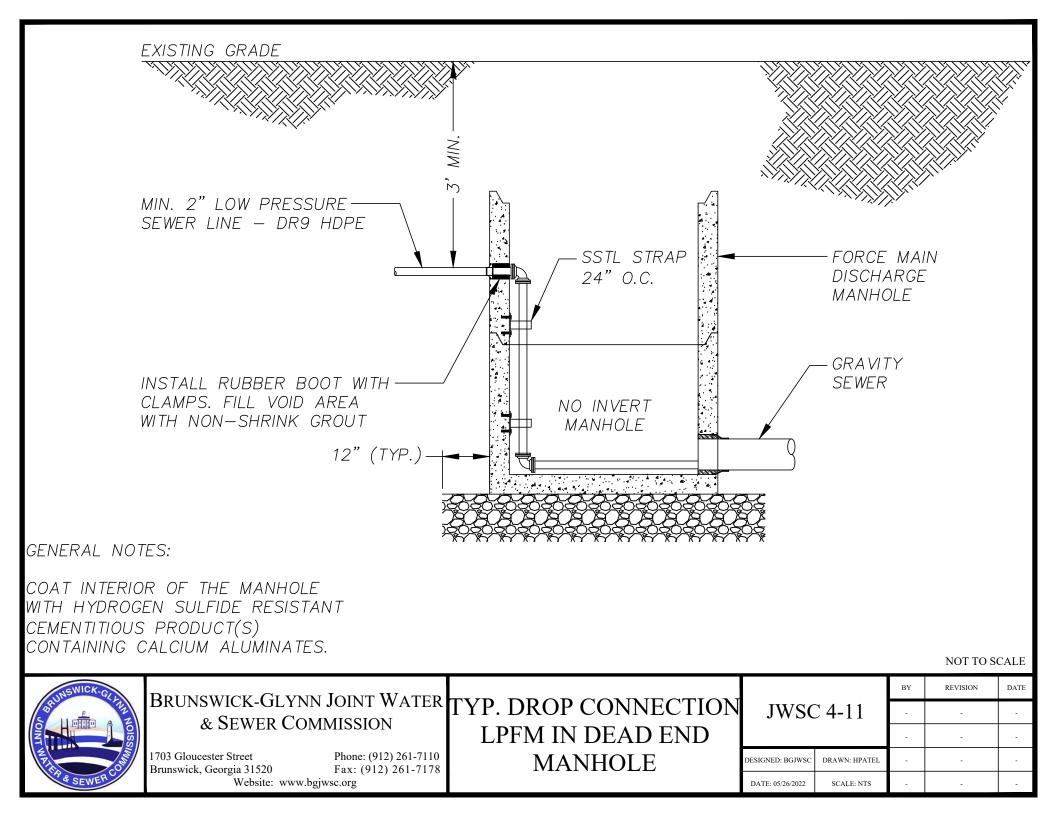

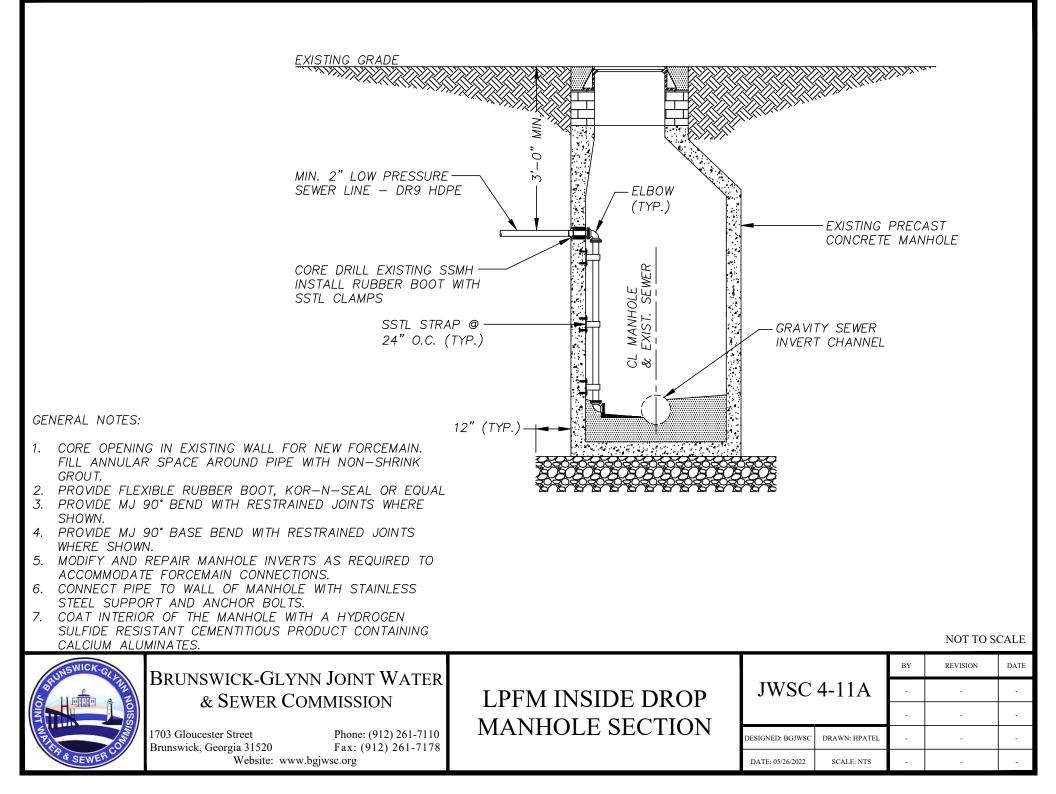


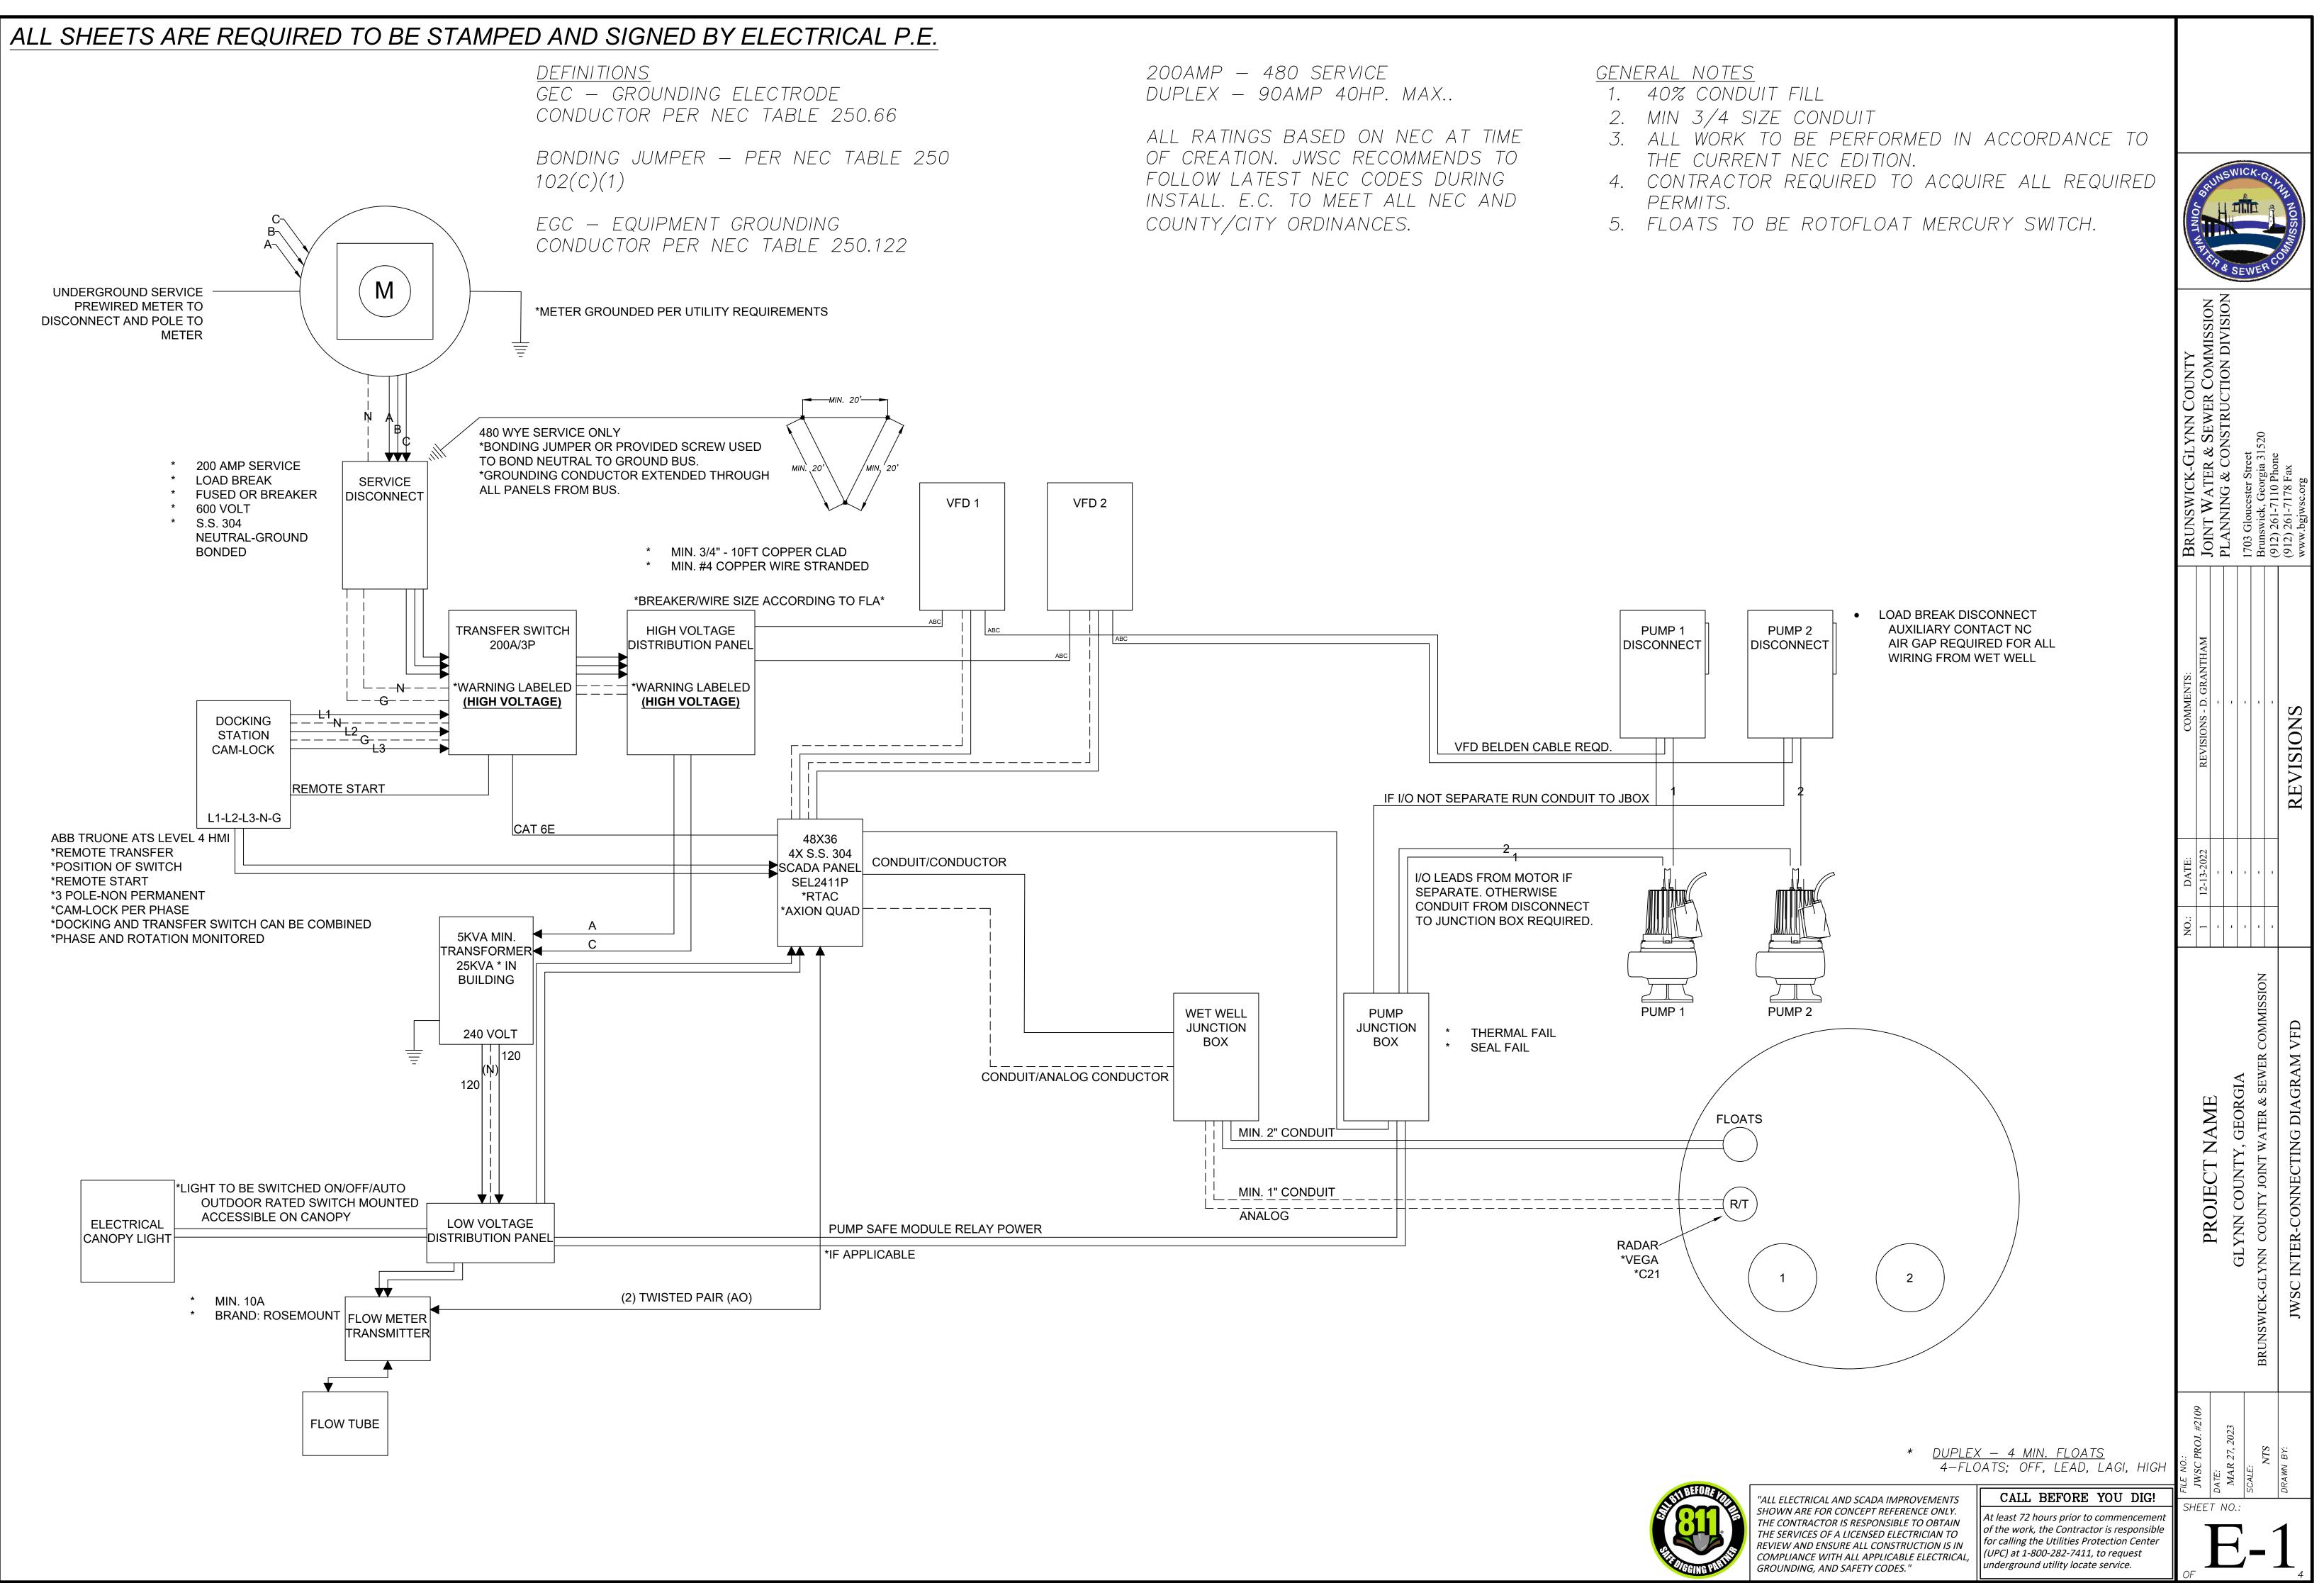


## ALL SHEETS ARE REQUIRED TO BE STAMPED AND SIGNED BY ELECTRICAL P.E.

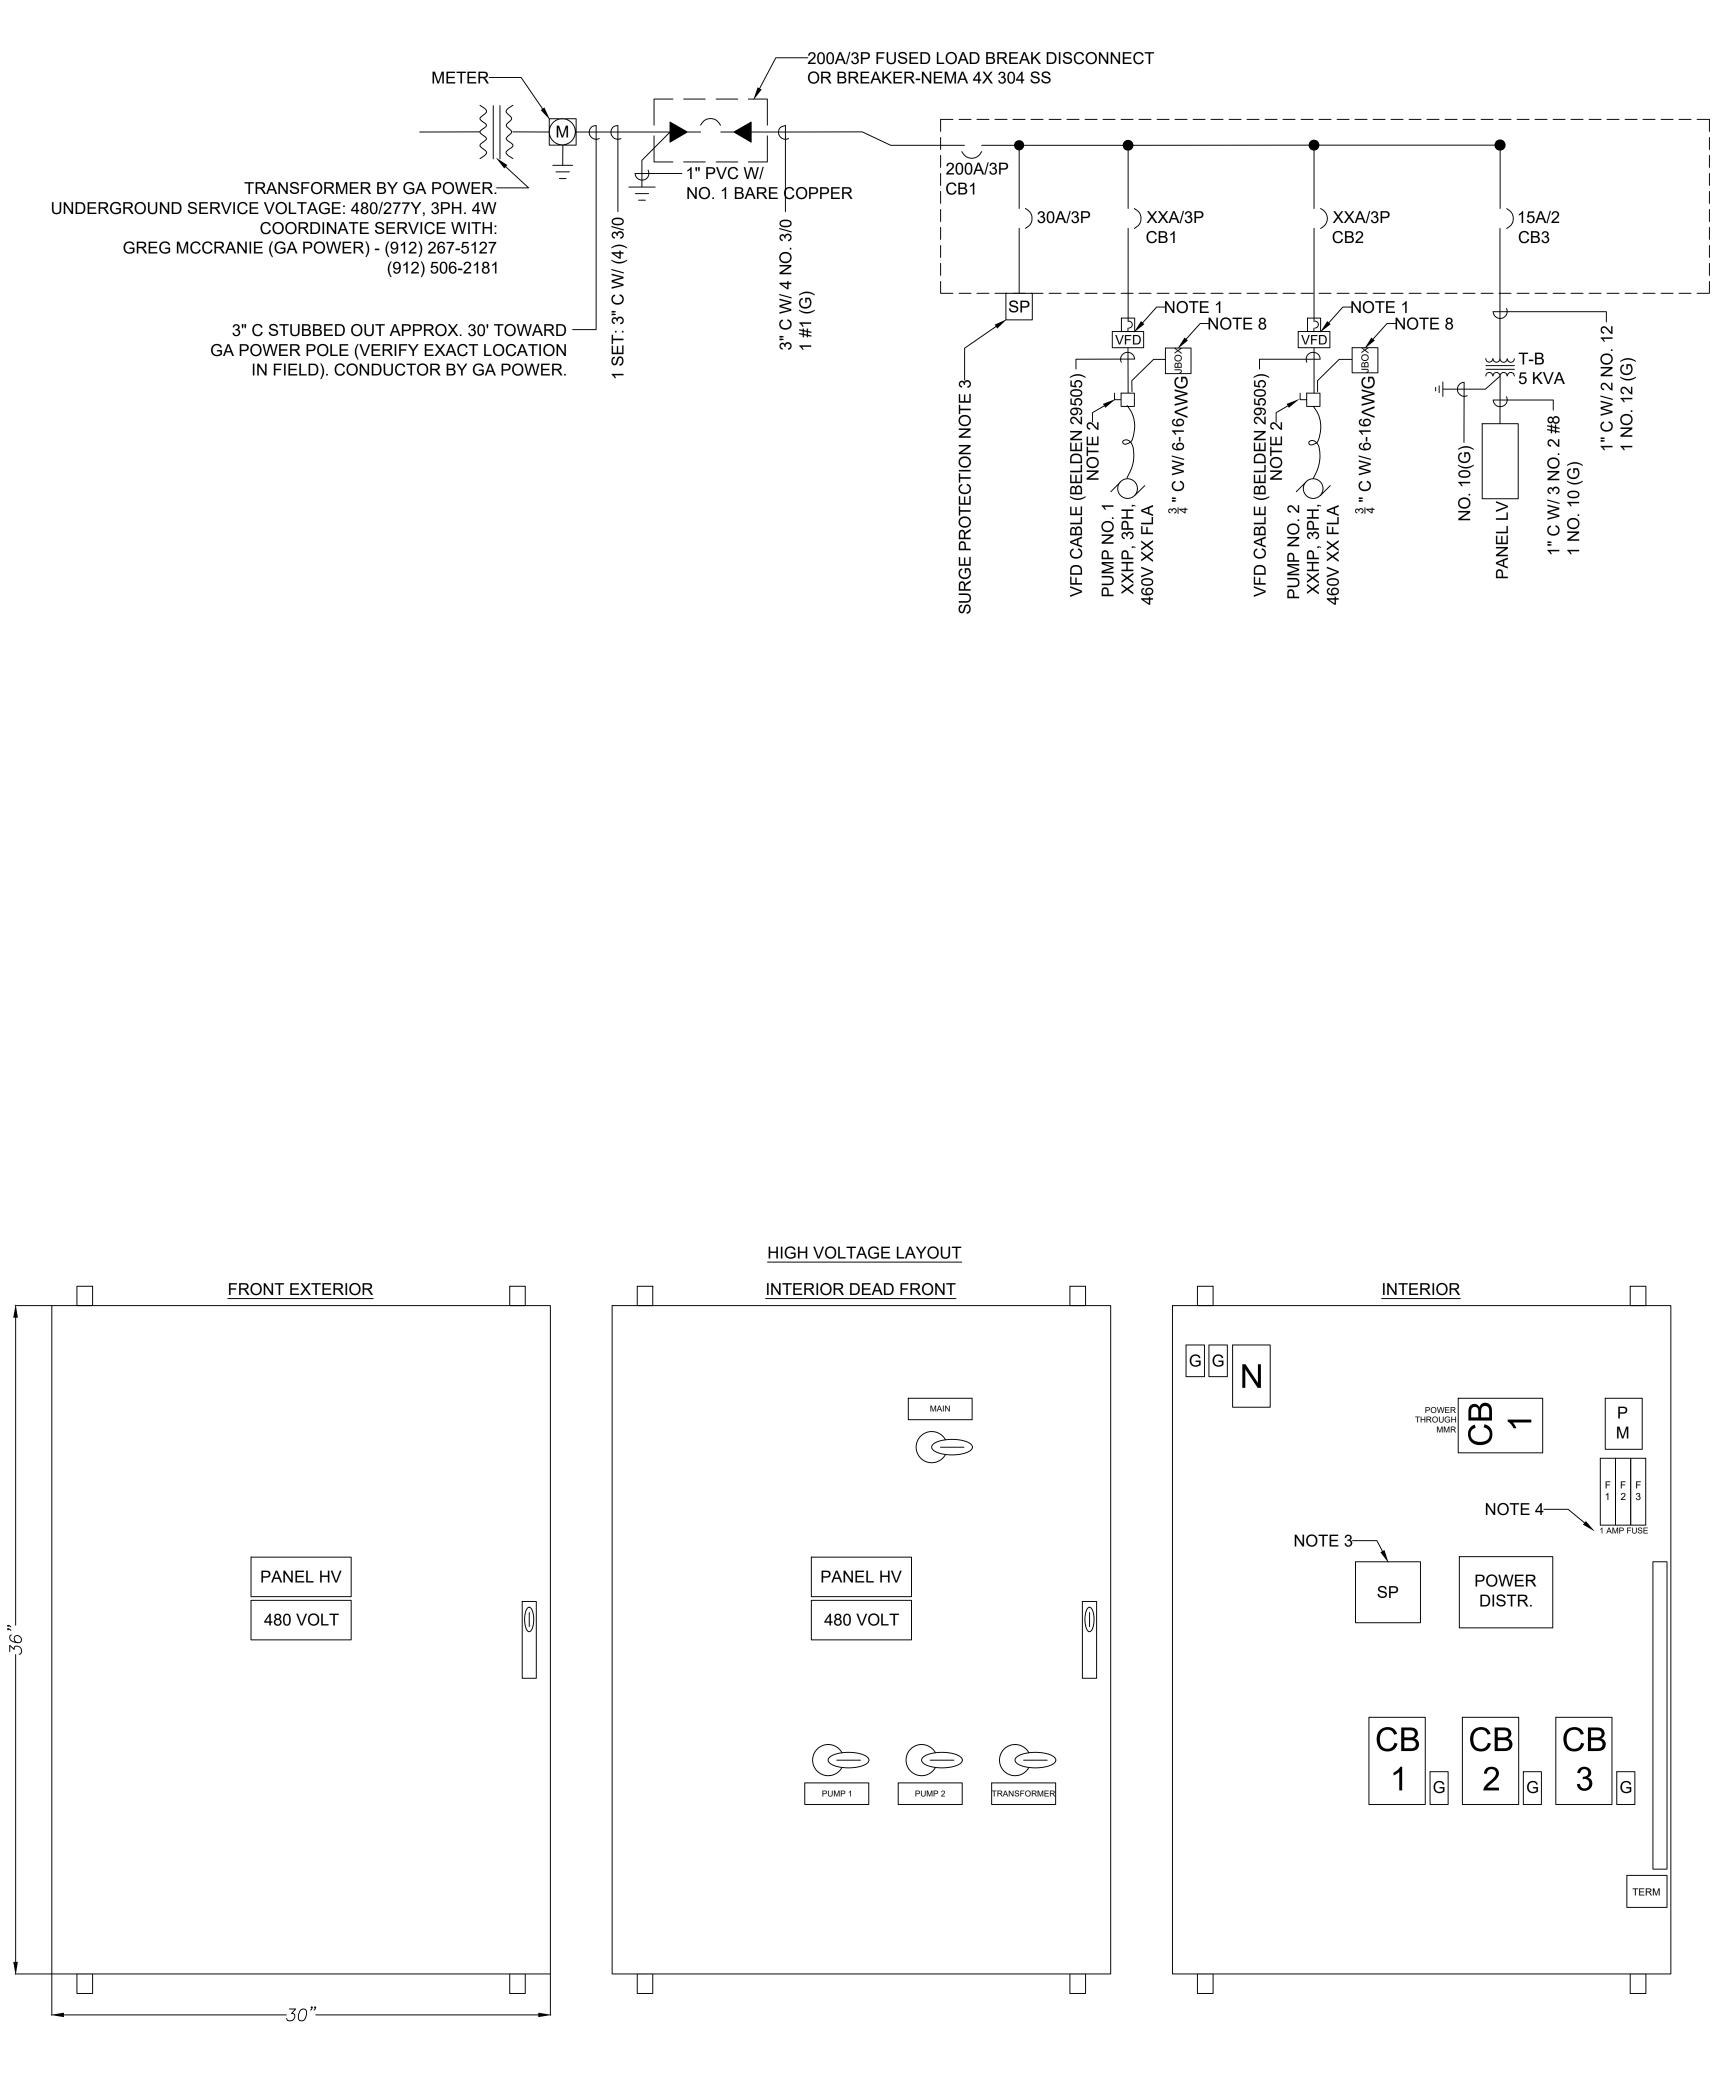

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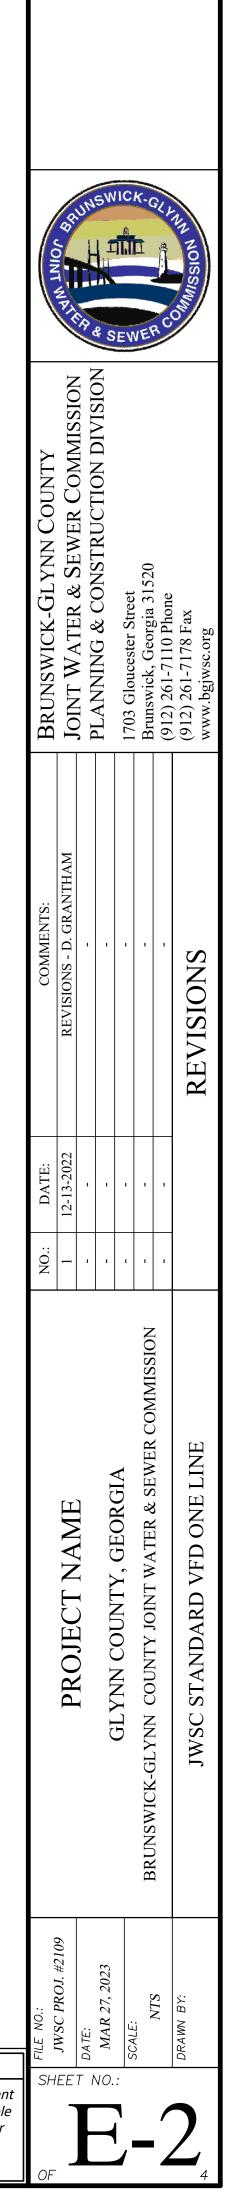
## LOW VOLTAGE LAYOUT

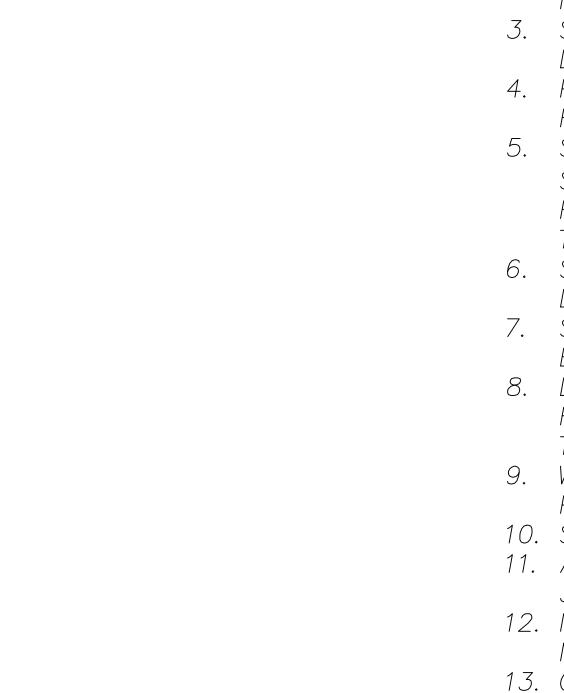

NF	ERAL NOTES
	ALL STARTERS TO BE VFD AS SPECIFIED.
	PUMP DISCONNECT – 100A LOAD BREAK S.S. 304
•	W/AUX CONTACTS WHICH SHALL INTERRUPT VFD
	RUN CIRCUIT BEFORE SWITCH OPENS.
	SURGE PROTECTION TO BE EQUIVALENT TO SQUARE
•	D. SDSA-3650 SURGE ARRESTOR.
	PHASE MONITOR TO BE FUSED WITH 1 AMP IN LINE
	FUSES. MODEL NO. PMPU MACROMATIC
•	SQUARE D QO PANEL INSTALLED INSIDE A
	STAINLESS STEEL ENCLOSURE W/ ALUMINUM DEAD
	FRONT AND RAISED REAR PANEL. DEAD FRONT CUI
	TO ALLOW BREAKER PASS THROUGH AND USAGE.
•	SURGE PROTECTOR TO BE EQUIVALENT TO SQUARE
	D. SDSA-1175.
	SIGNS ON PANELS TO BE MADE OF PLASTIC,
	ENGRAVED AND GLUED ON.
•	DISCONNECT TO JBOX FOR PUMP IO CABLE. T.B.
	REQUIRED IN DISCONNECT FOR PUMP CABLE TO
	TERMINATE.
•	WIRE TO BE SIZED FOR BREAKER CURRENT
$\neg$	PROTECTION, BASED ON PUMP AND DESIGN SIZING.
). 1.	STANDARD 5KVA NEMA 3R TRANSFORMER. ALL PANELS TO BE PAD LOCKABLE AND A HAVE
•	3-POINT LATCH SYSTEM.
2.	NEMA 4X DANFOSS VFD FC-202 WITH 10 YEAR
<u> </u>	MANUFACTURER WARRANTY.
3	GFCI OUTLET WITH IN USE BUBBLE COVER,

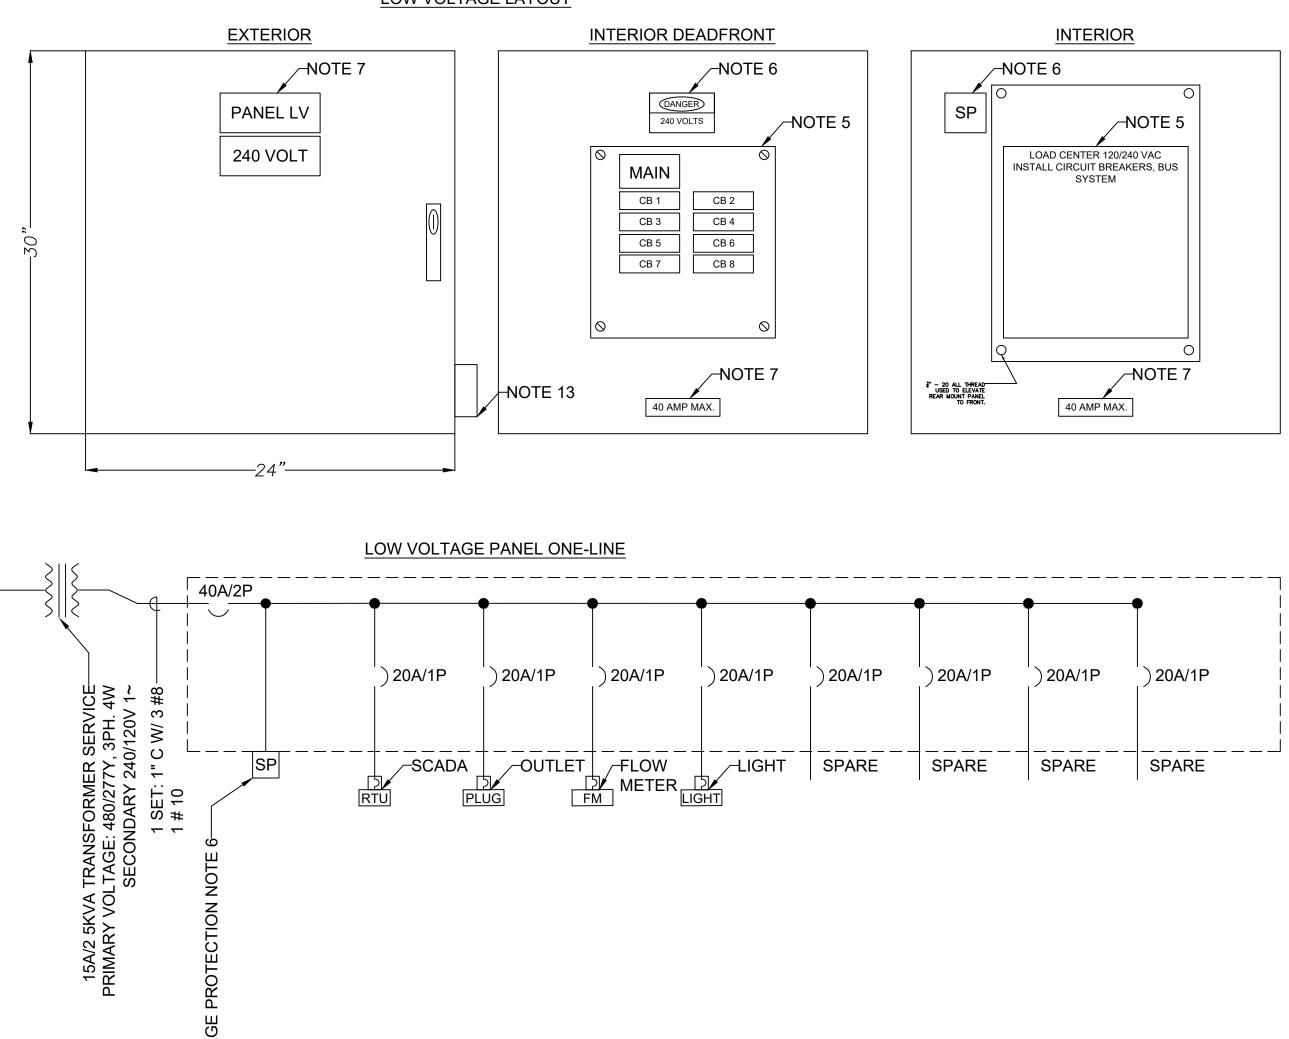MOUNTED TO LOWER RIGHT EXTERIOR EDGE OF LOW VOLT PANEL.


'1P	)20A/1P	)20A/1P	)20A/1P	)20A/1P	)20A/1P	)20A/1P
		LIGHT	SPARE	SPARE	SPARE	SPARE





"ALL ELECTRICAL AND SCADA IMPROVEMENTS SHOWN ARE FOR CONCEPT REFERENCE ONLY. THE CONTRACTOR IS RESPONSIBLE TO OBTAIN THE SERVICES OF A LICENSED ELECTRICIAN TO REVIEW AND ENSURE ALL CONSTRUCTION IS IN COMPLIANCE WITH ALL APPLICABLE ELECTRICAL, GROUNDING, AND SAFETY CODES."

CALL BEFORE YOU DIG! At least 72 hours prior to commencement of the work, the Contractor is responsible for calling the Utilities Protection Center (UPC) at 1-800-282-7411, to request underground utility locate service.

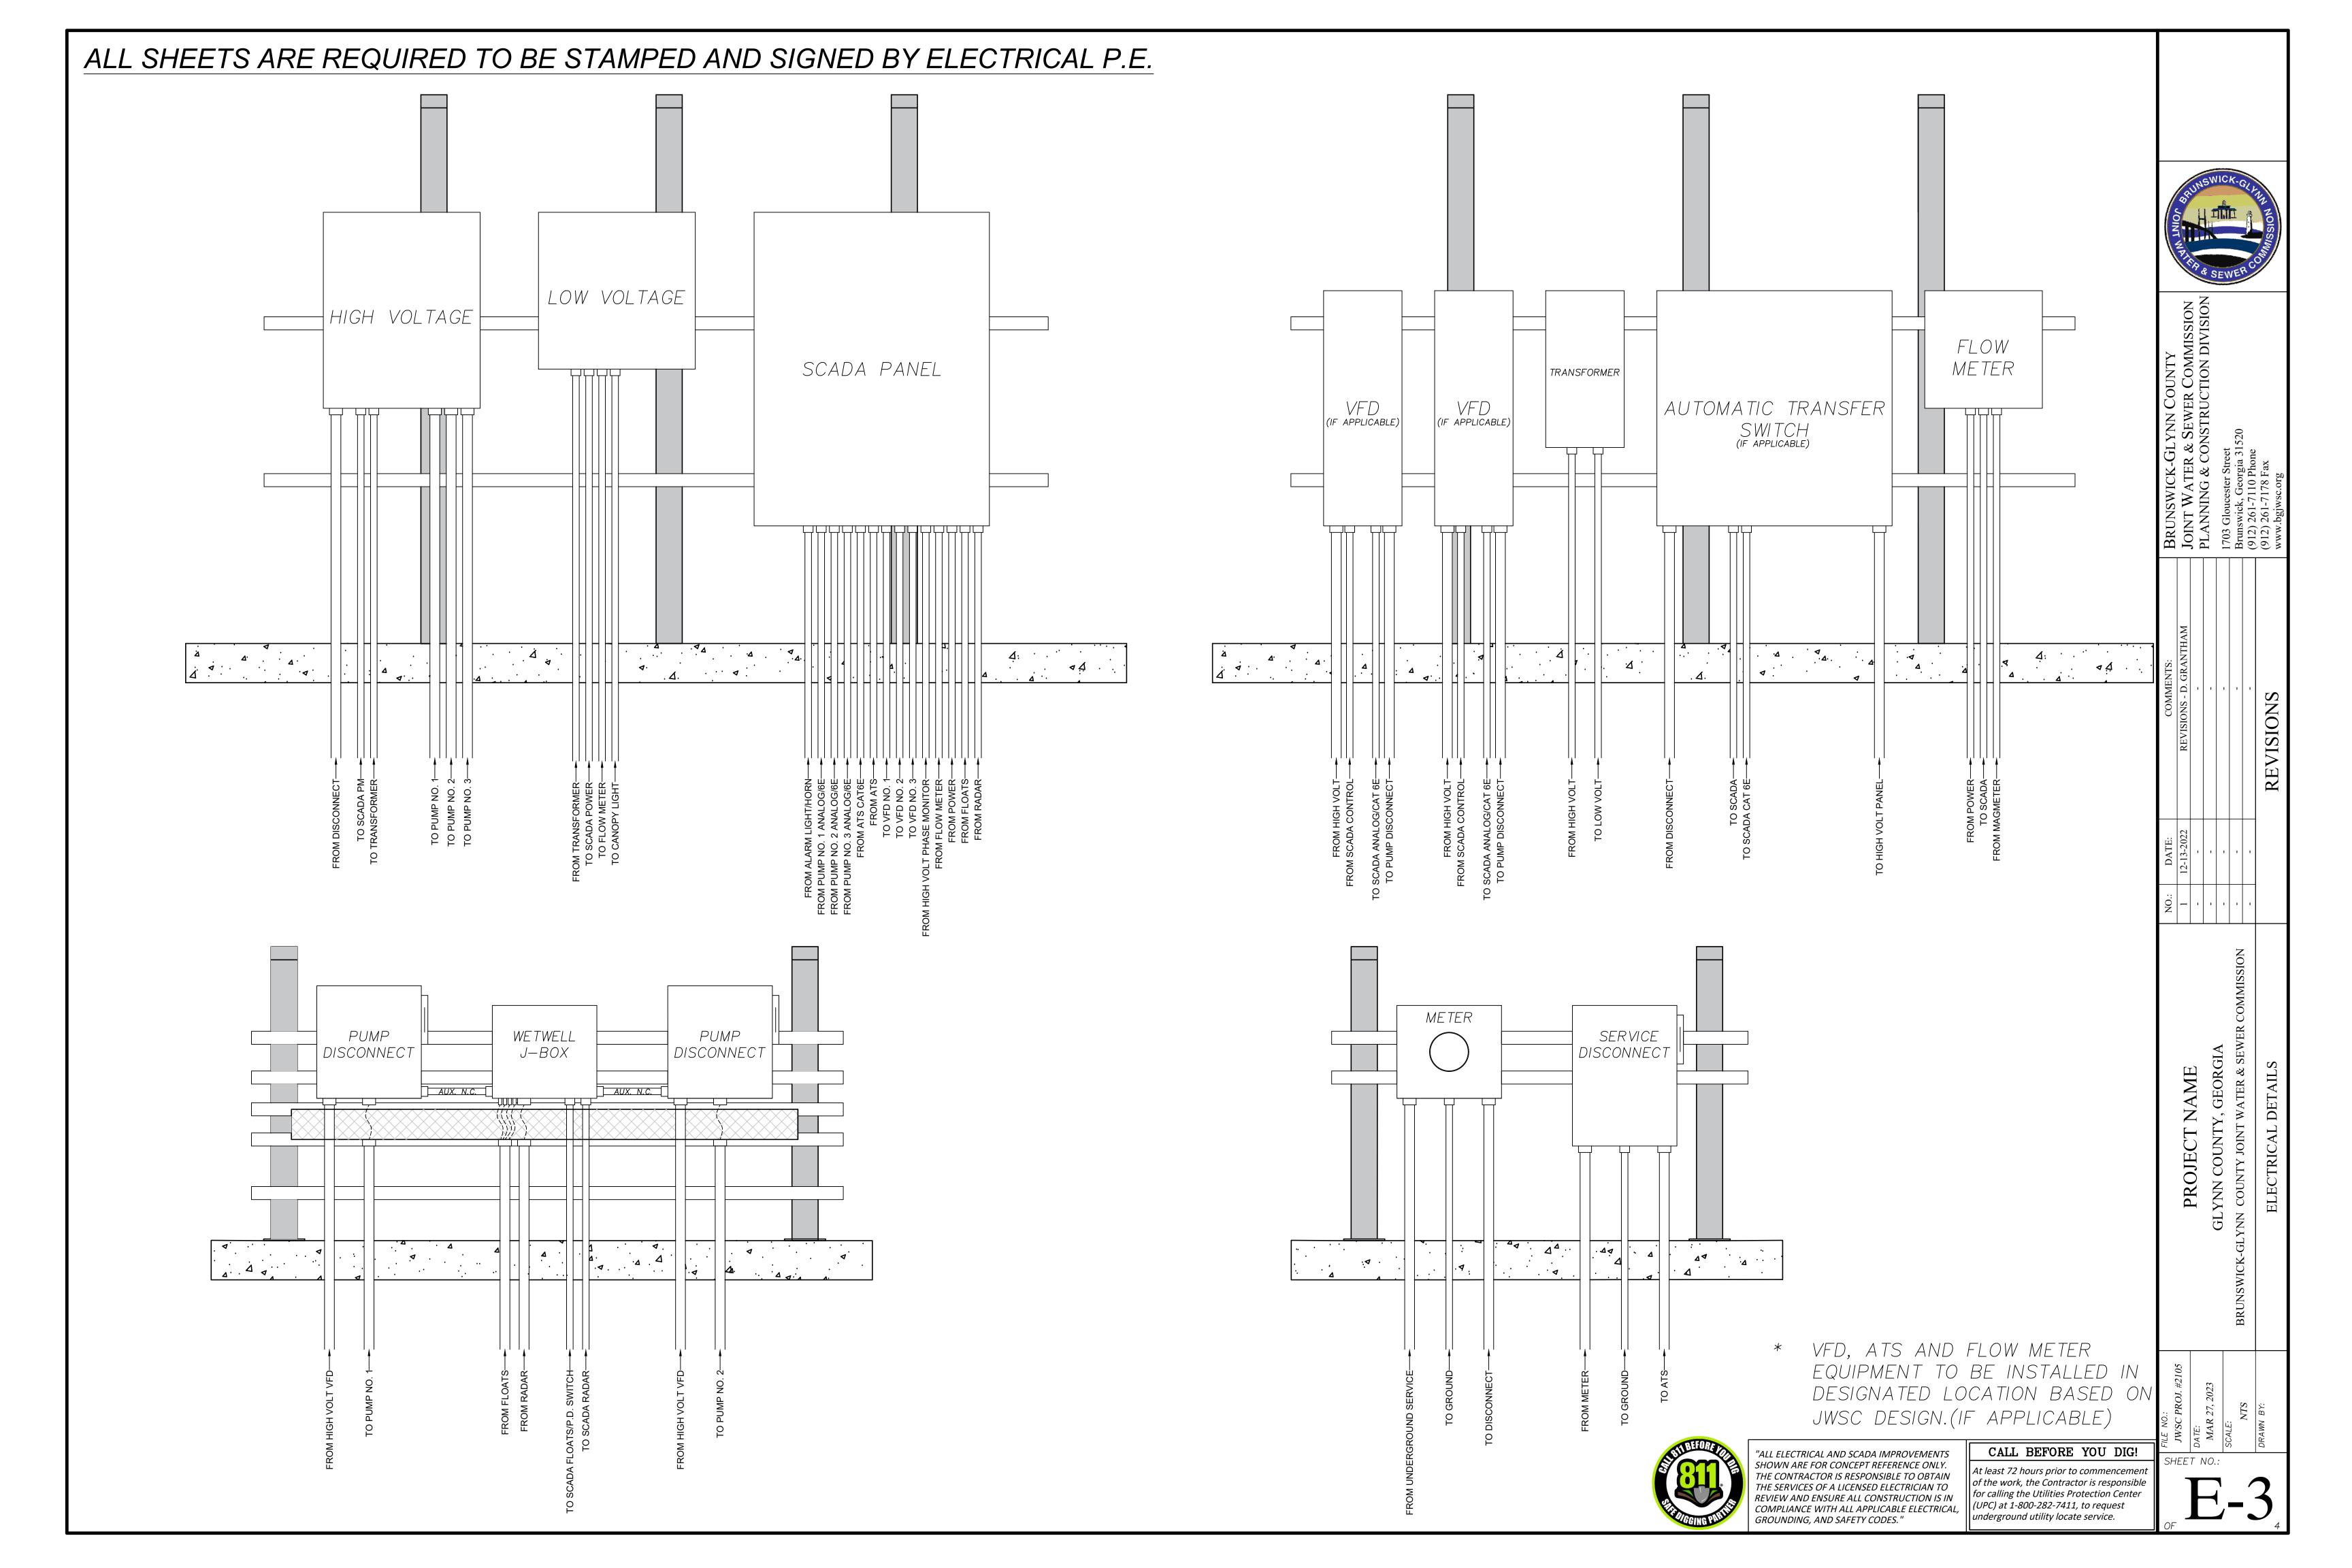

# ALL SHEETS ARE REQUIRED TO BE STAMPED AND SIGNED BY ELECTRICAL P.E.

## ELECTRICAL REQUIREMENTS:

- CONTACT AND COORDINATE WITH LOCAL ELECTRICAL UTILITY SERVICING THE PARTICULAR AREA OF WORK.
  THE EXACT LOCATION OF SERVICE SHALL BE COORDINATED IN THE FIELD WITH OTHER WORK ON THE PROJECT SITE AND THE
- ELECTRICAL UTILITY. PROVIDE AERIAL OR UNDERGROUND SERVICE AS REQUIRED BY THE UTILITY AND PROJECT REQUIREMENTS. 3. THE SERVICE METER SHALL BE PROVIDED IN ACCORDANCE TO THE ELECTRICAL UTILITY STANDARDS. PROVIDE METER GROUND AS REQUIRED.
- 4. SCADA PANEL WILL BE AVAILABLE FROM JWSC FOR PURCHASE. START-UP AND TERMINATION WILL BE COMPLETED BY EMC (205–661–3998). PLEASE ALLOW FOR TIME TO BE PLACED ON SCHEDULE WITH EMC. COORDINATE WITH EMC FOR START-UP AND TESTING.
- 5. DANFOSS VFD NEMA 4X FC-202 REQUIRED WITH 10 YEAR WARRANTY FOR JWSC. (IF APPLICABLE)
- 6. ALL CONDUIT INSTALLED SHALL BE ACCORDING TO NEC AND UTILIZING THE BEST PATH POSSIBLE WITH MINIMAL INTERFERENCE WITH OTHER UTILITIES.
- CONTRACTOR TO INSTALL DETECTABLE WARNING TAPE 12" ABOVE ALL UNDERGROUND CONDUIT.
  ALL CONDUITS ENTERING NEMA 4X ENCLOSURES SHALL BE TERMINATED WITH THREADED HUBS TO MAINTAIN THE NEMA RATING OF THE ENCLOSURE UNLESS NOTED OTHERWISE.
- 9. FOR TERMINATION OF CONDUITS AT JUNCTION BOXES AND PUMP DISCONNECTS PROVIDE SEALING HUBS. FOR CONNECTIONS FROM WETWELL, PROVIDE CORDGRIPS ACCORDING TO WIRE SIZE.
- 10. SEAL ALL CONDUITS WITH ELECTRICAL DUCT SEAL.
- 11. ALL SWITCH OPERATING HANDLES SHALL BE MAXIMUM OF 66-INCHES ABOVE FINISH GRADE.
- FURNISH STAINLESS STEEL BOLTS, NUTS AND WASHERS FOR ALL EQUIPMENT.
  POSITION ELECTRICAL ALARM LIGHT TO BE SEEN FROM THE NEAREST ROAD.ATTACHED TO CANOPY LEGS OR STRUCTURE USING ONLY S.S. HARDWARE.
- 14. PROVIDE IN WETWELL HATCH WINDOW A STAINLESS STEEL BRACKET FOR SUPPORT OF ALL CABLES WITH A MINIMUM 5 HOOKS.
- METER EQUIPMENT TO BE MOUNTED AT A MIN. 3'-6" AND MAX. 5'-6" ABOVE FINAL GRADE.
  AIR GAP BOX TO BE A MIN. OF 12" X 12" X 60" ALUMINUM ANGLE FRAME WITH ALUMINUM EXPANDED METAL FRONT AND REAR. FRONT HINGED ON BOTTOM. FLAT ALUMINUM SHEET ON BOTTOM AND TOP. WEEP HOLES PLACED ON ALL FOUR CORNERS.
- 17. WETWELL CONDUITS STUB 1" INTO AIR GAP CAGE TYP.
- 18. MINIMUM SPACING BETWEEN WETWELL AND DISCONNECTS IS 6'-0".
- 19. CABLES LEADS TO BE A MINIMUM OF 50'-0" IN LENGTH.
- 20. ATS TO BE ABB TRUEONE WITH LEVEL 4 CONTROLLER PAIRED WITH CAM-LOCK DOCKING STATION. (IF REQUIRED BY JWSC).
- 21. FLOATS TO BE ROTOFLOAT MERCURY TYPE MODEL "S" 60FT CABLE TYP. 22. INSTALLATION OF SEAL FAIL OR THERMAL RELAYS COORDINATED BY ELECTRICAL CONTRACTOR AND EMC INSTALLATION AREA INSIDE THE SCADA PANEL OR WET WELL JUNCTION BOX.
- 23. EQUIPMENT CANOPY LIGHTING SHALL BE SWITCHED WITH OFF/ON OUTDOOR RATED, LIGHTS TO BE LITHONIA 6500K LED OR APPROVED EQUAL SECURED TO SHELTER STRUCTURE WITH O DEGREE F RATED ELECTRONIC BALLAST.
- 24. ALL CONDUITS TO BE SCHEDULE 40 PVC.
- 25. ALL CONDUCTORS TO BE STRANDED COPPER, TYPE THWN. COLOR CODE: 480/277V: PH A:BROWN; PH B:YELLOW; PH C:ORANGE; NEUTRAL:GRAY; 230/115V — PH A:BLACK; PH C:RED; NEUTRAL:WHITE; GROUND:GREEN.


## TERMINAL ENCLOSURE NOTES:


- PROVIDE TERMINALS AS REQUIRED FOR POWER AND SIGNAL CABLE (FLOAT SWITCH) TERMINATIONS. PROVIDE 10% SPARE TERMINALS, MAKE CONNECTIONS PER PUMP MFR'S RECOMMENDATIONS. MAINTAIN 3" MIN. AC-DC SEPARATION IN TERMINAL ENCLOSURE. ROUTE CABLES WITH CORD GRIPS FOR WETWELL ORIGINATION TERMINATIONS. PVC CONDUIT TO CORDINATED PANELS, PLUG ALL HOLES WITH GROMMETS.
- 2. MINIMUM SIZE OF THE JUNCTION BOX SHALL BE 12"X12"X6". FURNISH NEMA 4X STAINLESS STEEL JUNCTION BOX WITH  $\frac{1}{4}$  TURN DOOR LATCH AND ALUMINUM BACK PLATE.

## SCADA NOTES:

- 1. REQUIRES ONE 110V CIRCUIT FROM LOW VOLTAGE PANEL. HORN AND EMERGENCY LIGHT TO BE INSTALLED IN VISUAL LOCATION FROM ROADWAY.
- 2. VEGA C-21 RADAR TO BE INSTALLED IN WET WELL USING S.S. HARDWARE.

$\frac{3}{4}$ " × 10" COPPER CLADGROUND ROD DRIVEN TO 12" BELOWFINISH GRADE TO TOP OF ROD. (TYPICAL 3 LOCATIONS)
BARE COPPER INSTALLED 24" BELOW FINISH GRADE
3" PVC CONDUIT WITH BARE STRANDED      COPPER CONDUCTOR      TO SERVICE BREAKER NEUTRAL
TO GENERATOR BREAKER NEUTRAL ALL CONNECTIONS SHALL BE TO SURGE PROTECTION DEVICE
SECONDARY ELECTRICAL GROUNDING NOT TO SCALE

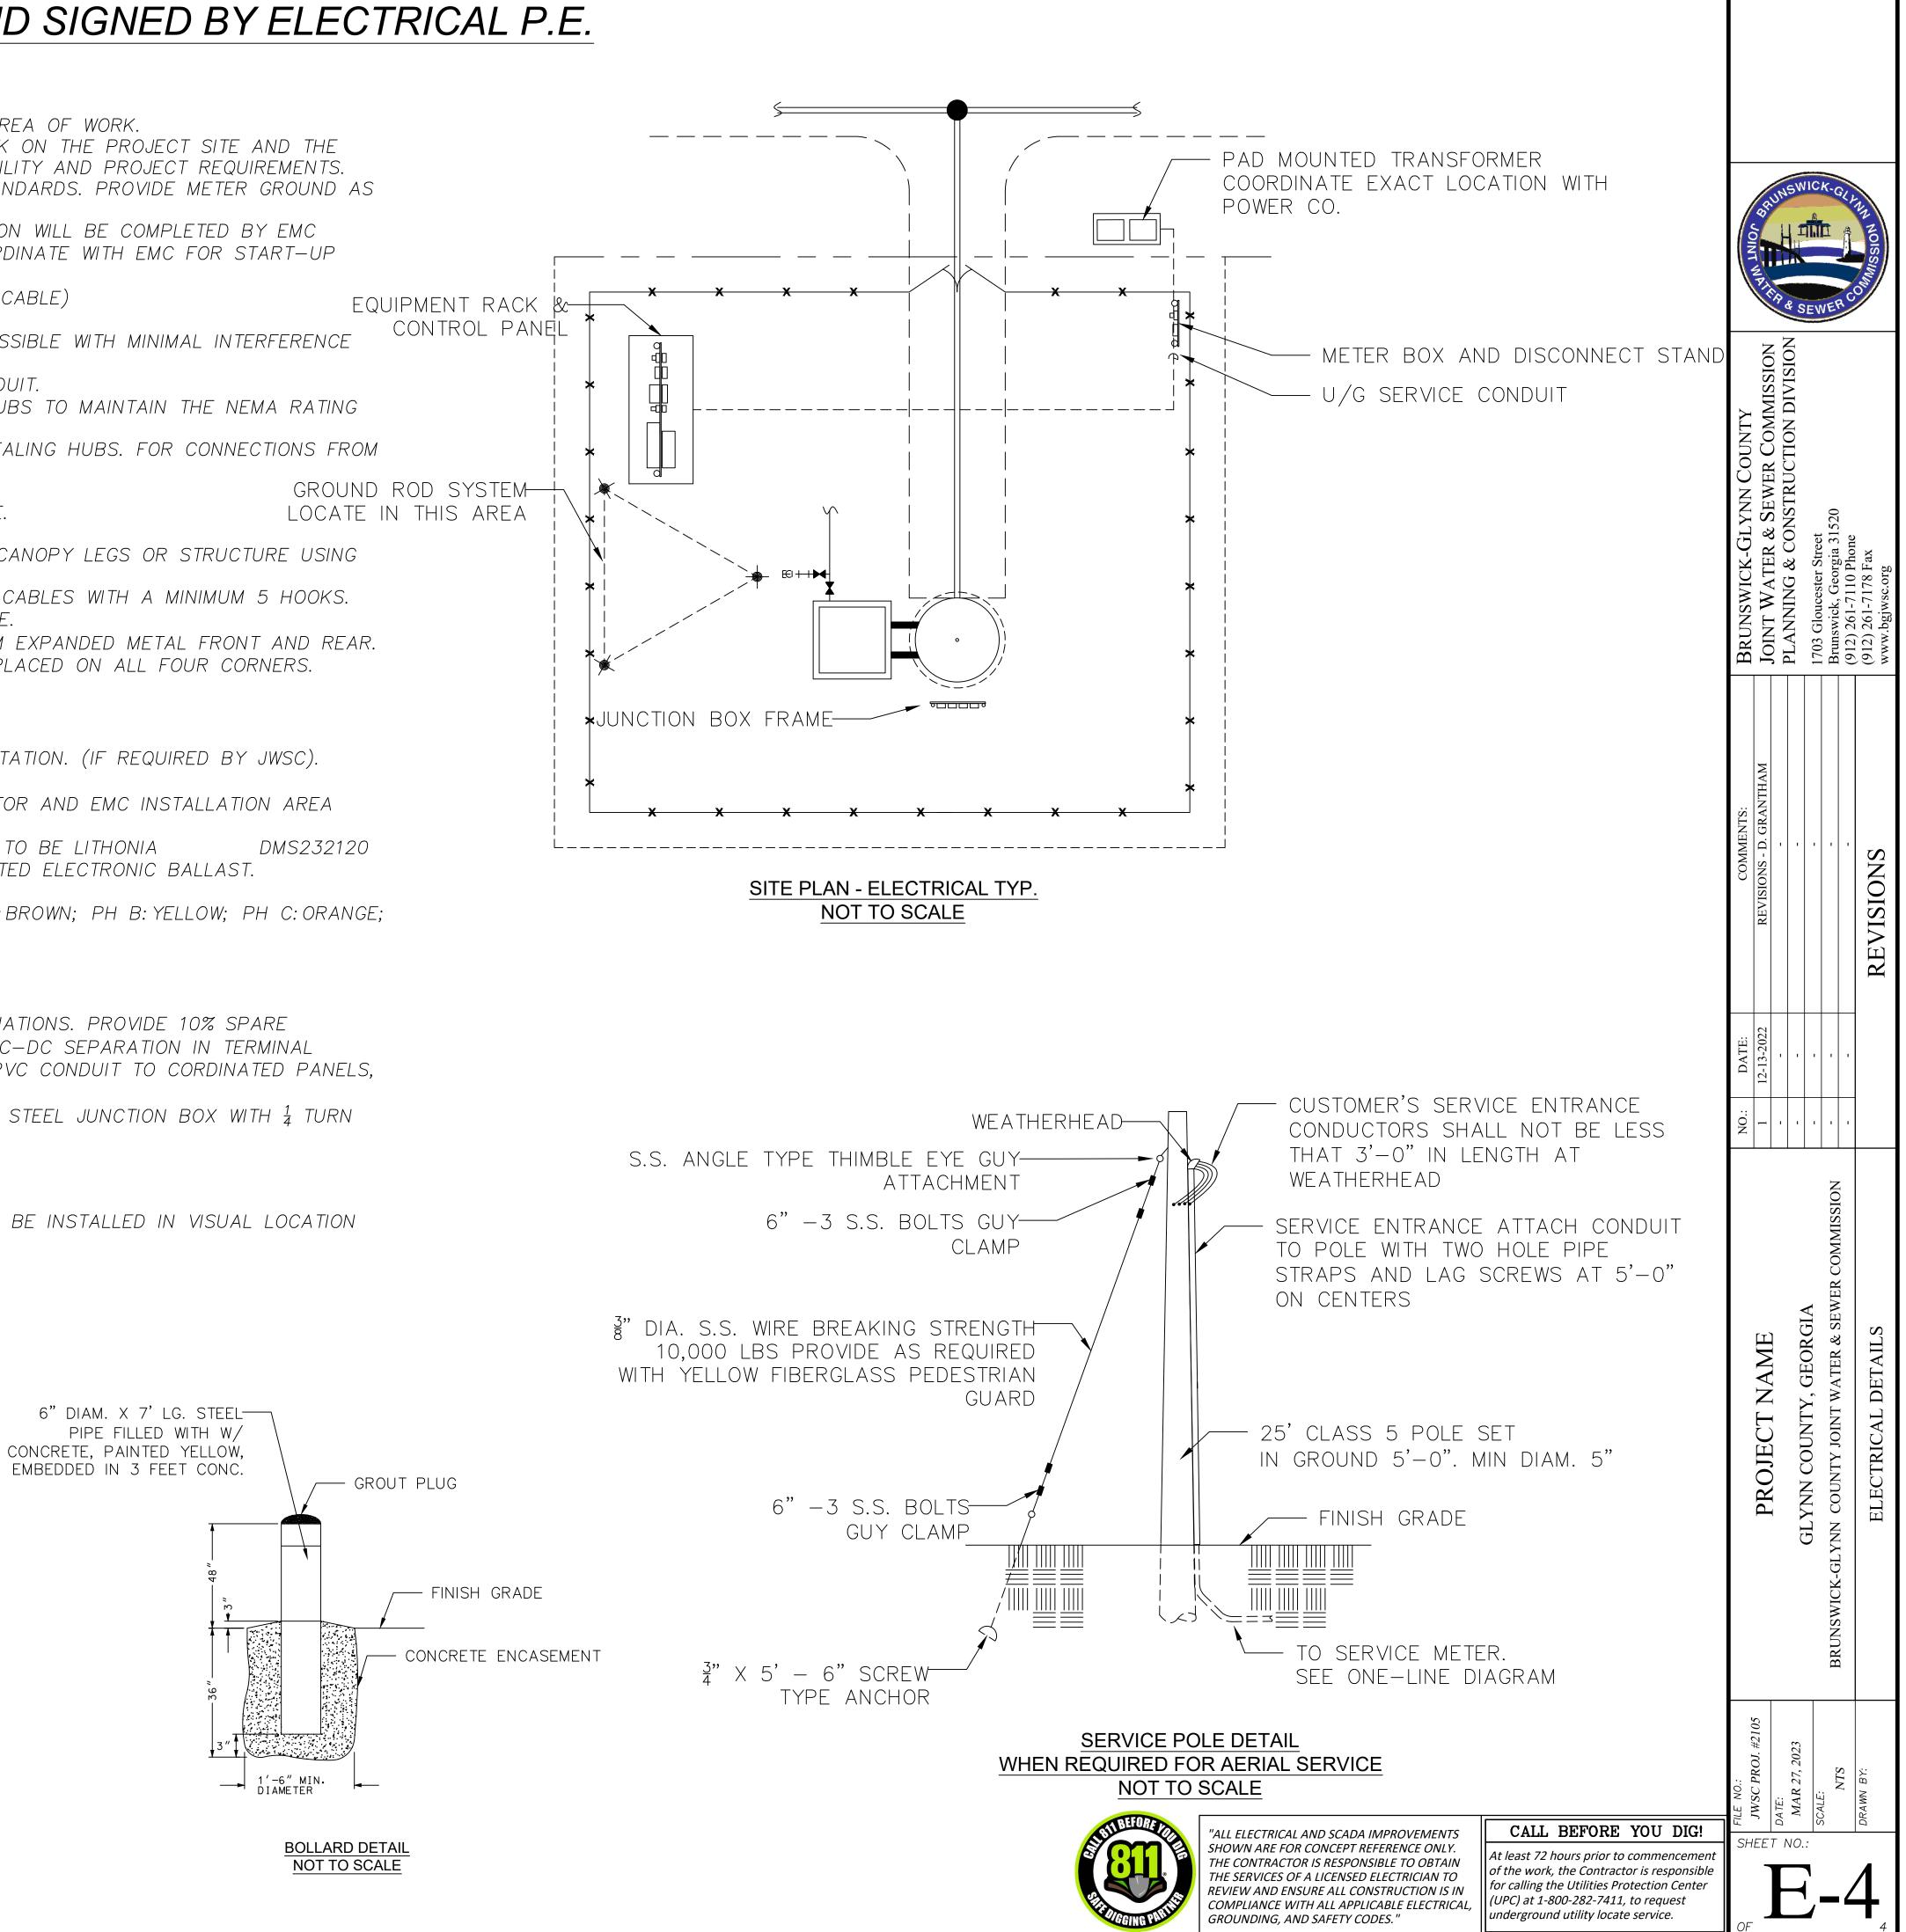

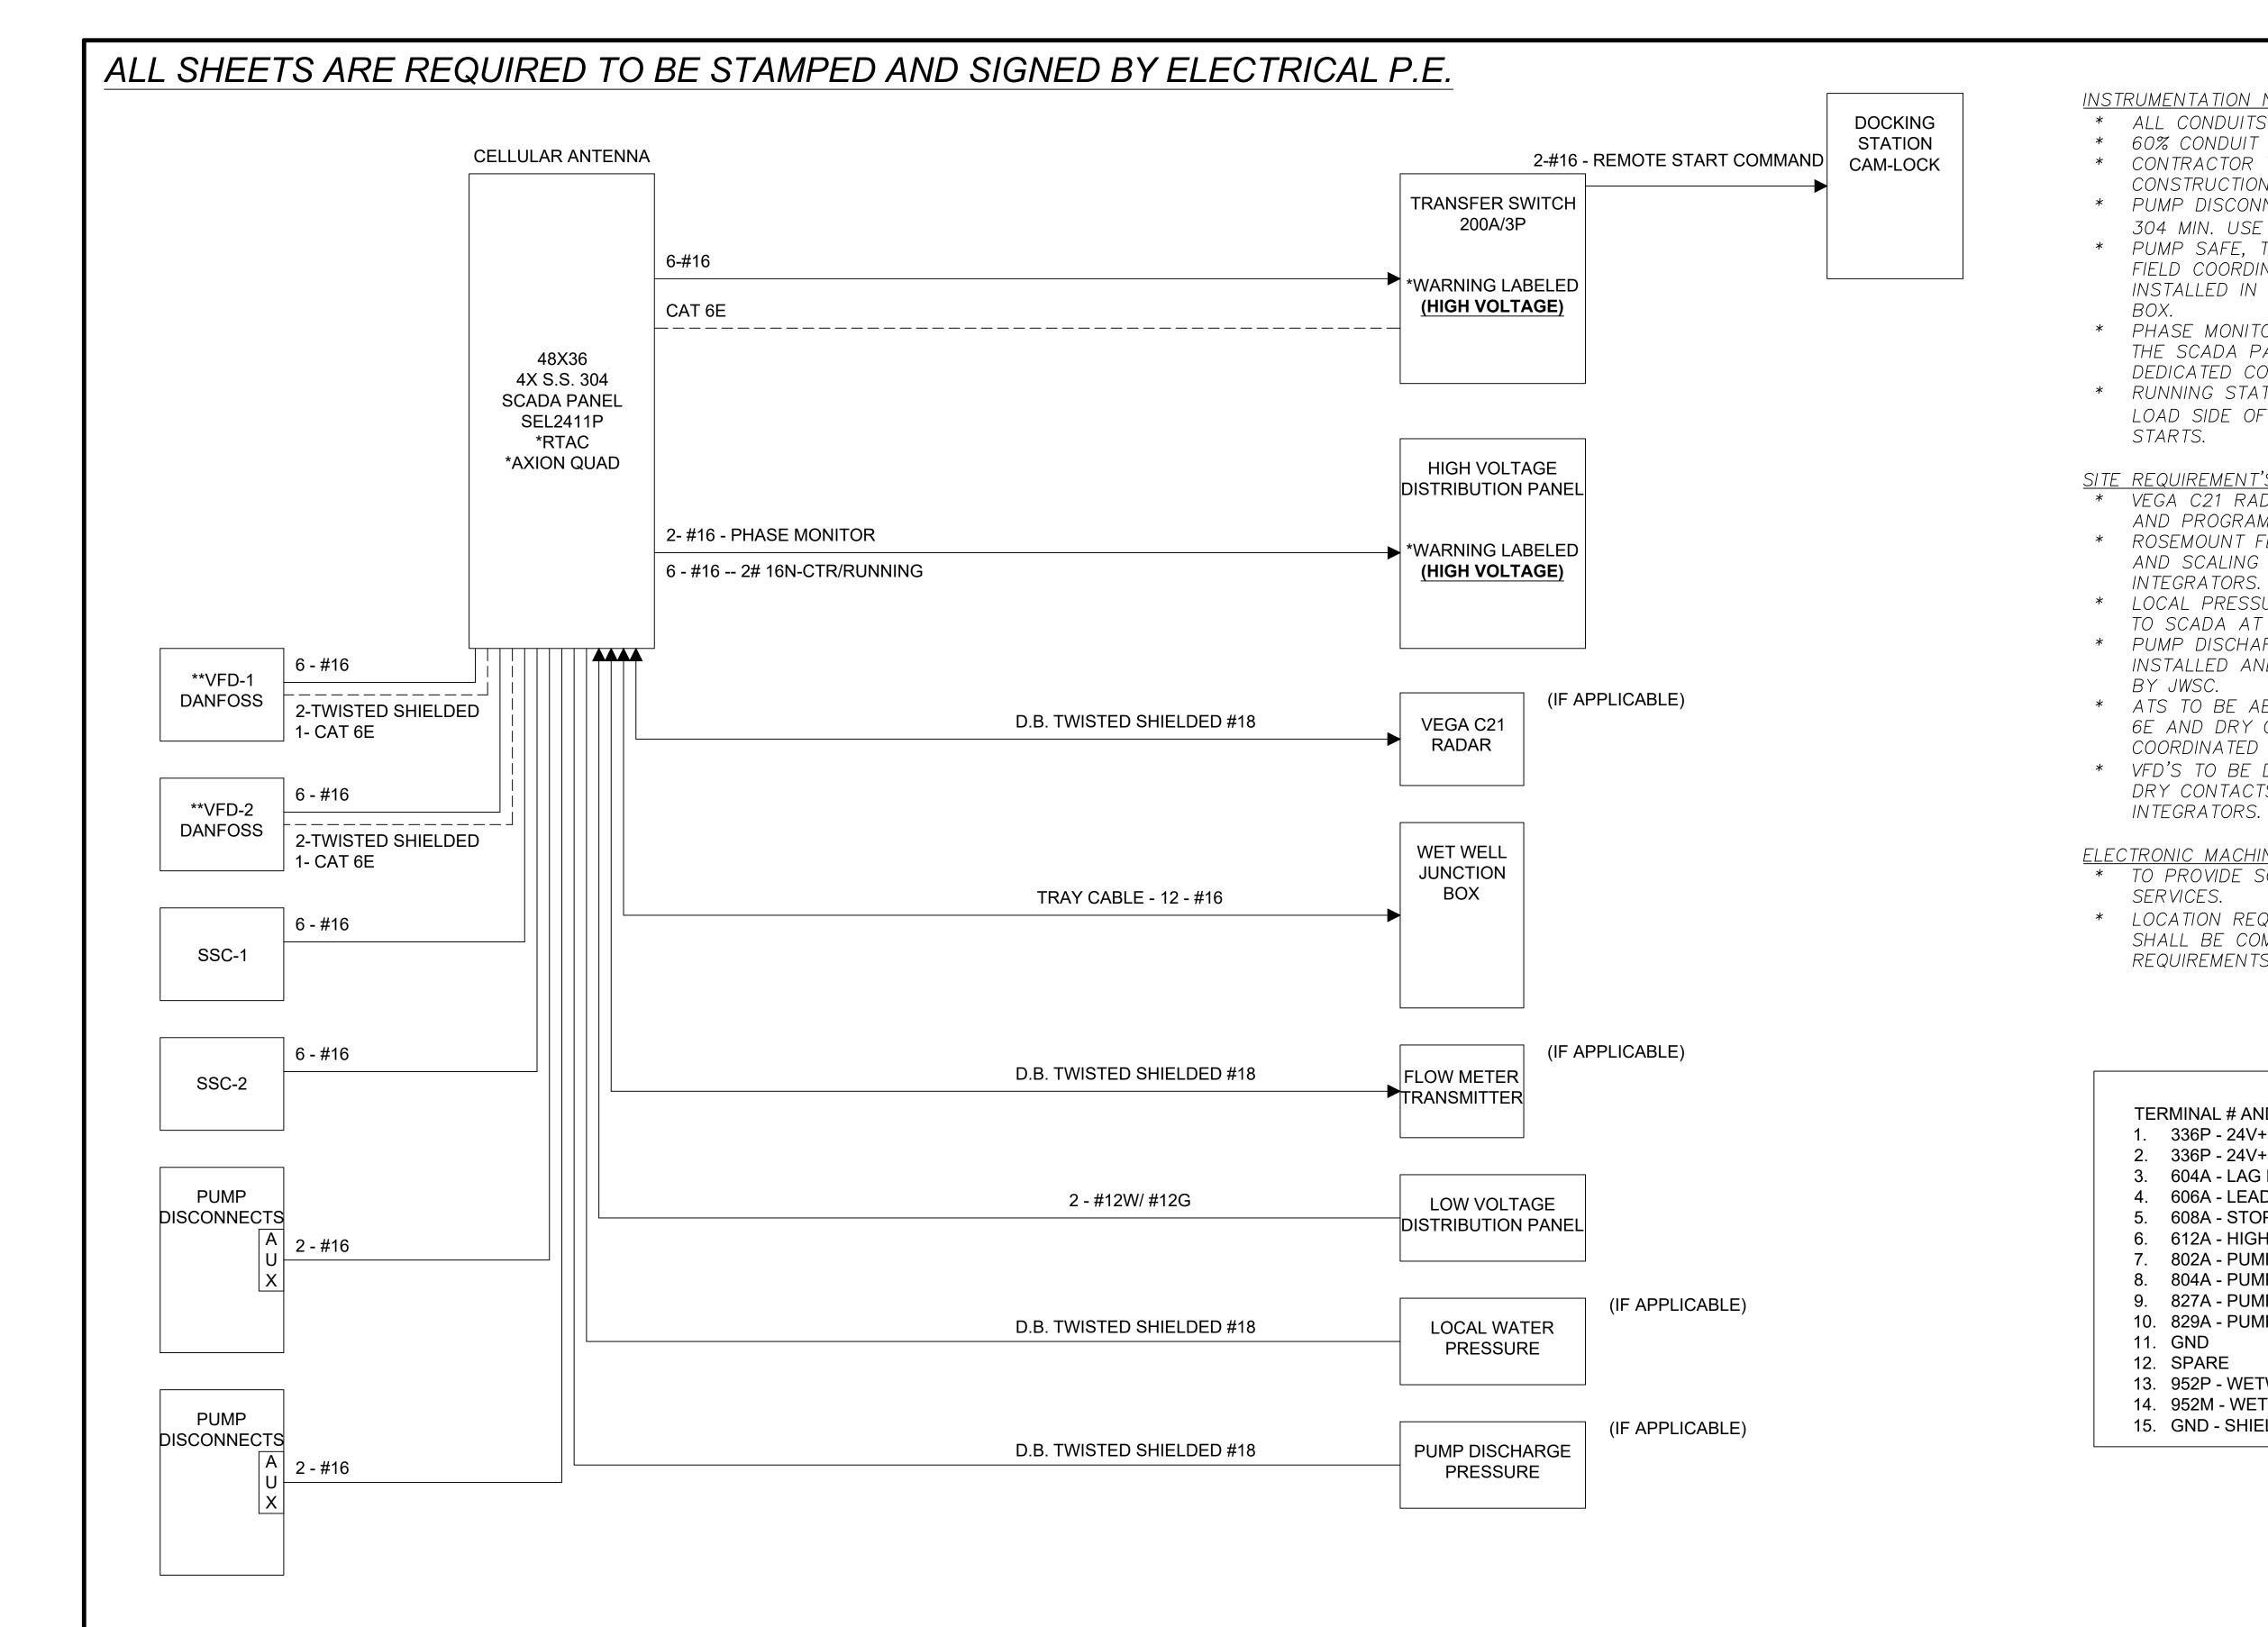


DANFOSS FC-202 NEMA 4X, CAT 6E AND TST TO BE INSTALLED AND COORDINATED WITH  INE CONTROL (EMC) SCHEDULED TERMINATION AND START-UP POURING MMR'S OR RTAC'S THE CONFIGURATION DMPLETED BY INTEGRATORS. ALL INSTALLATION TS SHALL BE COORDINATED WITH INTEGRATORS. WET WELL T.B. ND LABEL /+ /+ SFLOAT AD FLOAT AD FLOAT MP 1 THERMAL MP 2 SEAL FAIL MP 2 SEAL FAIL  TWELL LEVEL TRANSMITTER (+) ELD  IL ELECTRICA AND SCADA IMPROVEMENTS CALL BEFORE YOU DIC! SHOWN ARE FOR CONCEPT REFERENCE CONV.	FILE NO.:	C PROJ. #2109 	DATE: MAR 27. 2023	MAK 27, 2023 GLYNN COUNTY, GEORGIA			C TVDICAL INICTDITATION DEVICATION	WW JWSCTYPICAL INSTRUMENTATION KEVISIONS KEVISIONS
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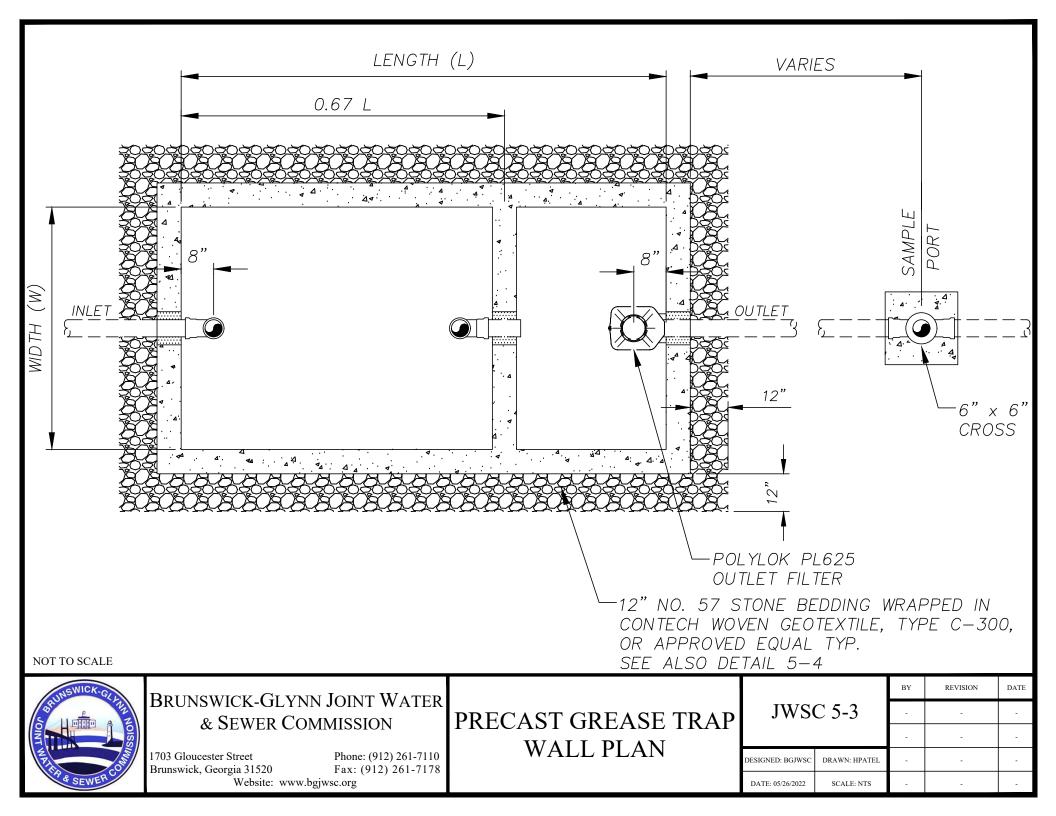



REVIEW AND ENSURE ALL CONSTRUCTION IS IN<br/>COMPLIANCE WITH ALL APPLICABLE ELECTRICAL,<br/>GROUNDING, AND SAFETY CODES."for calling the Utilities Protection Center<br/>(UPC) at 1-800-282-7411, to request<br/>underground utility locate service.


- 1. PRECAST CONCRETE TANKS TO BE MANUFACTURED IN ACCORDANCE WITH ASTM C1613 "STANDARD SPECIFICATION FOR PRECAST CONCRETE GREASE INTERCEPTOR TANKS.
- 2. THE INTERIOR SURFACES OF THE TANK SHALL BE SEALED WITH CONSEAL CS55 OR AN EQUIVALENT MOISTURE BARRIER SEAL. THE TANK INTERIOR SHALL BE LIGHT GRAY OR WHITE IN COLOR.
- 3. ALL PIPE AND FITTINGS SHALL BE TYPE I SCHEDULE 40 PVC MEETING THE REQUIREMENTS OF ASTM D2665.
- 4. INLET AND OUTLET PIPES SHALL BE SEALED WITH A CAST IN PLACE LOW-PRESSURE PIPE SEAL OR EQUIVALENT NEOPRENE GASKET, FLEXIBLE SILICON ADHESIVE OR CEMENT.
- 5. THE SAMPLE PORT SHALL CONSIST OF A OR 6"X6" PVC CROSS. VALVE BOX TO HAVE THE WORD "SEWER" STAMPED ON THE LID.
- 6. ACCESS TUBES OR RISERS SHALL BE HIGH DENSITY POLYETHYLENE (HDPE) PIPE CONFORMING TO ASTM D1248 (TYPE III C, CATEGORY 5, P34) OR PRECAST CONCRETE SEALED AS NOTED ABOVE.
- 7. MANHOLE FRAME AND COVERS SHALL BE MANUFACTURED FROM DUCTILE IN ACCORDANCE WITH ISO 1083, RATED AT H20 LOADING.
- 8. SEE SECTION 5 OF THE JWSC STANDARDS FOR WATER AND SEWER DESIGN AND CONSTRUCTION.





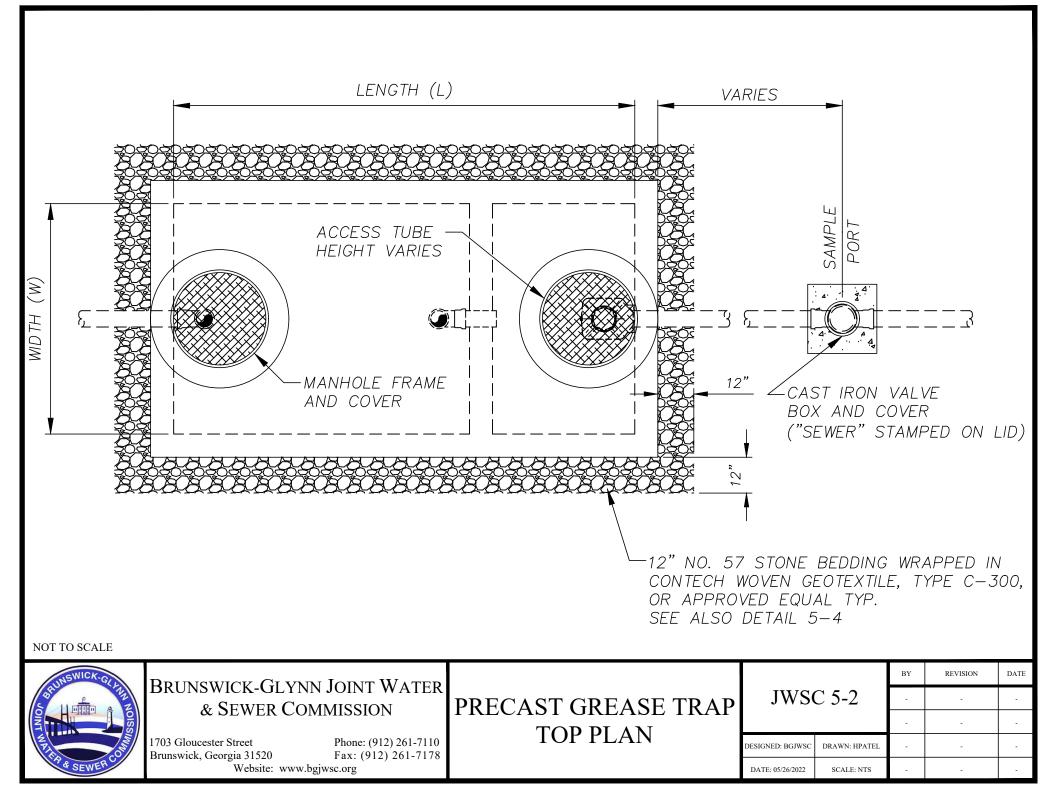

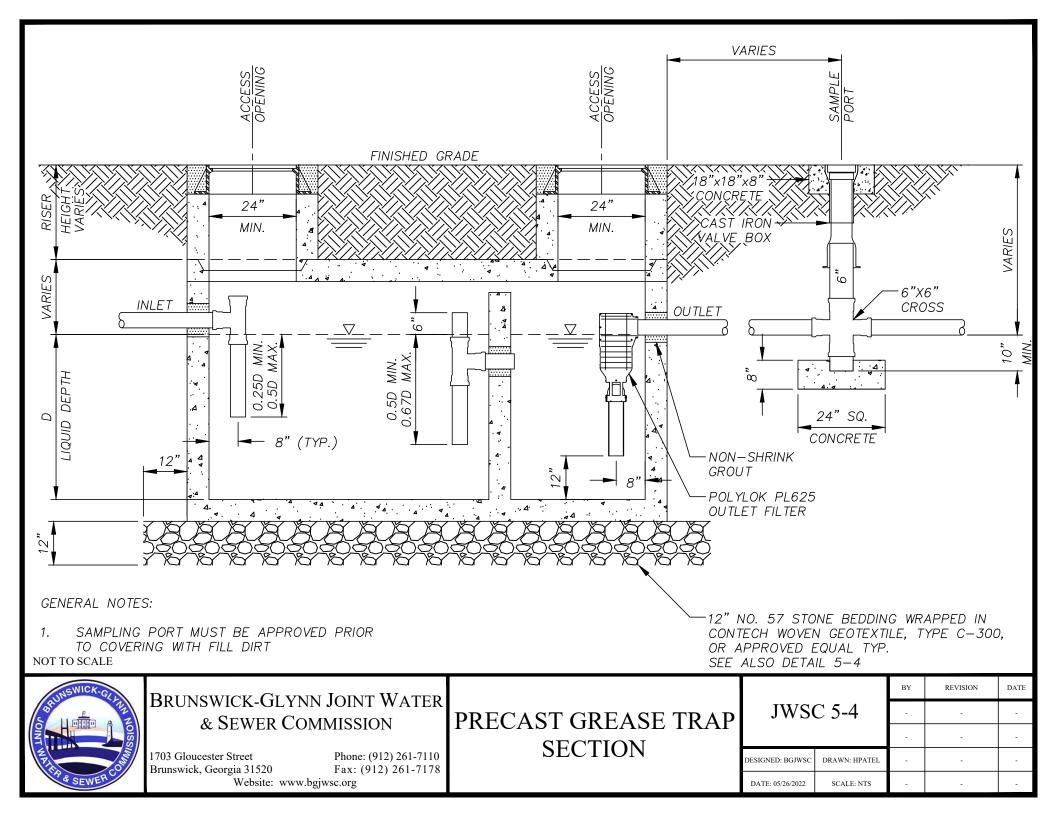

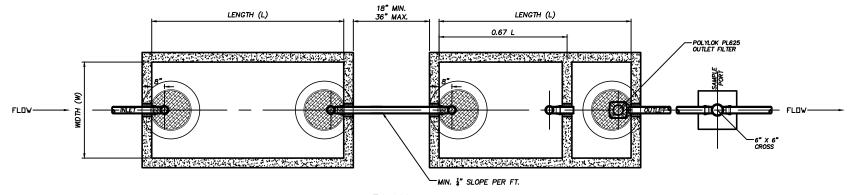

ACCESS

24

MIN

S S 50

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VARIES

18"X18"X8" CONCRETE

-CAST IRON VALVE BOX

j5]≣

CROSS

24" SQ

CONCRETE

-12" #57 STONE BEDDING WRAPPED IN CONTECH WOVEN GEOTEXTILE, TYPE C-300, OR APPROVED EQUAL TYP.

-POLYLOK PL625 OUTLET FILTER

ACCESS

24'

MIN

18



ACCESS

24

MIN

INLET AND OUTLET PIPE

FITTING STANDARD

ACCESS

24

MIN

GROUNE

12" TYP

#### GENERAL NOTES:

PRECAST CONCRETE TANKS TO BE MANUFACTURED IN ACCORDANCE WITH ASTM C1613 "STANDARD SPECIFICATION FOR PRECAST CONCRETE GREASE INTERCEPTOR TANKS.

THE INTERIOR SURFACES OF THE TANK SHALL BE SEALED WITH CONSEAL CSS5 OR AN EQUIVALENT MOISTURE BARRIER SEAL. THE TANK INTERIOR SHALL BE LIGHT GRAY OR WHITE IN COLOR.

ALL PIPE AND FITTINGS SHALL BE TYPE I SCHEDULE 40 PVC MEETING THE REQUIREMENTS OF ASTM D2665.

INLET AND OUTLET PIPES SHALL BE SEALED WITH A CAST IN PLACE LOW-PRESSURE PIPE SEAL OR EQUIVALENT NEOPRENE GASKET, FLEXIBLE SILICON ADHESIVE OR CEMENT.

THE SAMPLE PORT SHALL CONSIST OF A 6"X6" PVC CROSS. VALVE BOX TO HAVE THE WORD "SEWER" STAMPED ON THE LD.

ACCESS TUBES OR RISERS SHALL BE HIGH DENSITY POLYETHYLENE (HOPE) PIPE CONFORMING TO ASTM D1248 (TYPE III C, CATEGORY 5, P34) OR PRECAST CONCRETE SEALED AS NOTED ABOVE.


MANHOLE FRAME AND COVERS SHALL BE MANUFACTURED FROM DUCTILE IN ACCORDANCE WITH ISO 1083, RATED AT H2O LOADING.

SEE SECTION 5 OF THE JWSC STANDARDS FOR WATER AND SEWER DESIGN AND CONSTRUCTION.

12" #57 STONE BEDDING WRAPPED IN CONTECH WOVEN GEOTEXTILE, TYPE C-300, OR APPROVED EQUAL TYP.



SECTION

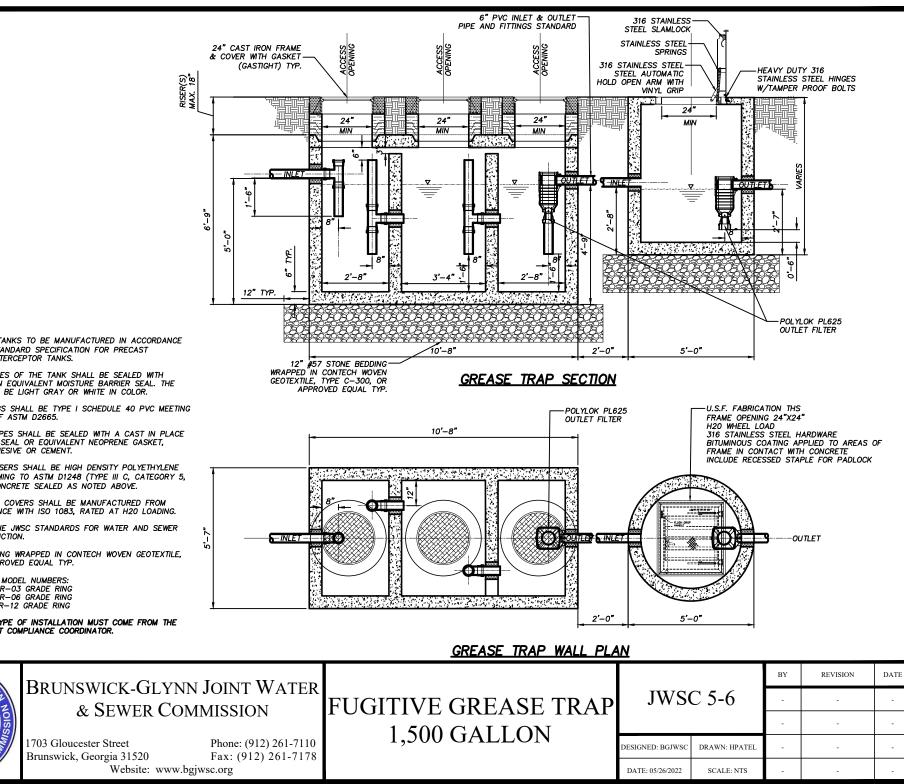

PRECAST CONCRETE TANKS TO BE MANUFACTURED IN ACCORDANCE WITH ASTM C1613 "STANDARD SPECIFICATION FOR PRECAST CONCRETE GREASE INTERCEPTOR TANKS.

THE INTERIOR SURFACES OF THE TANK SHALL BE SEALED WITH CONSEAL CS55 OR AN EQUIVALENT MOISTURE BARRIER SEAL. THE TANK INTERIOR SHALL BE LIGHT GRAY OR WHITE IN COLOR.

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INLET AND OUTLET PIPES SHALL BE SEALED WITH A CAST IN PLACE LOW-PRESSURE PIPE SEAL OR EQUIVALENT NEOPRENE GASKET, FLEXIBLE SILICON ADHESIVE OR CEMENT.

ACCESS TUBES OR RISERS SHALL BE HIGH DENSITY POLYETHYLENE (HDPE) PIPE CONFORMING TO ASTM D1248 (TYPE III C, CATEGORY 5, P34) OR PRECAST CONCRETE SEALED AS NOTED ABOVE.

MANHOLE FRAME AND COVERS SHALL BE MANUFACTURED FROM DUCTILE IN ACCORDANCE WITH ISO 1083. RATED AT H20 LOADING.

SEE SECTION 5 OF THE JWSC STANDARDS FOR WATER AND SEWER DESIGN AND CONSTRUCTION.


12" #57 STONE BEDDING WRAPPED IN CONTECH WOVEN GEOTEXTILE. TYPE C-300, OR APPROVED EQUAL TYP.

GRADE RINGS/RISERS MODEL NUMBERS: 3-INCH: 2432 GR-03 GRADE RING 6-INCH: 2432 GR-06 GRADE RING 12-INCH: 2432 GR-12 GRADE RING

APPROVAL OF THIS TYPE OF INSTALLATION MUST COME FROM THE JWSC PRE-TREATMENT COMPLIANCE COORDINATOR.

NOT TO SCALE



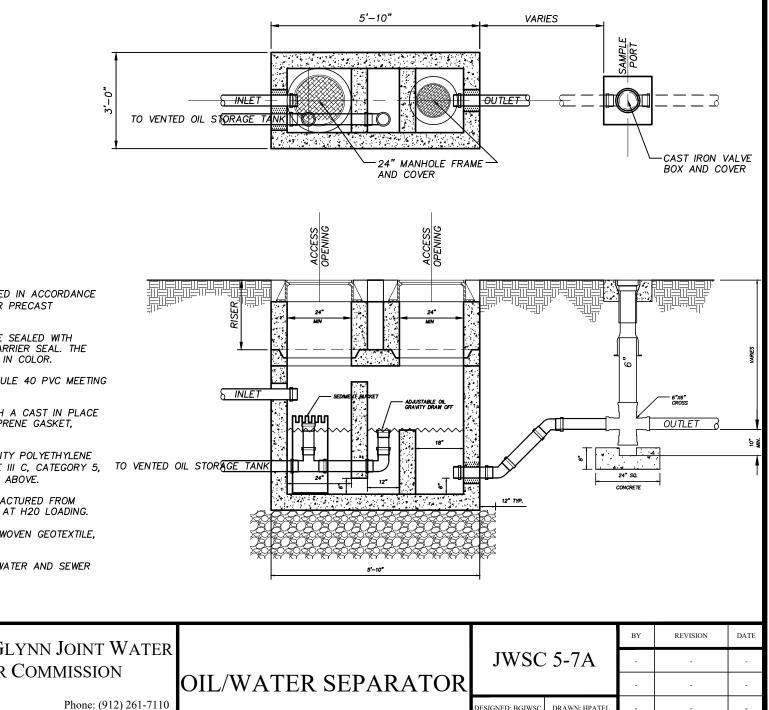

PRECAST CONCRETE TANKS TO BE MANUFACTURED IN ACCORDANCE WITH ASTM C1613 "STANDARD SPECIFICATION FOR PRECAST CONCRETE GREASE INTERCEPTOR TANKS.

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ACCESS TUBES OR RISERS SHALL BE HIGH DENSITY POLYETHYLENE (HDPE) PIPE CONFORMING TO ASTM D1248 (TYPE III C, CATEGORY 5, TO VENTED OIL STORAGE TANK P34) OR PRECAST CONCRETE SEALED AS NOTED ABOVE.


MANHOLE FRAME AND COVERS SHALL BE MANUFACTURED FROM DUCTILE IN ACCORDANCE WITH ISO 1083. RATED AT H20 LOADING.

12" #57 STONE BEDDING WRAPPED IN CONTECH WOVEN GEOTEXTILE. TYPE C-300, OR APPROVED EQUAL TYP.

SEE SECTION 5 OF THE JWSC STANDARDS FOR WATER AND SEWER DESIGN AND CONSTRUCTION.

#### NOT TO SCALE

UNSWICK-GLL	BRUNSWICK-GLYNN JOINT WATER & SEWER COMMISSION		OIL/WATER SEPARATOR	JWSC 5-7A		BY	REVISION	DATE
						-	-	-
		-				-	-	
The state of the s	1703 Gloucester Street Brunswick, Georgia 31520	Phone: (912) 261-7110 Fax: (912) 261-7178		DESIGNED: BGJWSC	DRAWN: HPATEL	-	-	-
7 & SEWER	Website: www	( )		DATE: 12/04/2023	SCALE: NTS	-	-	-

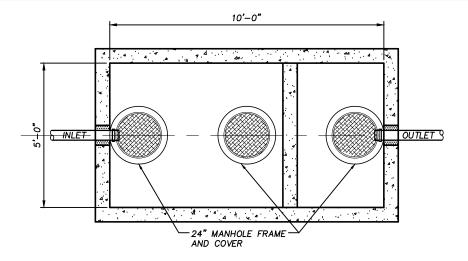

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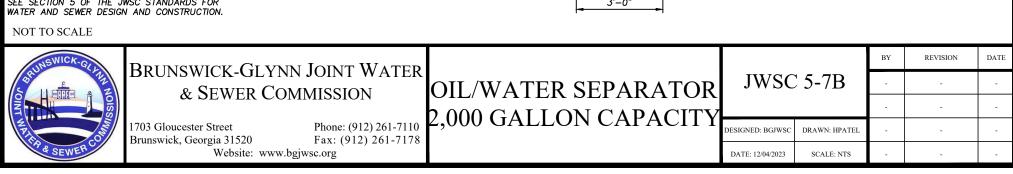
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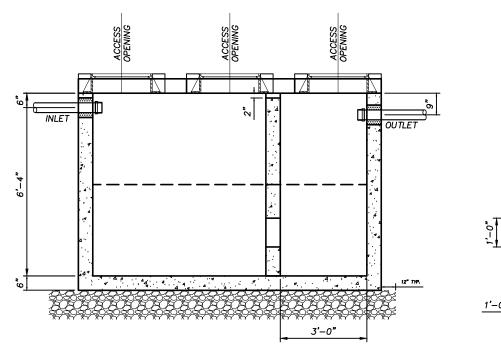
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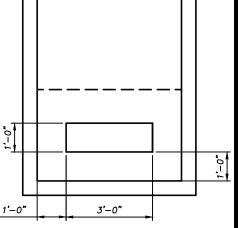
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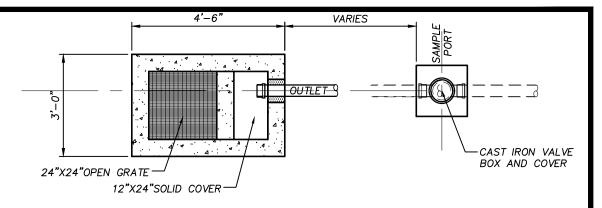
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SEE SECTION 5 OF THE JWSC STANDARDS FOR









MULTIPLE FLOOR DRAINS MAY DISCHARGE INTO ONE SAND INTERCEPTOR.

SAND INTERCEPTORS SHALL BE BUILT OF BRICK OR CONCRETE OR OTHER WATER TIGHT MATERIAL. THE INTERCEPTOR SHALL HAVE AN INTERIOR BAFFLE FOR FULL SEPARATION OF THE INTERCEPTOR INTO TWO SECTIONS. THE OUTLET PIPE SHALL BE THE 6" MIN.

THE SAND INTERCEPTOR SHALL HAVE A MINIMUM DIMENSION OF TWO FEET SQUARE FOR THE NET FREE OPENING OF THE INLET SCREEN AND A MINIMUM DEPTH UNDER THE INVERT OF THE OUTLET PIPE OF TWO FEET.

FOR EACH FIVE GALLON PER MINUTE FLOW OR FRACTION THEREOF OVER 20 GALLONS PER MINUTE, THE AREA OF THE SAND INTERCEPTOR INLET SECTION IS TO BE INCREASED BY ONE SQUARE FOOT. THE OUTLET SECTION SHALL AT ALL TIMES HAVE A MINIMUM AREA OF 50 PERCENT OF THE INLET SECTIONS.

THE OUTLET SECTION SHALL BE COVERED BY A SOLID REMOVABLE COVER SET FLUSH WITH THE FINISHED FLOOR, AND THE INLET SECTION SHALL HAVE AN OPEN GRATE SET FLUSH WITH THE FINISHED FLOOR AND SUITABLE FOR TRAFFIC IN THE AREA IN WHICH IT IS LOCATED.

SAND AND SIMILAR INTERCEPTORS FOR EVERY SOLID SHALL SO BE DESIGNED AND LOCATED AS TO BE READILY ACCESSIBLE FOR CLEANING, SHALL HAVE A WATER SEAL OF NOT LESS THAT SIX INCHES, AND SHALL BE VENTED.

ALTERNATE DESIGNS FOR CONSTRUCTION OR BAFFLING OF SAND INTERCEPTORS COMPLYING WITH THE INTENT OF THIS CODE MAY BE SUBMITTED TO THE PRE-TREATMENT COMPLIANCE COORDINATOR FOR REVIEW/APPROVAL.

#### NOT TO SCALE




### BRUNSWICK-GLYNN JOINT WATER & SEWER COMMISSION


Phone: (912) 261-7110 Fax: (912) 261-7178

1703 Gloucester Street Phon Brunswick, Georgia 31520 Fax: Website: www.bgjwsc.org

## SAND/SOLID SEPARATOR

		BY	REVISION	DATE
JWS	C <b>5-</b> 8	-	-	-
		-	_	-
DESIGNED: BGJWSC	DRAWN: HPATEL	-	-	-
DATE: 12/04/2023	SCALE: NTS	-	-	-

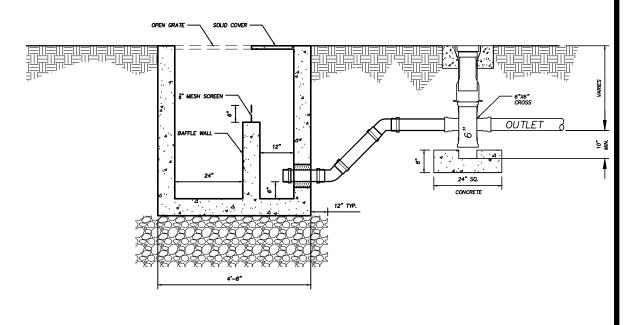

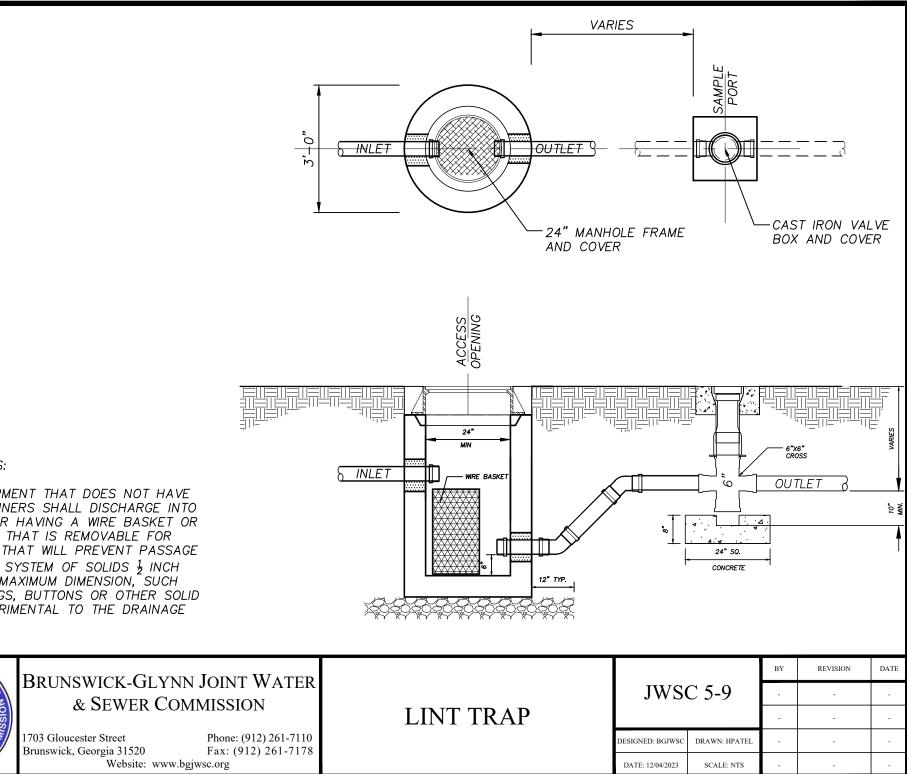

LAUNDRY EQUIPMENT THAT DOES NOT HAVE INTEGRAL STRAINERS SHALL DISCHARGE INTO AN INTERCEPTOR HAVING A WIRE BASKET OR SIMILAR DEVICE THAT IS REMOVABLE FOR CLEANING AND THAT WILL PREVENT PASSAGE INTO DRAINAGE SYSTEM OF SOLIDS  $\frac{1}{2}$  INCH OR LARGER IN MAXIMUM DIMENSION, SUCH AS STRING, RAGS, BUTTONS OR OTHER SOLID MATERIALS DETRIMENTAL TO THE DRAINAGE SYSTEM.

NOT TO SCALE

SEW