

2016 SPLOST NORTH MAINLAND PH-II PUMP STATION IMPROVEMENTS BRUNSWICK, GA





BRUNSWICK-GLYNN JOINT WATER AND SEWER COMMISSION 1703 GLOUCESTER ST, BRUNSWICK, GA 31520

COMMISSION MEMBERS

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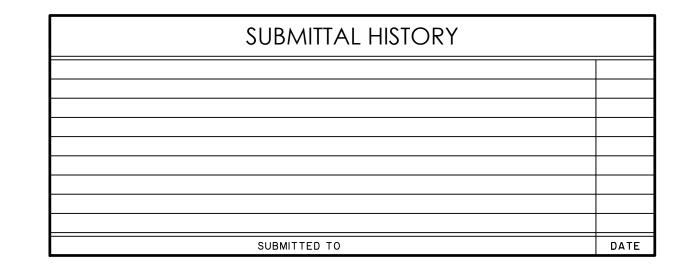
JANUARY 2020


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PREPARED BY:







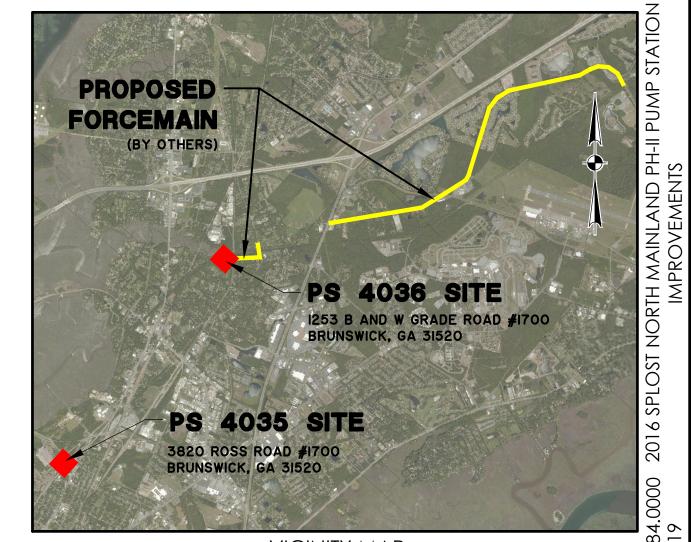

VICINITY MAP SCALE: 1" = 5000'

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	REVISION HISTORY		
REV. NO.	REVISION	BY	DATE





50 Park of Commerce Way Savannah, GA 31405 p.912.234.5300 www.thomasandhutton.com

GENERAL NOTES:

- TOPOGRAPHIC INFORMATION FOR NORTH MAINLAND PHASE II AND III IMPROVEMENTS IS BASED ON SURVEY DATA PREPARED BY THOMAS & HUTTON. CONTRACTOR SHALL BE RESPONSIBLE FOR LOCATING ALL UNDERGROUND UTILITIES AND OTHER SALIENT FEATURES PRIOR TO BEGINNING CONSTRUCTION.
- 2. CONTRACTOR SHALL VERIFY THE SIZE AND LOCATION OF ALL EXISTING UTILITIES PRIOR TO BEGINNING CONSTRUCTION. CONTACT ENGINEER IMMEDIATELY WITH ANY DISCREPANCIES.
- 3. ALL ELEVATIONS REFER TO NAVD 88.
- 4. THE CONTRACTOR SHALL GRASS ALL AREAS DISTURBED BY CONSTRUCTION IMMEDIATELY AFTER THE DISTURBANCE.
- 5. THE CONTRACTOR SHALL PROTECT AND SAVE ALL SPECIMEN TREES AND/OR ANY TREE DESIGNATED ON THE PLANS OR BY THE OWNER. CONTRACTOR TO PROTECT AND SAVE TREES BY INSTALLING 4 FOOT HIGH TEMPORARY ORANGE CONSTRUCTION FENCE AROUND THE TREE.
- 6. CONTRACTOR SHALL COORDINATE CONSTRUCTION ACTIVITIES WITH LOCAL UTILITY COMPANIES. CONTRACTOR SHALL BE RESPONSIBLE FOR PROTECTION AND ANY NECESSARY REPAIRS TO EXISTING UTILITY LINES AT NO COST TO THE UTILITY OWNER.
- 7. THE CONTRACTOR WILL NOTIFY THE ENGINEER IF UNSUITABLE MATERIAL IS DISCOVERED PRIOR TO BEGINNING ANY REMOVAL OPERATION.
- 8. CONTRACTOR IS RESPONSIBLE FOR ALL NECESSARY BRACING, SHEETING AND DEWATERING TO COMPLETE THE PROJECT, PROTECT THE CONSTRUCTION WORKERS AND ALL ADJACENT STRUCTURES, TREES, LANDSCAPING, AND IS RESPONSIBLE FOR ALL REPAIR AND COST TO RETURN AREA TO ORIGINAL CONDITION.
- 9. CONTRACTOR TO VERIFY LOCATION AND DEPTH OF ALL EXISTING UTILITIES BEFORE BEGINNING ANY CONSTRUCTION (1-800-282-7411 OR 811).
- 10. ALL UTILITY POLES ADJACENT TO PROPOSED CONSTRUCTION MUST BE SECURED PRIOR TO ANY ADJACENT DISTURBANCE AND THE CONSTRUCTION PROCEDURE MUST BE ACCEPTABLE TO THE UTILITY COMPANY.
- 11. CONTROL OF STORMWATER THROUGHOUT THE CONSTRUCTION PERIOD, SHALL BE THE RESPONSIBILITY OF THE CONTRACTOR. THE EXISTING DRAINAGE CONVEYANCES SHALL BE MAINTAINED THROUGHOUT THE CONSTRUCTION PERIOD. ALL PENALTIES, CLAIMS AND FEES IMPOSED ON THE OWNER AS A RESULT OF DAMAGE CAUSED BY ACTIONS OF THE CONTRACTOR, THEIR EMPLOYEES OR SUBCONTRACTORS SHALL BE BORNE IN FULL BY THE CONTRACTOR.
- 12. ALL SUITABLE MATERIAL EXCAVATED DURING UTILITY CONSTRUCTION SHALL BE USED ON SITE. ANY EXCESS MATERIAL SUITABLE OR UNSUITABLE SHALL BE DISPOSED OF OFF-SITE AT THE CONTRACTOR'S EXPENSE.
- 13. THE CONTRACTOR SHALL CONTACT ALL UTILITY COMPANIES BEFORE WORK COMMENCES, VERIFY UTILITIES WITHIN THE PROJECT LIMITS AND NOTIFY THE ENGINEER OF CONFLICTS OR VARIANCES TO THE PLANS PRIOR TO BEGINNING WORK OR PURCHASE OF MATERIALS.
- 14. IT IS THE OBLIGATION OF THE CONTRACTOR TO MAKE THEIR OWN INTERPRETATION OF ALL SURFACE AND SUBSURFACE DATA AVAILABLE AS TO THE NATURE AND EXTENT OF THE MATERIALS TO BE EXCAVATED, WASTED, GRADED, AND COMPACTED. THE INFORMATION SHOWN ON THESE PLANS IN NO WAY GUARANTEES THE AMOUNT OR NATURE OF THE MATERIAL TO BE ENCOUNTERED.
- 15. THE CONTRACTOR SHALL BE RESPONSIBLE FOR ALL TRAFFIC CONTROL DEVICES AND MEASURES AS NECESSARY TO MEET THE REQUIREMENTS OF THE GEORGIA MANUAL ON UNIFORM TRAFFIC CONTROL DEVICES (GA MUTCD). CONTRACTOR SHALL SUBMIT A TRAFFIC CONTROL PLAN TO OWNER FOR REVIEW AND ACCEPTANCE PRIOR TO STARTING CONSTRUCTION.
- 16. ALL WORK SHALL CONFORM TO APPLICABLE STATE, COUNTY AND MUNICIPAL REQUIREMENTS AND CODES.
- 17. THE CONTRACTOR SHALL COORDINATE DEMOLITION AND IMPROVEMENTS TO MINIMIZE TRAFFIC INTERFERENCE AND OPERATIONS OF FACILITIES.
- 18. ALL CONSTRUCTION DEBRIS SHALL BE REMOVED FROM THE SITE AND DISPOSED OF IN AN ACCEPTABLE WASTE DISPOSAL AREA. THE CONTRACTOR SHALL BE RESPONSIBLE FOR DISPOSAL OF ALL CONSTRUCTION DEBRIS.
- 19. ALL STORM DRAIN JOINTS ARE TO BE WRAPPED IN FILTER FABRIC.
- 20. THE CONTRACTOR SHALL NOT BEGIN CONSTRUCTION UNTIL THE PROPER PERMITS HAVE BEEN ISSUED.
- 21. ALL WATER MAINS, FORCE MAINS AND GRAVITY SEWER SHALL HAVE A MINIMUM OF 3 FEET OF COVER MEASURED FROM FINISHED GRADE EXCEPT WHERE OTHERWISE NOTED ON THE
- 22. MAINTAIN A 10' HORIZONTAL SEPARATION BETWEEN ALL SANITARY SEWERS AND ALL WATER MAINS. WHERE THIS SEPARATION CANNOT BE MAINTAINED, OR WHERE LINES CROSS, PROVIDE A 18" MINIMUM VERTICAL SEPARATION BETWEEN THE OUTSIDE OF THE PIPES. IF THESE REQUIREMENTS CANNOT BE MET, PROPOSED WATERLINE WILL BE INSTALLED IN CASING PER JWSC SPECIFICATIONS.
- 23. ALL MANHOLE TOPS ARE APPROXIMATE. THE CONTRACTOR SHALL DETERMINE AND SET MANHOLE TOPS RELATIVE TO FINISHED GRADES AS SHOWN ON THE PLANS.
- 24. ANY DEFECTIVE, DAMAGED, OR UNSOUND PIPE SHALL BE REJECTED. ALL FOREIGN MATTER OR DIRT SHALL BE REMOVED FROM INSIDE OF PIPE BEFORE IT IS LOWERED INTO ITS POSITION IN THE TRENCH AND SHALL BE KEPT CLEAN BY ACCEPTED MEANS DURING AND AFTER LAYING. CARE SHALL BE TAKEN TO PREVENT DIRT FROM ENTERING THE JOINT SPACE. AT TIMES WHEN PIPE LAYING IS NOT IN PROGRESS THE ENDS OF THE PIPE SHALL BE CLOSED BY ACCEPTED MEANS AND NO TRENCH WATER SHALL BE PERMITTED IN THE PIPE.
- 25. ALL PVC SANITARY SEWER PIPE AND PVC FORCE MAIN PIPE SHALL BE GREEN IN COLOR. ALL PVC WATER MAIN PIPE SHALL BE BLUE IN COLOR. ALL PVC RELAIMED WATER PIPE SHALL BE PURPLE IN COLOR.

- 26. TREE PROTECTION BARRICADES, IF REQUIRED, SHALL BE INSTALLED PRIOR TO ANY CLEARING ACTIVITY AND MAINTAINED UNTIL INSTRUCTED BY THE OWNER OR ENGINEER TO REMOVE THEM.
- 27. DURING INSTALLATION, WHEN PIPE LAYING IS NOT IN PROGRESS, A MECHANICAL JOINT PLUG OR CAP, OR ACCEPTED EQUIVALENT WILL BE USED TO FORM A WATERTIGHT SEAL AT BOTH ENDS OF THE LINE
- 28. A #12 GAUGE INSULATED SINGLE STRAND COPPER WIRE SHALL BE STRAPPED TO ALL WATER AND SEWER PIPES. FOR RECLAIMED WATER PIPE USE #12 GAUGE INSULATED SINGLE STRAND COPPER WIRE, PURPLE IN COLOR.
- 29. DISCHARGE OF HIGHLY CHLORINATED WATER INTO SURROUNDING AREAS OR STORM DRAINAGE SYSTEM IS PROHIBITED. DISPOSAL OF HIGHLY CHLORINATED WATER SHALL COMPLY WITH THE REQUIREMENTS OF GEORGIA E.P.D. AND AWWA STANDARD C651, LATEST REVISION. IF REQUIRED BY THE ENGINEER, A REDUCING AGENT SHALL BE USED TO NEUTRALIZE THE CHLORINE.
- 30. ALL SIGNS, MAIL BOXES, SHRUBBERY, FENCES, LANDSCAPING OR EXISTING STRUCTURES INTERFERING WITH CONSTRUCTING SHALL BE REMOVED AND REPLACED BY THE CONTRACTOR AT THE CONTRACTOR'S EXPENSE.
- 31. THE CONTRACTOR SHALL IMMEDIATELY REPAIR ANY EXISTING WATER AND SEWER UTILITIES DAMAGED DURING CONSTRUCTION AT THE CONTRACTOR'S EXPENSE.
- 32. "AS-BUILT" DRAWINGS SHALL BE PROVIDED BY THE CONTRACTOR BASED ON A "RECORD SURVEY" OF CONSTRUCTED UTILITIES AND APPURTENANCES. THE RECORD SURVEY MUST BE COMPLETED AND SIGNED BY A REGISTERED LAND SURVEYOR. THE CONTRACTOR SHALL PROVIDE A SET OF "MARKED UP" AS BUILT DRAWINGS AS WELL AS A CD ROM CONTAINING THE AS BUILT INFORMATION IN ELECTRONIC FORM. AT A MINIMUM THE AS BUILT INFORMATION AND RECORD SURVEY SHALL INCLUDE VALVE AND BOX LOCATIONS, FRAME AND INVERT ELEVATIONS. THE LOCATIONS OF WATER PIPE, FITTINGS, RIP-RAP, SLEEVES, PAVING AND GRAVEL REPLACEMENT, STORM SEWER REPLACEMENT AND ALL OTHER CONSTRUCTION INSTALLATIONS.
- 33. ALL MATERIALS USED AND COME INTO CONTACT WITH DRINKING WATER DURING ITS DISTRIBUTION SHALL NOT ADVERSELY AFFECT DRINKING WATER QUALITY AND PUBLIC HEALTH AND MUST BE CERTIFIED FOR CONFORMANCE WITH AMERICAN NATIONAL STANDARDS INSTITUTE/NATIONAL SANITATION FOUNDATION STANDARD 61 (ANSI/NSF STANDARD 61).
- 34. UNDERGROUND UTILITIES ARE SHOWN ON PLANS ONLY WHERE THEY MAY BE CLOSE TO CONSTRUCTION ACTIVITY. THE CONTRACTOR IS RESPONSIBLE FOR FIELD LOCATION OF ALL UNDERGROUND UTILITIES PRIOR TO ANY EXCAVATION
- 35. ALL CONSTRUCTION WATER SHALL BE METERED THROUGH AN ACCEPTABLE HYDRANT METER AND BACKFLOW DEVICE OBTAINED FROM THE BGJWSC.
- 36. THE PROPERTY LINES AND RIGHT-OF-WAY LINES SHOWN ON THE DRAWINGS ARE APPROXIMATE AND ARE FOR INFORMATION ONLY. THEY HAVE NOT BEEN VERIFIED BY A PROPERTY SURVEY OR THOMAS & HUTTON.
- 37. ALL DISTURBED AREAS SHALL BE GRASSED WITH TEMPORARY SEEDING AND MULCHED IMMEDIATELY AFTER GRADING IS COMPLETE. THESE AREAS SHALL BE REGRASSED WITH PERMANENT SEEDING AFTER CONSTRUCTION IS COMPLETE.
- 38. ALL EROSION AND SEDIMENTATION CONTROL DEVICES SHALL BE CONSTRUCTED SIMULTANEOUSLY WITH THE DISTURBANCE OF THE LAND AND SHALL REMAIN FUNCTIONAL UNTIL THE CONTRIBUTING DISTURBED AREAS ARE
- 39. THE CONTRACTOR SHALL IMMEDIATELY REPAIR EXISTING WATER & SEWER SERVICES DAMAGED DURING CONSTRUCTION AT THE CONTRACTORS EXPENSE.
- 40. ALL CONNECTIONS TO THE EXISTING WATER AND SEWER SYSTEMS SHALL BE COORDINATED WITH THE BRUNSWICK-GLYNN COUNTY JOINT WATER & SEWER COMMISSION (BGJWSC). THE CONTRACTOR SHALL CONTACT BGJWSC AT (912) 261-7122 A MINIMUM OF 72 HOURS PRIOR TO CONSTRUCTION ACTIVITIES.
- 41. BYPASS PUMPING UNIT SHALL BE PRESENT AND READY TO OPERATE ON-SITE AT ALL TIMES WHILE IMPROVEMENT WORK IS IN PROGRESS. ALL TEMPORARY BYPASS PUMPING REQUIRED FOR REHAB WORK SHALL BE THE RESPONSIBILITY OF THE CONTRACTOR. NO SEPARATE MEASUREMENT OR PAYMENT WILL BE MADE FOR THESE PUMPING REQUIREMENTS. ALL LABOR, DESIGN, EQUIPMENT, MATERIALS, RENTAL FEES, TEMPORARY PIPING AND INCIDENTALS SHALL BE CONSIDERED A SUBSIDIARY OBLIGATION TO THE CONTRACT.
- 42. THE BGJWSC RESERVES FIRST RIGHT OF SALVAGE FOR ALL EQUIPMENT REMOVAL AT EACH SITE.
- 43. THE BGJWSC WILL RETAIN SALVAGE RIGHTS TO ALL MATERIALS AND EQUIPMENT RETAINED BY THE BGJWSC SHALL BE DELIVERED TO A PLACE DESIGNATED BY THE BGJWSC REPRESENTATIVE. ANY MATERIALS OR EQUIPMENT NOT RETAINED BY THE BGJWSC SHALL BE REMOVED FROM SITE AND DISPOSED OFF SITE BY THE CONTRACTOR IN ACCORDANCE WITH APPLICABLE REGULATION.
- 44. CONTRACTOR MUST PROVIDE ASSET INFORMATION IN A SPREADHSEET FOR ASSESTS PURCHASED ON A SINGLE LINE ITEM COSTING \$500 OR MORE. THE SPREADSHEET WILL BE USED TO UPDATE THE RECORDS IN THE BGJWSC ASSET MANAGEMENT DATABSE TO REFLECT EQUIPMENT IN THE PLANT.
- 45. CONTRACTOR SHALL NOTIFY THE RESPONSIBLE BGJWSC, PLANNING AND CONSTRUCTION DIVISION, 48 HOURS PRIOR TO BEGINNING CONSTRUCTION ON PROJECT.

24-HOUR CONTACT: JASON VO, PE **CAPITAL PROJECTS MANAGER** PHONE: 912-324-9905

BRUNSWICK-GLYNN JOINT WATER & SEWER COMMISSION PLANNING & CONSTRUCTION DIVISION PHONE: 912-261-7126

LEGEND:



BENCHMARK



COMPUTED POINT (NO MONUMENT)

CONC. MONUMENT FOUND

CURB INLET MANHOLE

EVERGREEN TREE

ELECTRIC METER

FIRE HYDRANT

FLOOD LIGHT

GRATE INLET

IRON REBAR FOUND

IRON PIPE FOUND

GUY WIRE

IRON REBAR SET 5/8"

LIGHT POLE

MAIL BOX

POST



PALM TREE

OAK TREE

POWER POLE

STORM DRAINAGE MANHOLE

SANITARY MANHOLE

TELEPHONE BOX

TRAFFIC SWITCH BOX

WATER MANHOLE

WATER METER

WATER VALVE

LAUREL OAK (SIZE AS NOTED)

LIVE OAK (SIZE AS NOTED)

PALM (SIZE AS NOTED)

PINE (SIZE AS NOTED)

WETLANDS



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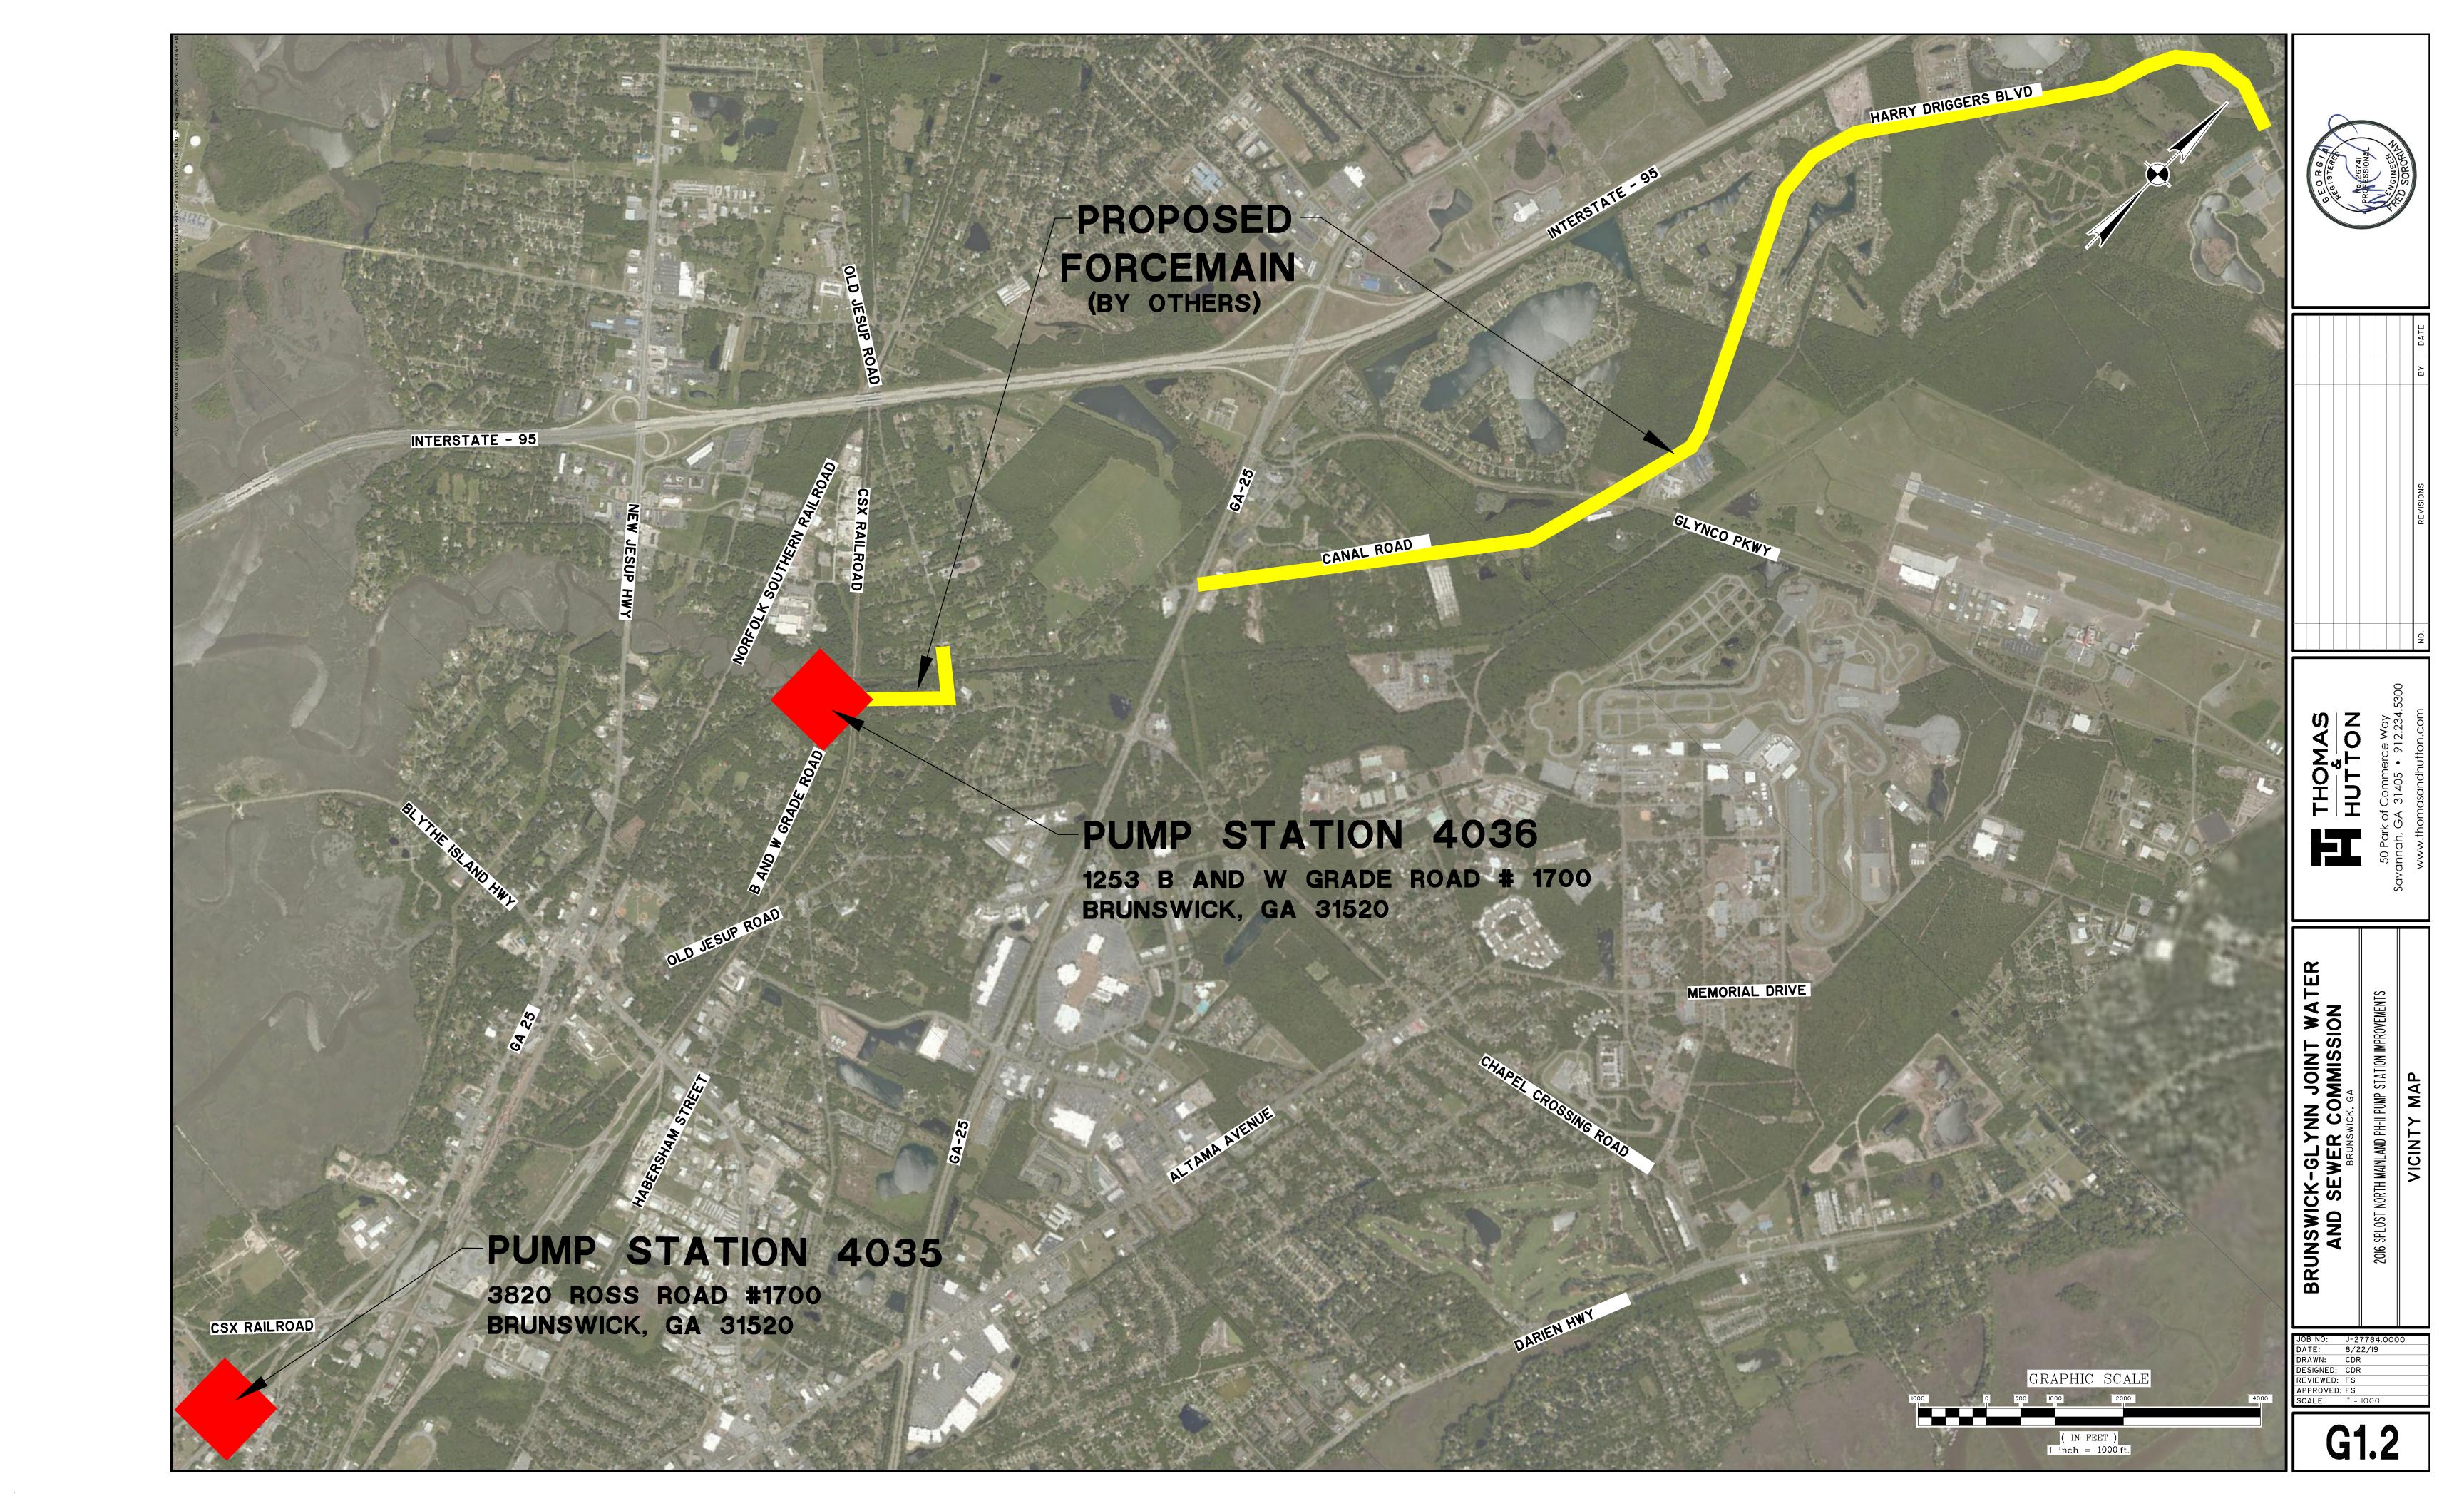
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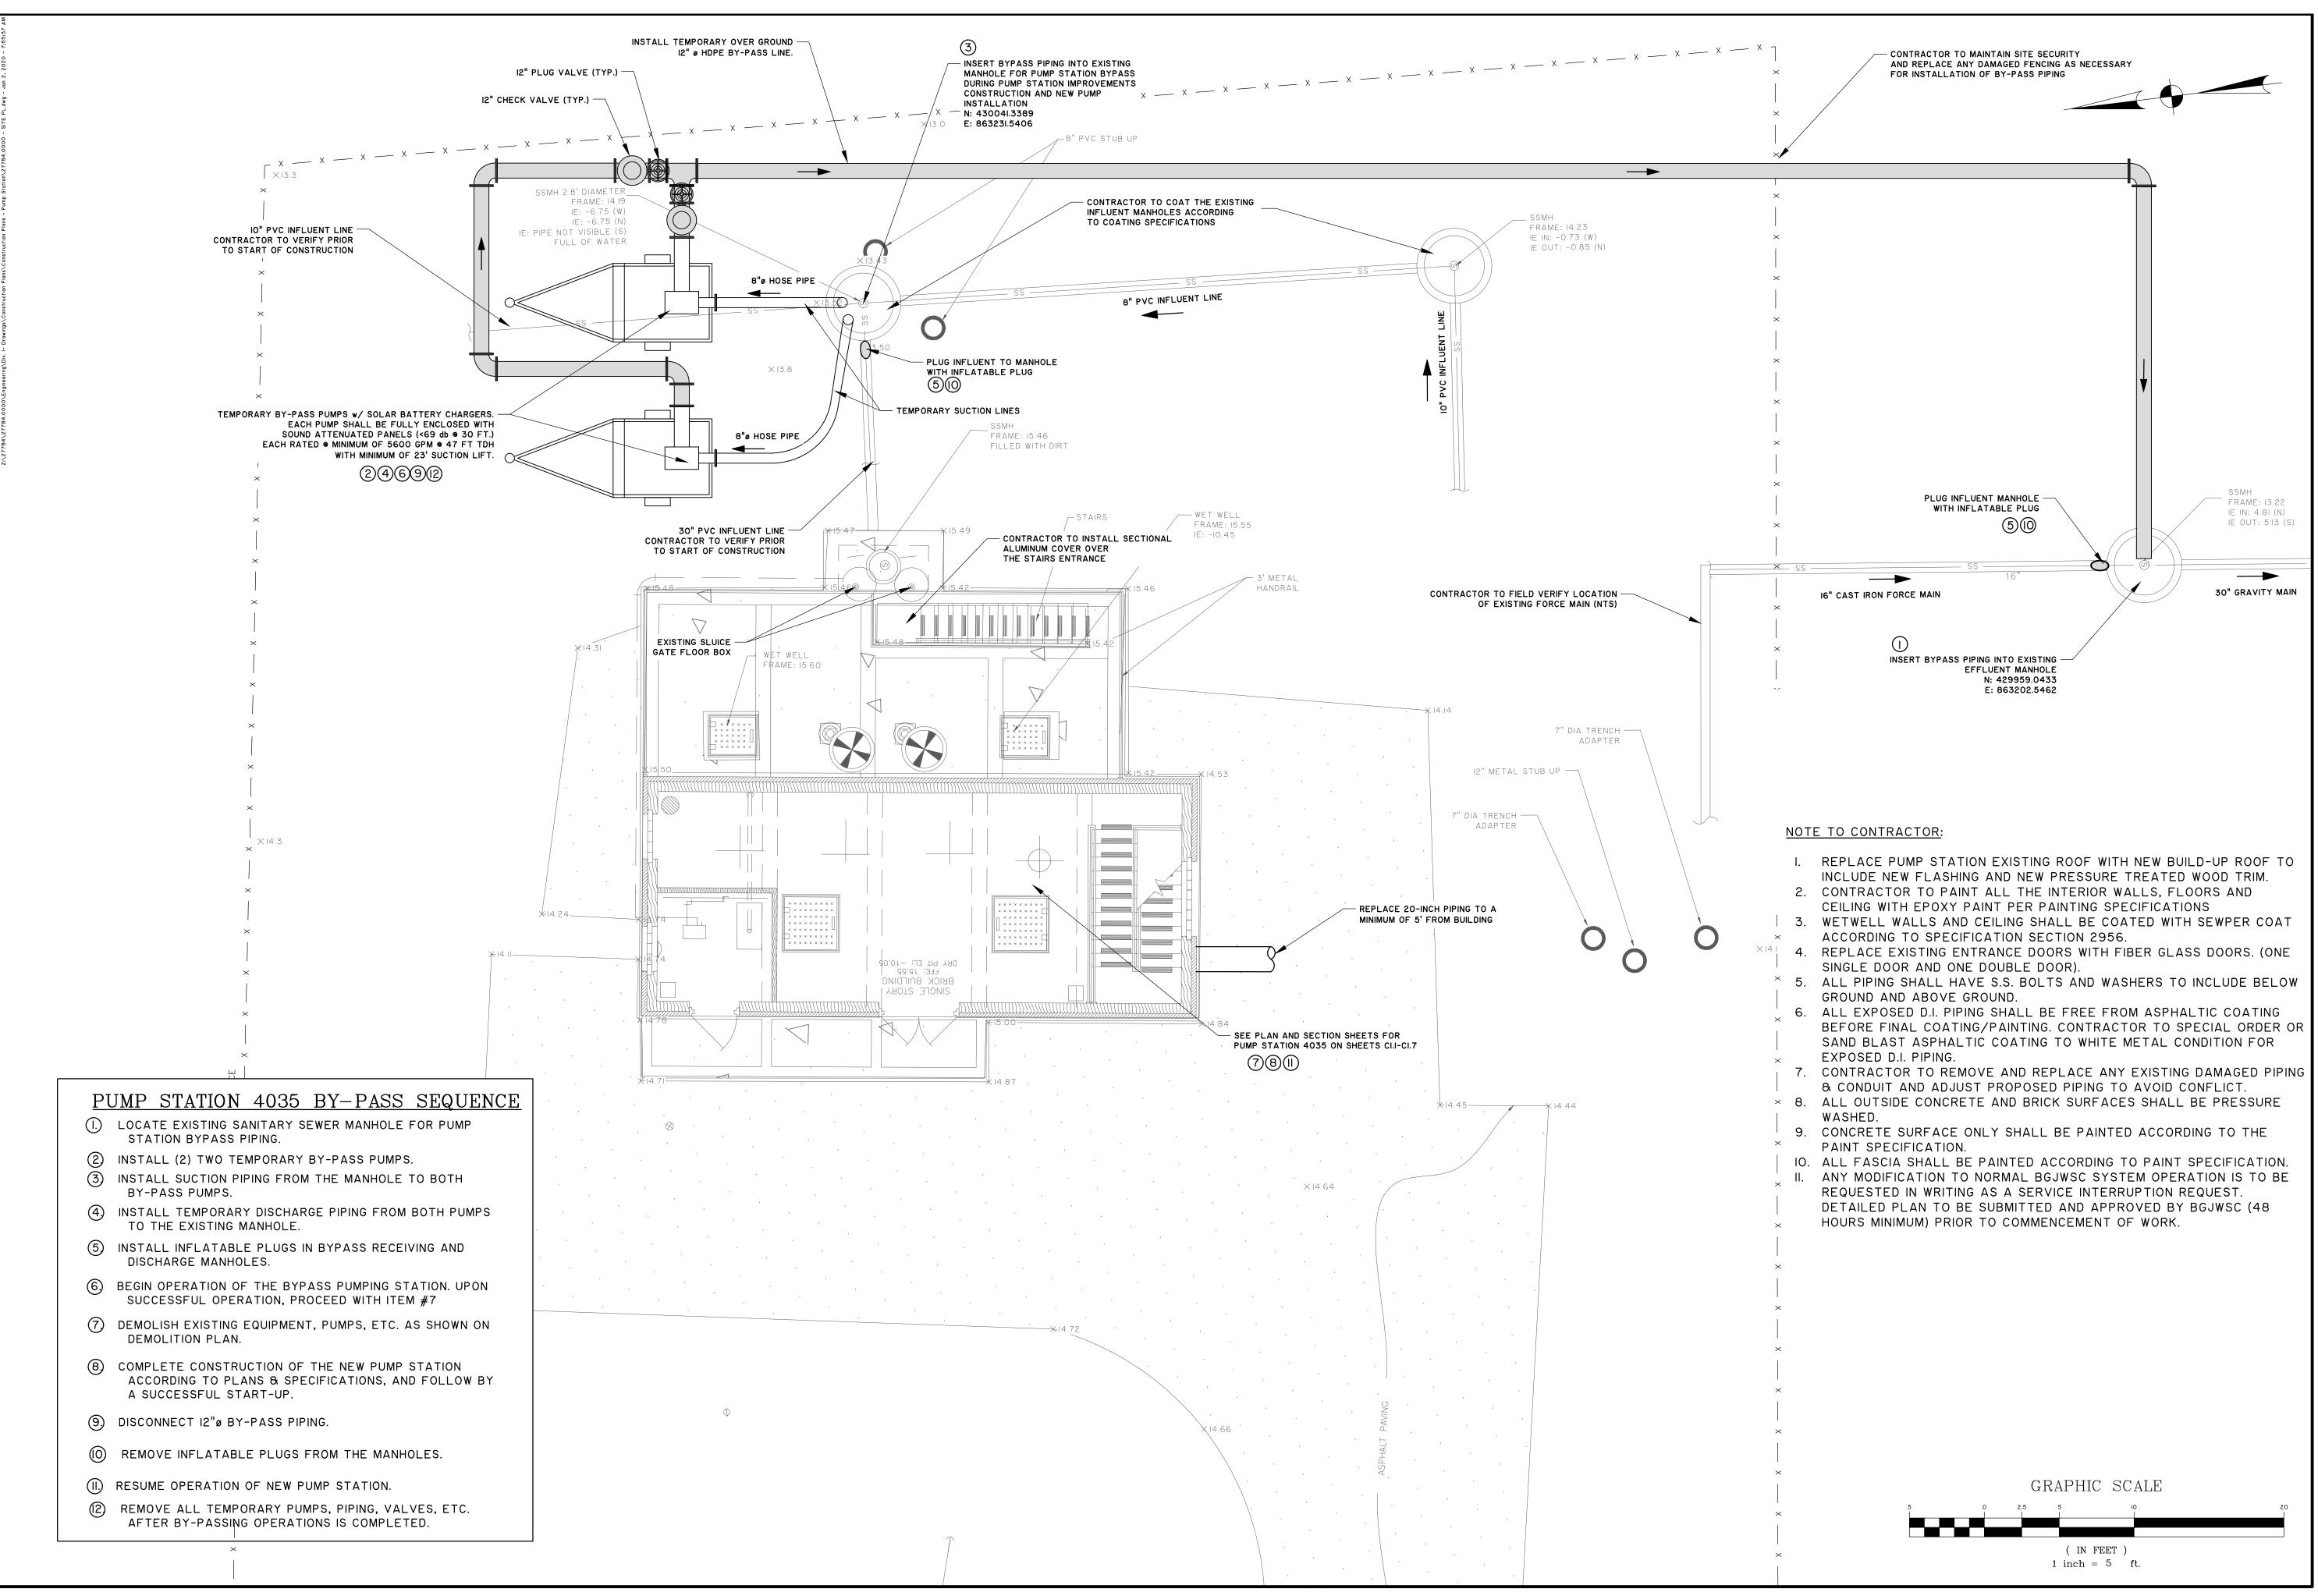
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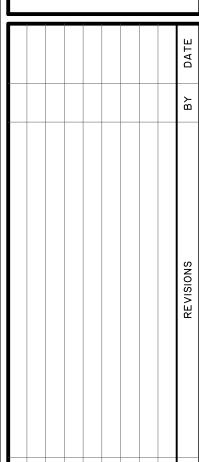
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Call before you dig.










GLYNN JOINT WA BRUNSWICK-AND SEV

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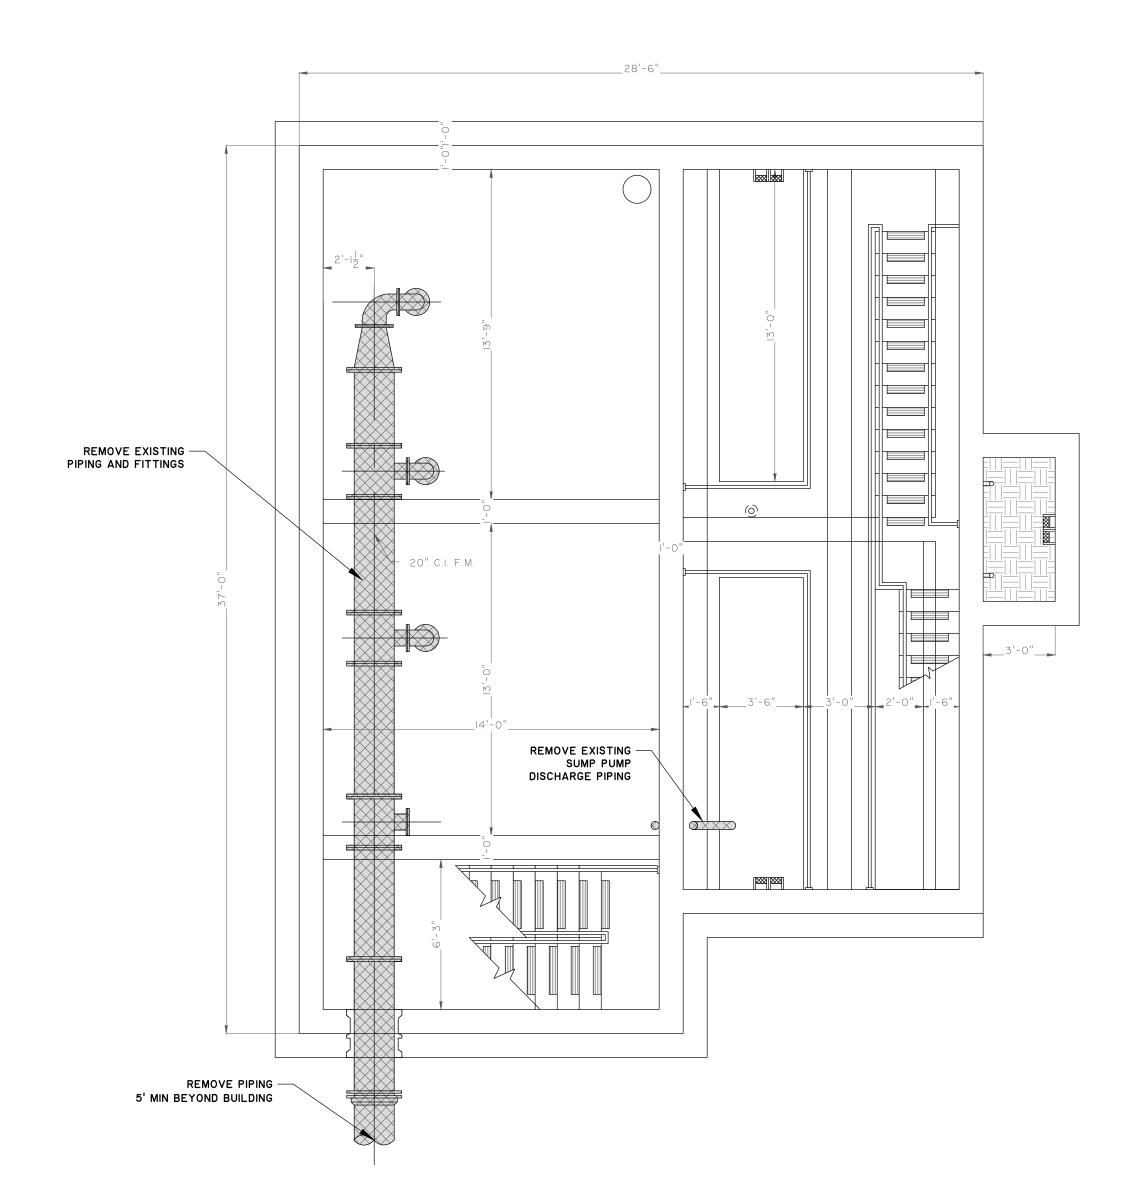
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BRUNSWICK-GLYNN JOINT WATE AND SEWER COMMISSION 2016 SPLOST N S 4035
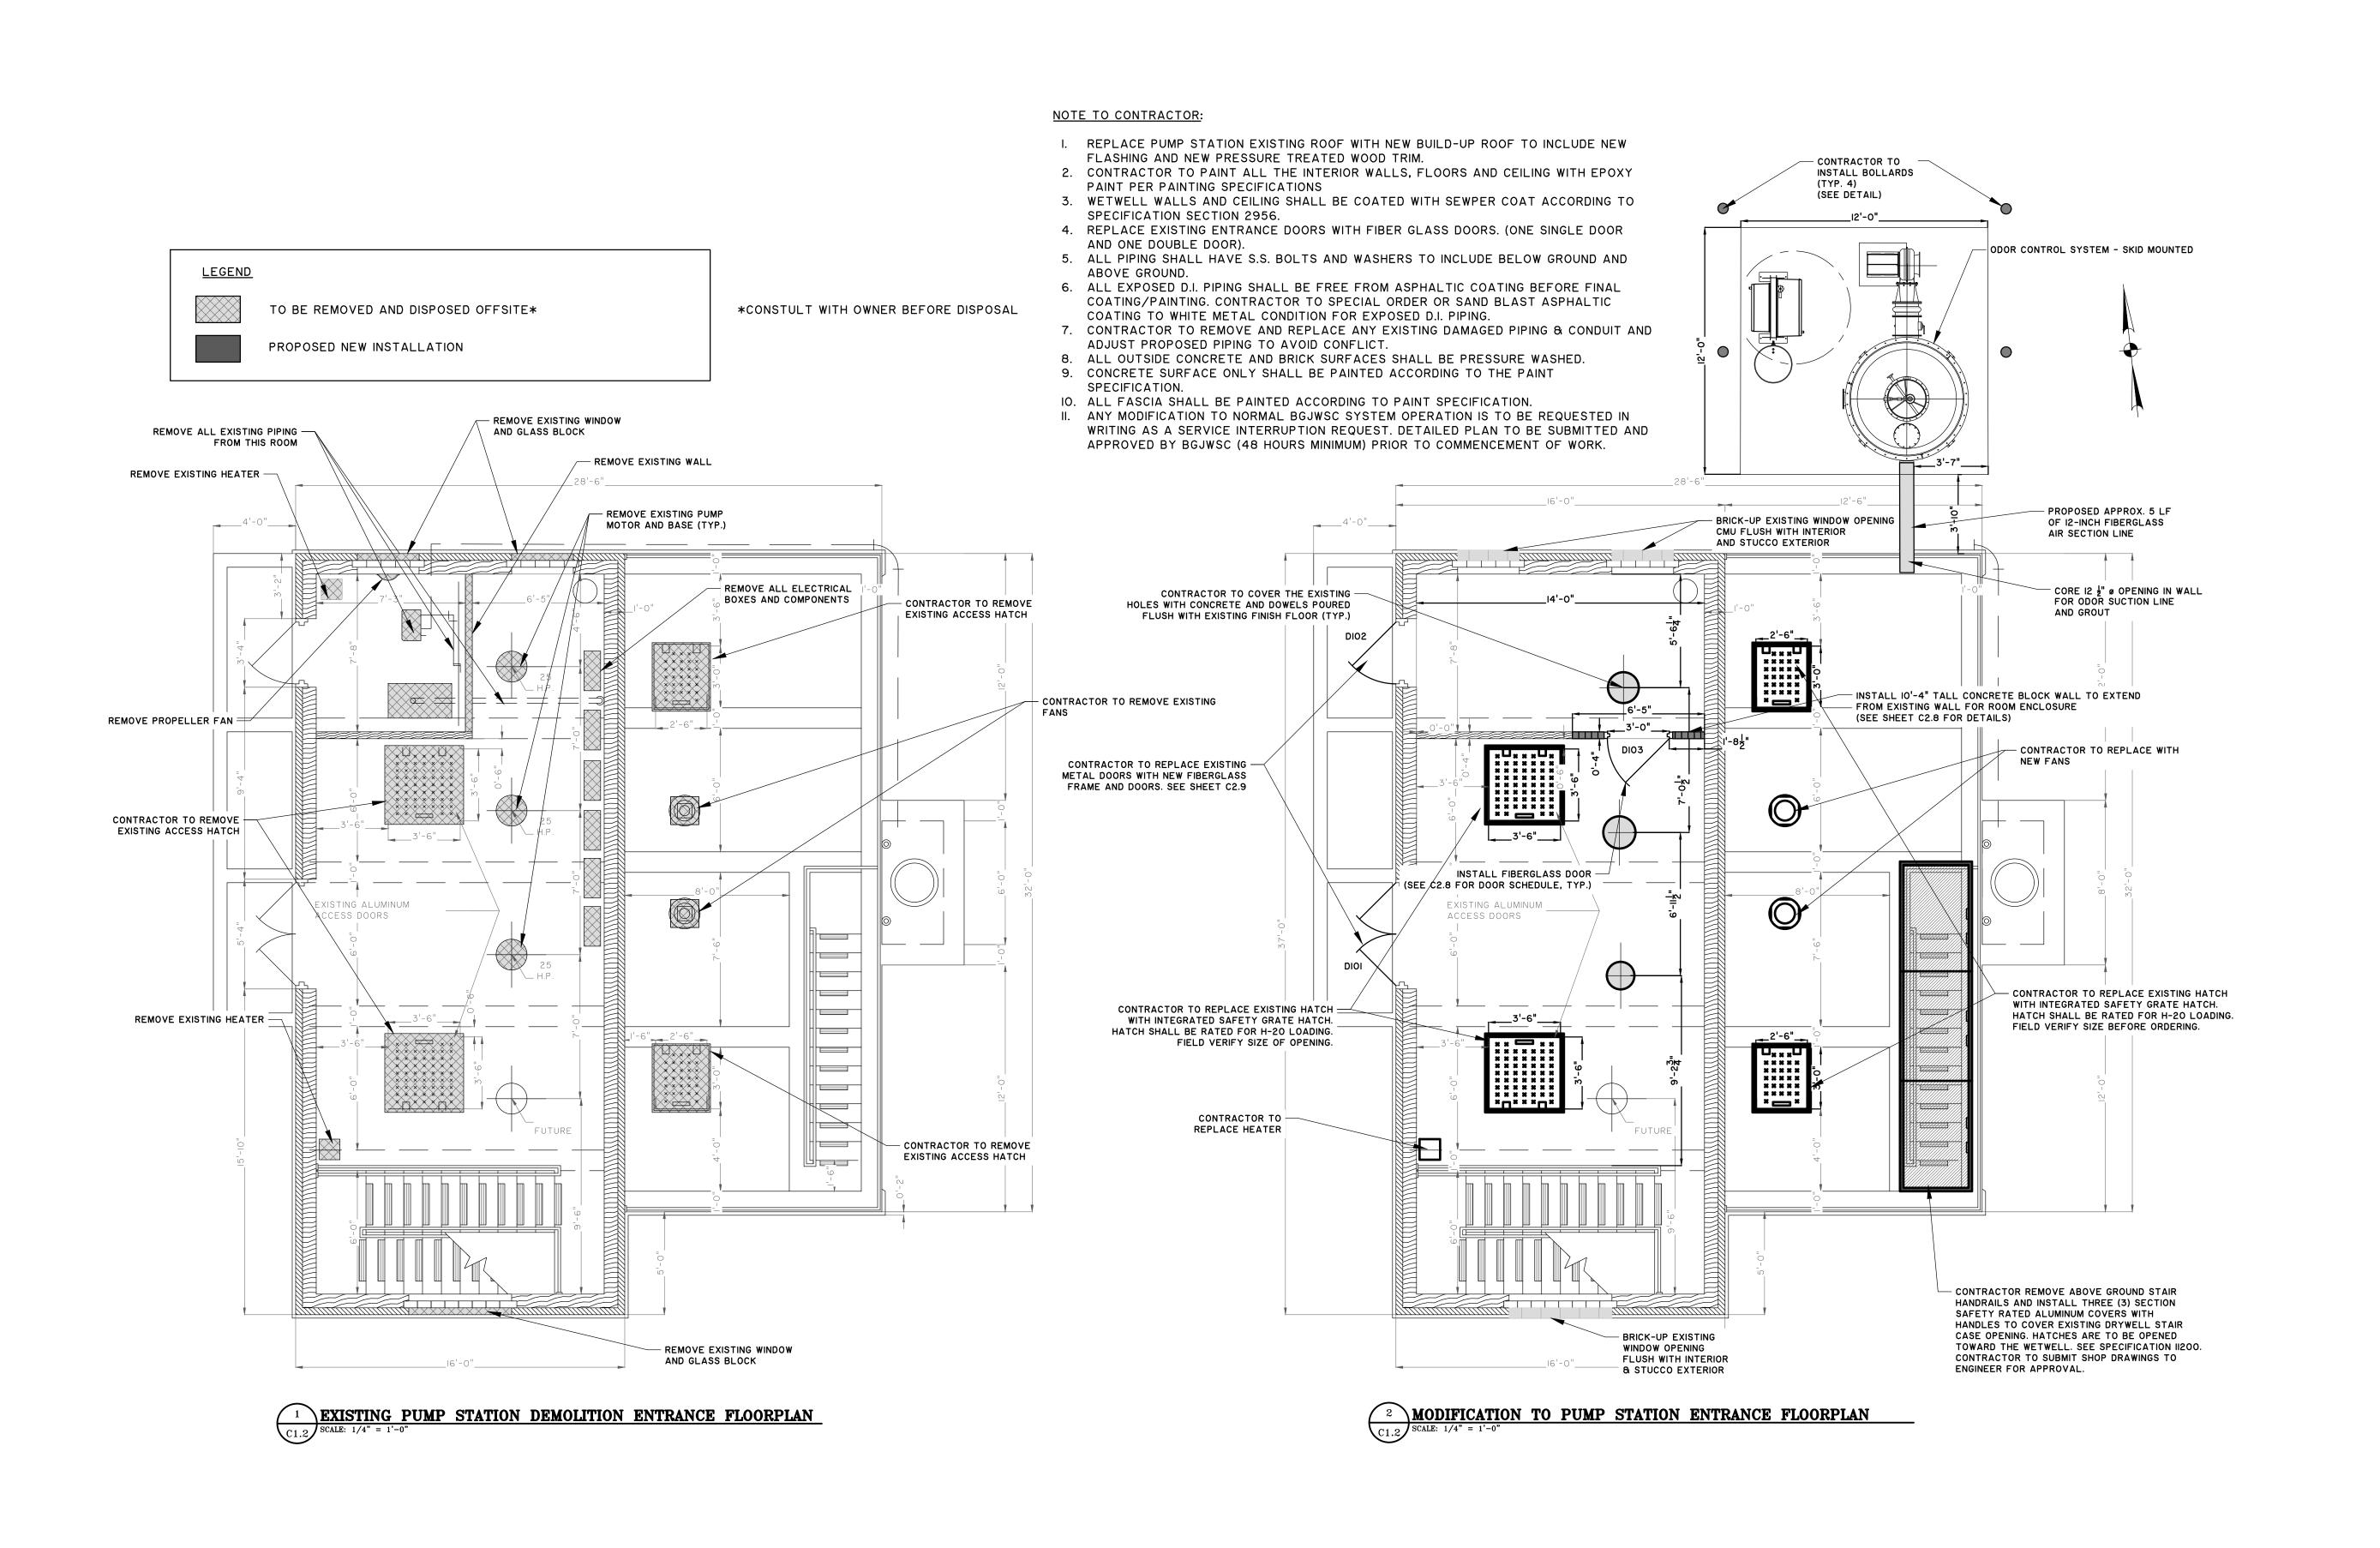
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*CONSTULT WITH OWNER BEFORE DISPOSAL




1 EXISTING PUMP STATION DEMOLITION INTERMEDIATE PLAN
C1.3 SCALE: 1/4" = 1'-0"

NOTE TO CONTRACTOR:

WORK.


- I. REPLACE PUMP STATION EXISTING ROOF WITH NEW BUILD-UP ROOF TO INCLUDE NEW FLASHING AND NEW PRESSURE TREATED
- 2. CONTRACTOR TO PAINT ALL THE INTERIOR WALLS, FLOORS AND CEILING WITH EPOXY PAINT PER PAINTING SPECIFICATIONS
- 3. WETWELL WALLS AND CEILING SHALL BE COATED WITH SEWPER COAT ACCORDING TO SPECIFICATION SECTION 2956.
- 4. REPLACE EXISTING ENTRANCE DOORS WITH FIBER GLASS DOORS. (ONE SINGLE DOOR AND ONE DOUBLE DOOR).
- 5. ALL PIPING SHALL HAVE S.S. BOLTS AND WASHERS TO INCLUDE BELOW GROUND AND ABOVE GROUND.
- 6. ALL EXPOSED D.I. PIPING SHALL BE FREE FROM ASPHALTIC COATING BEFORE FINAL COATING/PAINTING. CONTRACTOR TO SPECIAL ORDER OR SAND BLAST ASPHALTIC COATING TO WHITE METAL CONDITION FOR EXPOSED D.I. PIPING.
- 7. CONTRACTOR TO REMOVE AND REPLACE ANY EXISTING DAMAGED PIPING & CONDUIT AND ADJUST PROPOSED PIPING TO AVOID CONFLICT.
- 8. ALL OUTSIDE CONCRETE AND BRICK SURFACES SHALL BE PRESSURE WASHED.
- 9. CONCRETE SURFACE ONLY SHALL BE PAINTED ACCORDING TO THE PAINT SPECIFICATION.
- IO. ALL FASCIA SHALL BE PAINTED ACCORDING TO PAINT SPECIFICATION. II. ANY MODIFICATION TO NORMAL BGJWSC SYSTEM OPERATION IS TO BE REQUESTED IN WRITING AS A SERVICE INTERRUPTION REQUEST. DETAILED PLAN TO BE SUBMITTED AND APPROVED BY BGJWSC (48 HOURS MINIMUM) PRIOR TO COMMENCEMENT OF

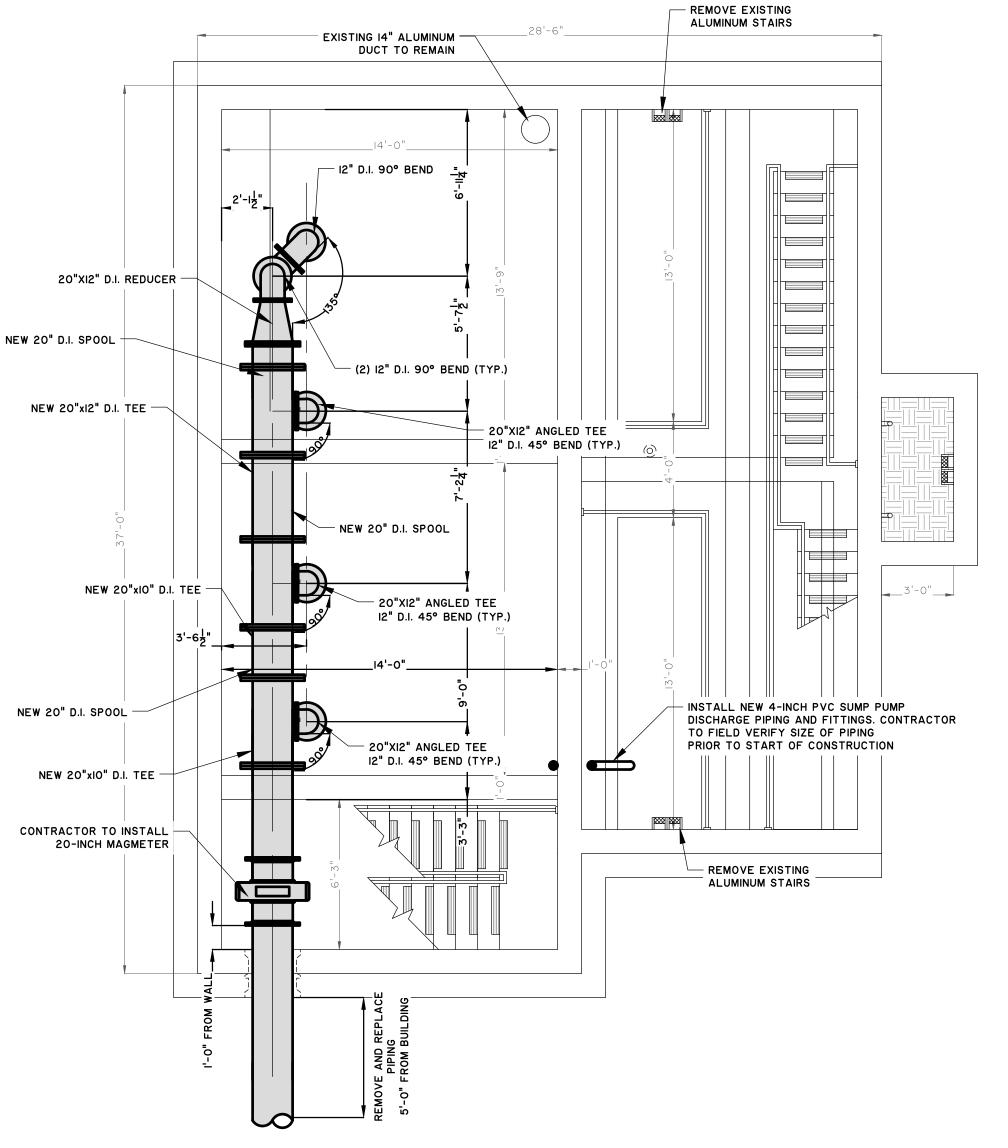








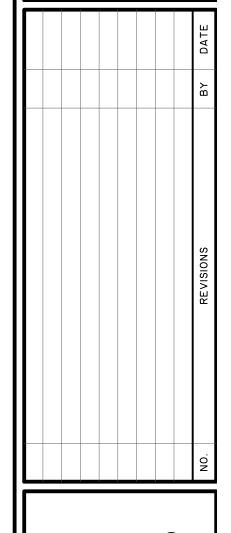

BRUNSWICK-GLYNN JOINT WATER AND SEWER COMMISSION

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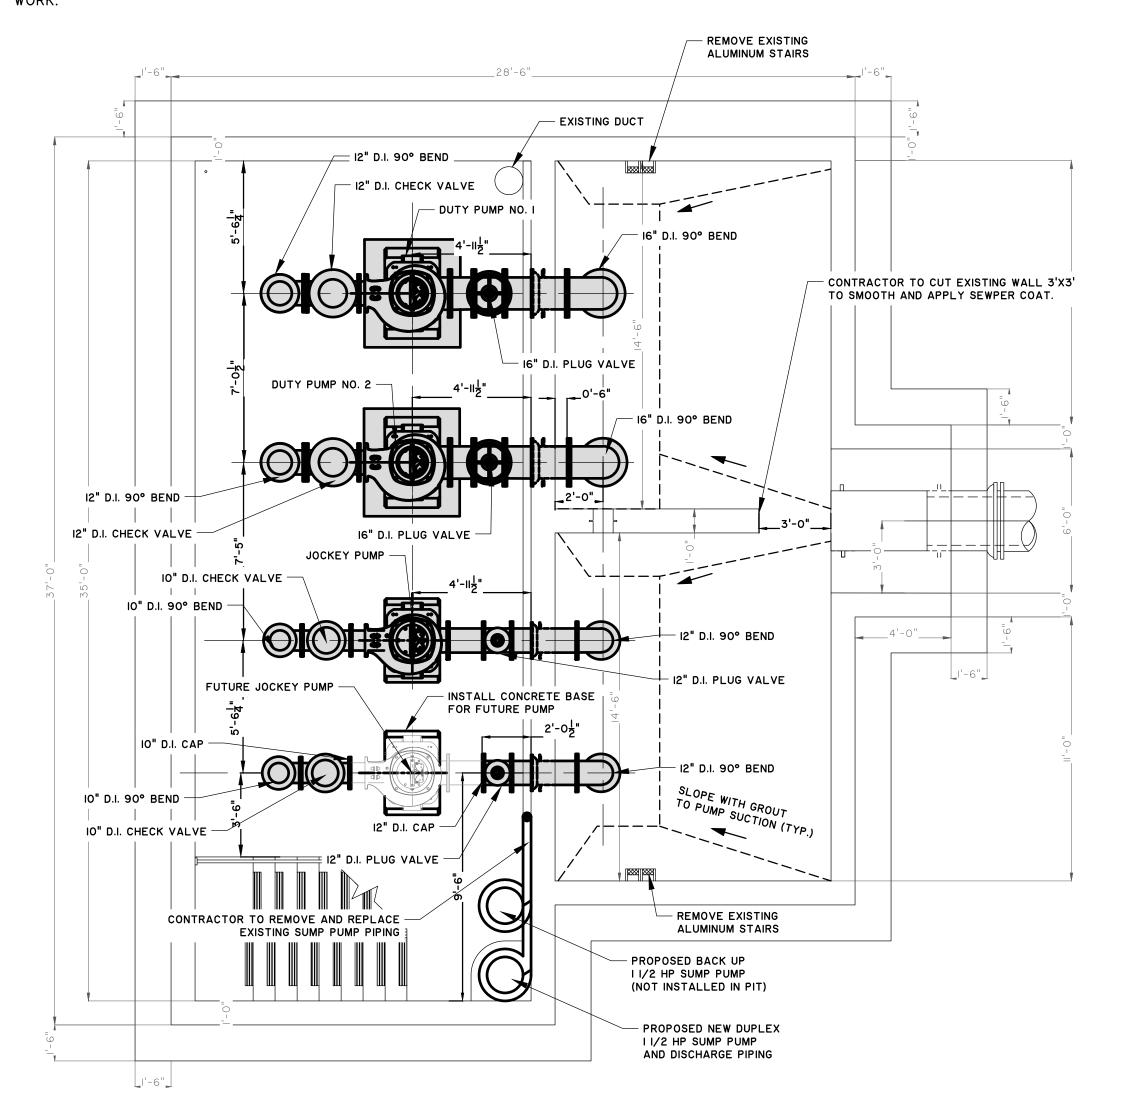
*CONSTULT WITH OWNER BEFORE DISPOSAL

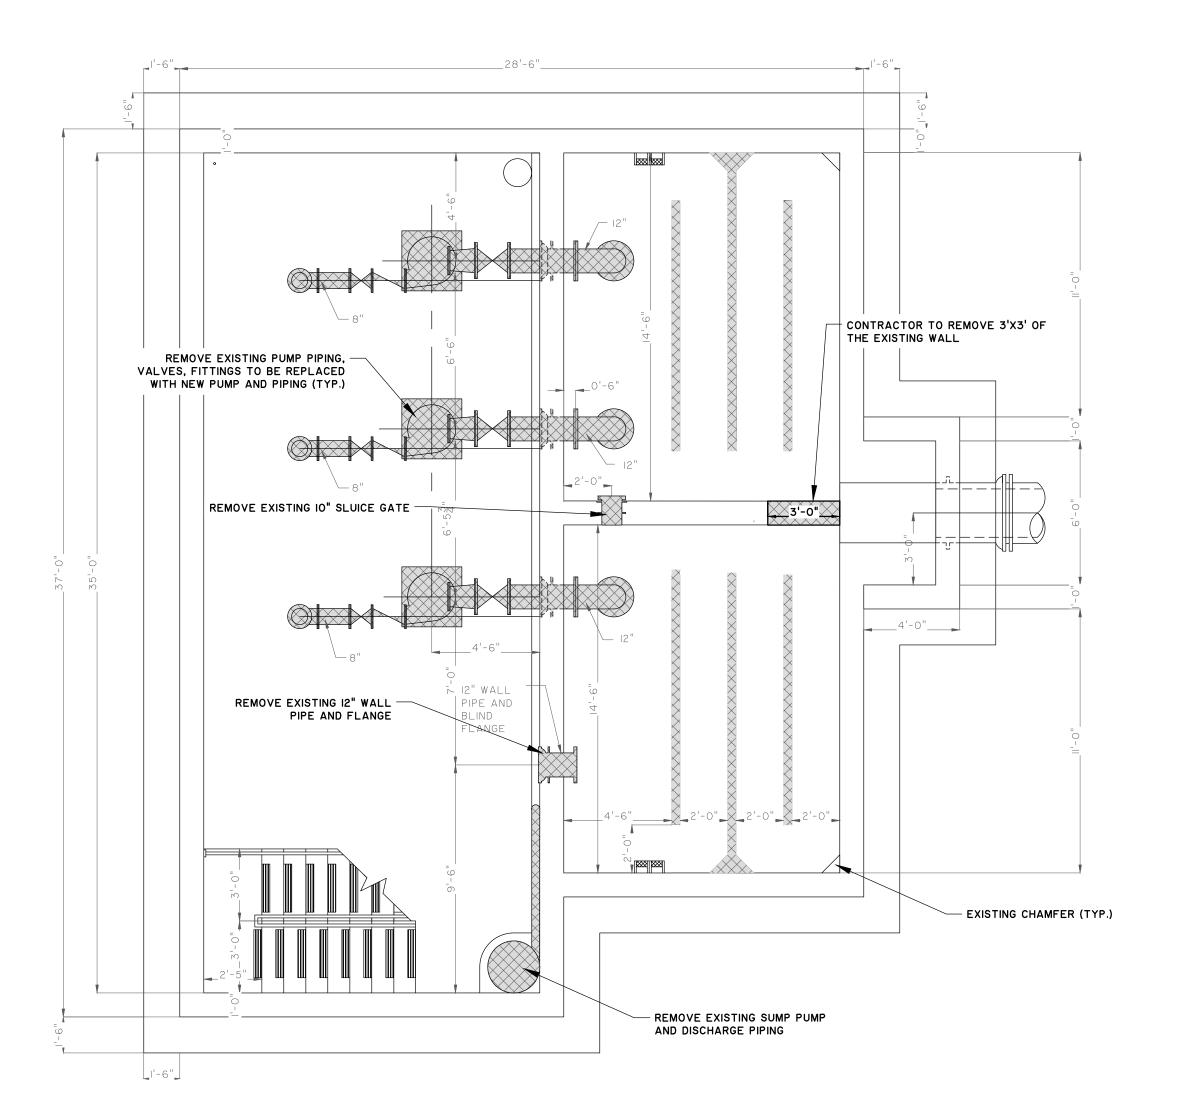

EXISTING PUMP STATION DEMOLITION BOTTOM PLAN

NOTE TO CONTRACTOR:

- I. REPLACE PUMP STATION EXISTING ROOF WITH NEW BUILD-UP ROOF TO INCLUDE NEW FLASHING AND NEW PRESSURE TREATED WOOD TRIM.
- 2. CONTRACTOR TO PAINT ALL THE INTERIOR WALLS, FLOORS AND CEILING WITH EPOXY PAINT PER PAINTING SPECIFICATIONS
- 3. WETWELL WALLS AND CEILING SHALL BE COATED WITH SEWPER COAT ACCORDING TO SPECIFICATION SECTION 2956.
- 4. REPLACE EXISTING ENTRANCE DOORS WITH FIBER GLASS DOORS. (ONE SINGLE DOOR AND ONE DOUBLE DOOR). ALL PIPING SHALL HAVE S.S. BOLTS AND WASHERS TO INCLUDE BELOW GROUND AND ABOVE GROUND.
- 6. ALL EXPOSED D.I. PIPING SHALL BE FREE FROM ASPHALTIC COATING BEFORE FINAL COATING/PAINTING. CONTRACTOR TO SPECIAL ORDER OR SAND BLAST ASPHALTIC COATING TO WHITE METAL CONDITION FOR EXPOSED D.I. PIPING.
- 7. CONTRACTOR TO REMOVE AND REPLACE ANY EXISTING DAMAGED PIPING & CONDUIT AND ADJUST PROPOSED PIPING TO AVOID
- 8. ALL OUTSIDE CONCRETE AND BRICK SURFACES SHALL BE PRESSURE WASHED.
- 9. CONCRETE SURFACE ONLY SHALL BE PAINTED ACCORDING TO THE PAINT SPECIFICATION.
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- II. ANY MODIFICATION TO NORMAL BGJWSC SYSTEM OPERATION IS TO BE REQUESTED IN WRITING AS A SERVICE INTERRUPTION REQUEST. DETAILED PLAN TO BE SUBMITTED AND APPROVED BY BGJWSC (48 HOURS MINIMUM) PRIOR TO COMMENCEMENT OF WORK.




MODIFICATION TO PUMP STATION BOTTOM PLAN

C1.4 SCALE: 1/4" = 1'-0"






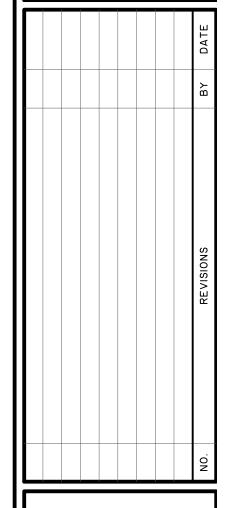

BRUNSWICK-GLYNN JOINT WATER AND SEWER COMMISSION

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BRUNSWICK-GLYNN JOINT WATER AND SEWER COMMISSION
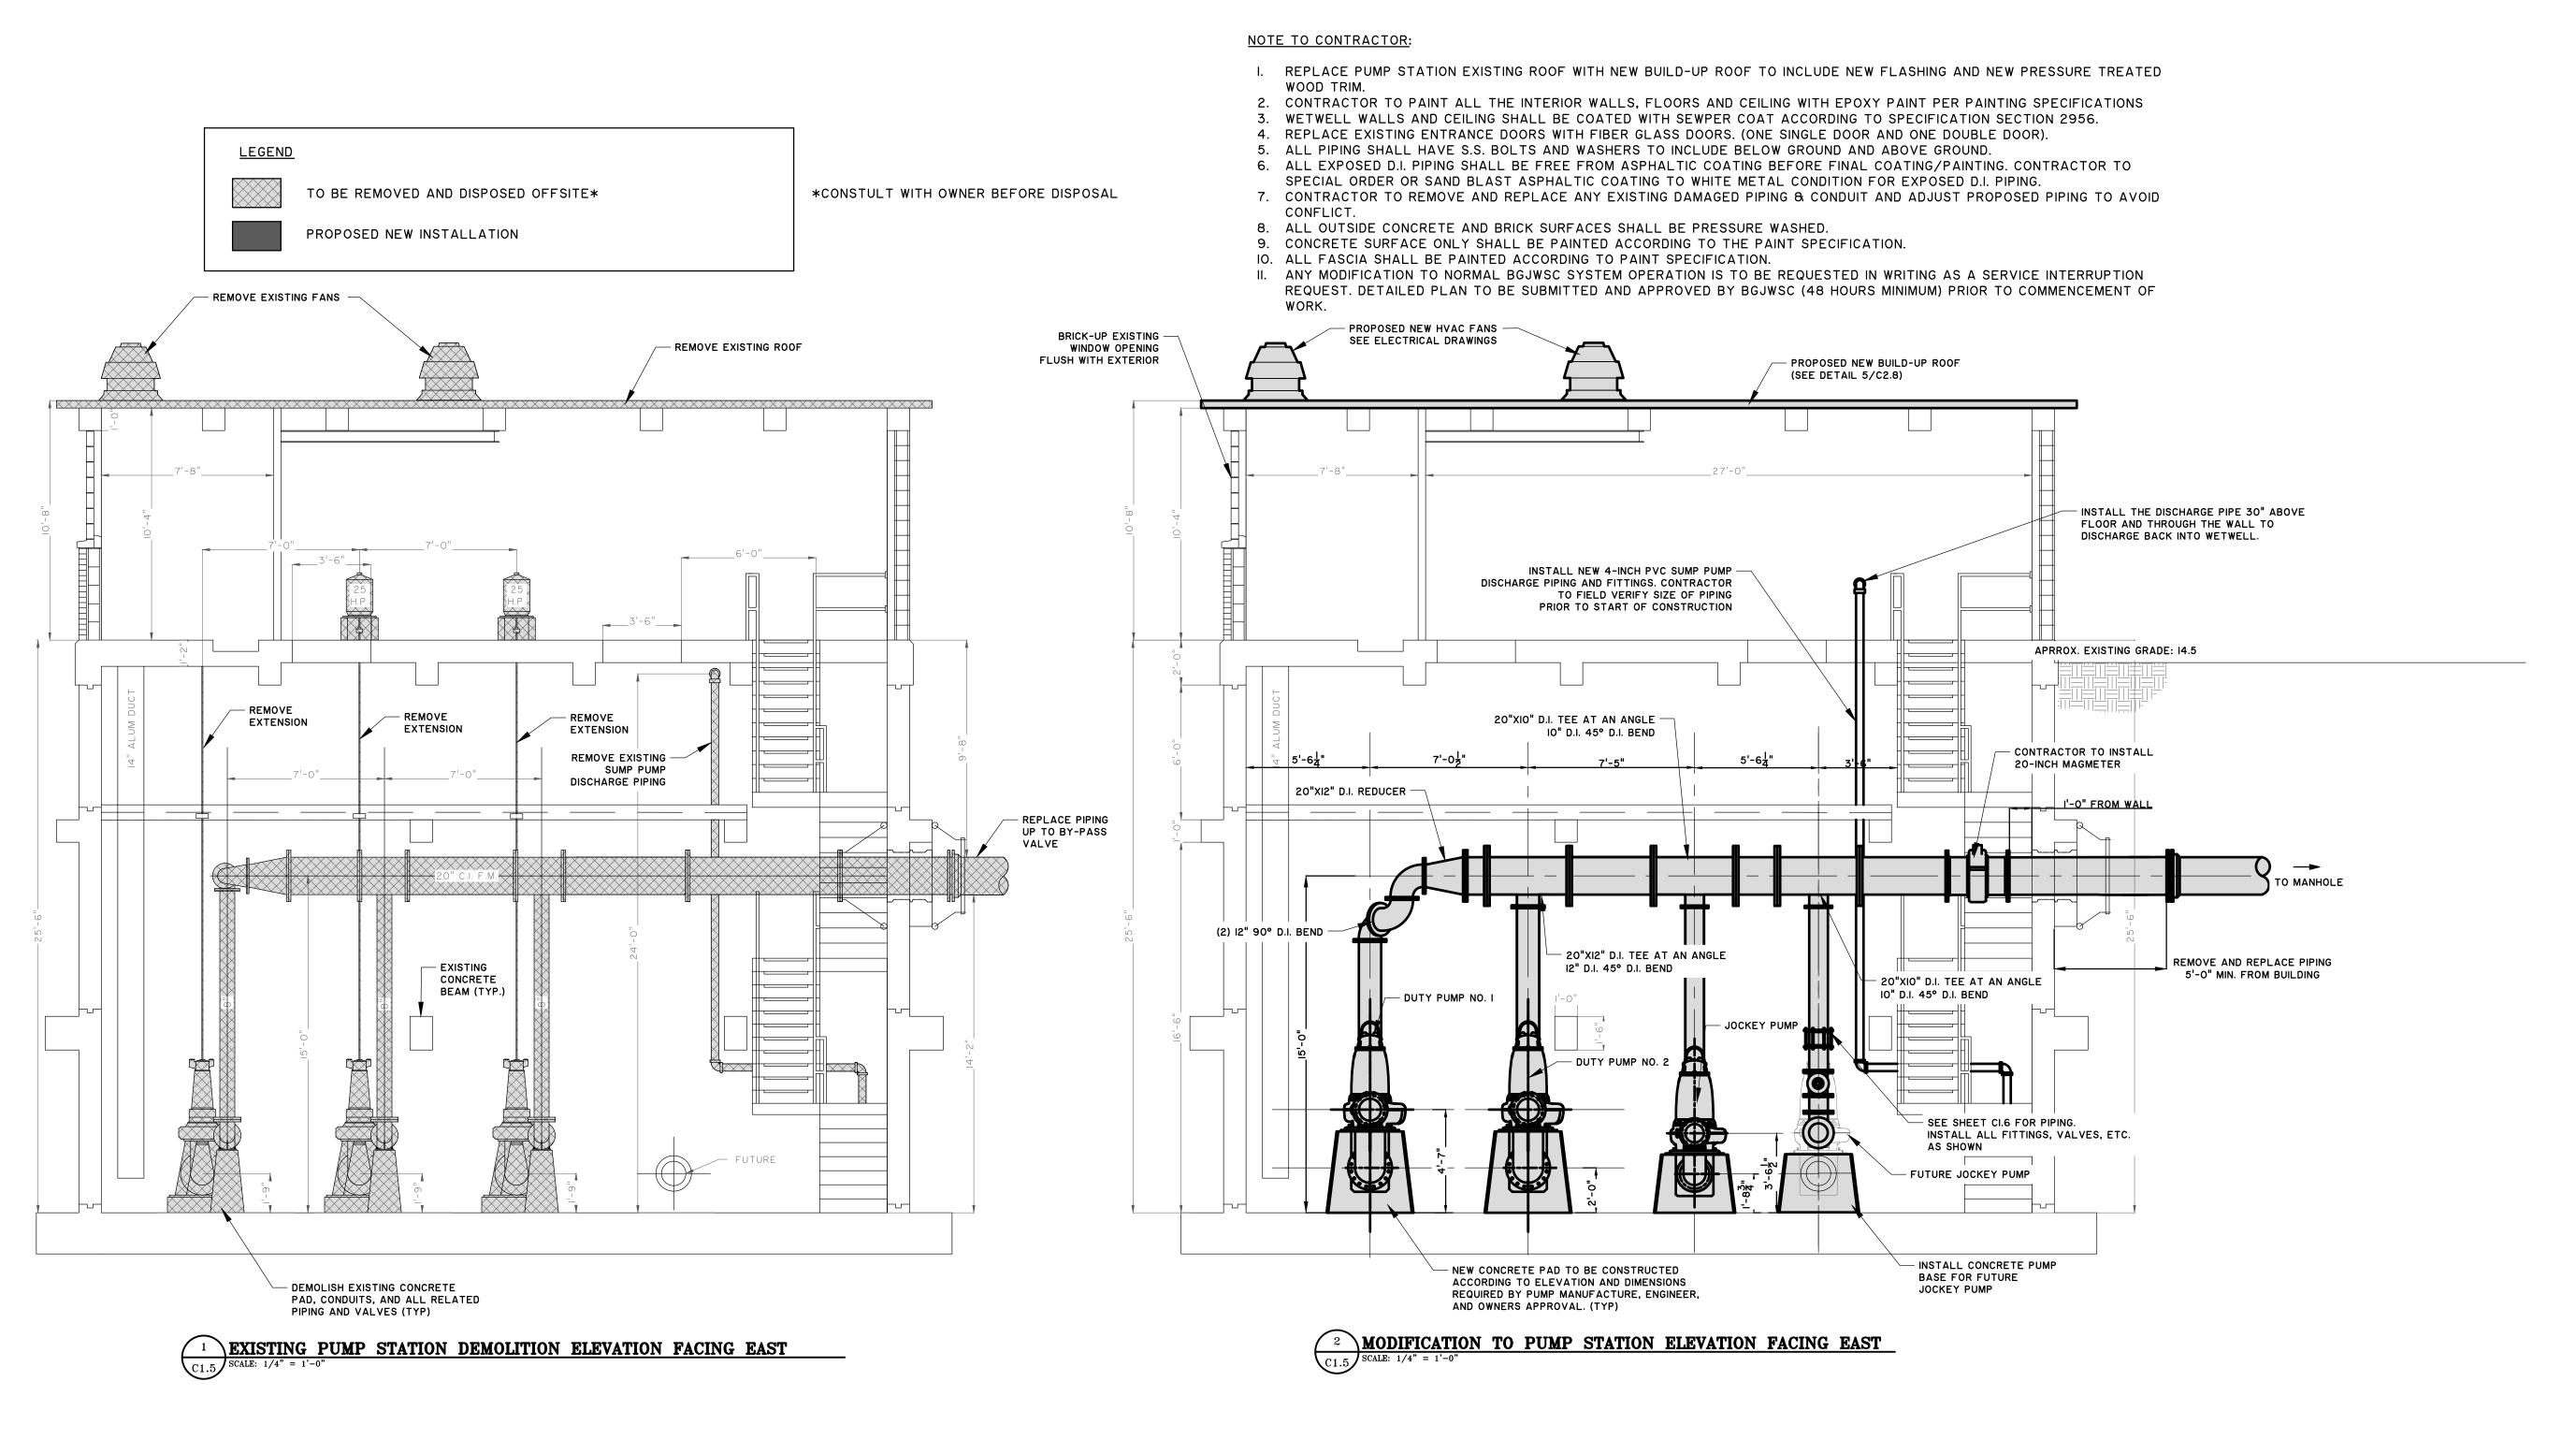
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<u>LEGEND</u> TO BE REMOVED AND DISPOSED OFFSITE* PROPOSED NEW INSTALLATION

*CONSTULT WITH OWNER BEFORE DISPOSAL

4. REPLACE EXISTING ENTRANCE DOORS WITH FIBER GLASS DOORS. (ONE SINGLE DOOR AND ONE DOUBLE DOOR). 5. ALL PIPING SHALL HAVE S.S. BOLTS AND WASHERS TO INCLUDE BELOW GROUND AND ABOVE GROUND. 6. ALL EXPOSED D.I. PIPING SHALL BE FREE FROM ASPHALTIC COATING BEFORE FINAL COATING/PAINTING. CONTRACTOR TO SPECIAL ORDER OR SAND BLAST ASPHALTIC COATING TO WHITE METAL CONDITION FOR EXPOSED D.I. PIPING.

3. WETWELL WALLS AND CEILING SHALL BE COATED WITH SEWPER COAT ACCORDING TO SPECIFICATION SECTION 2956.

7. CONTRACTOR TO REMOVE AND REPLACE ANY EXISTING DAMAGED PIPING & CONDUIT AND ADJUST PROPOSED PIPING TO AVOID

2. CONTRACTOR TO PAINT ALL THE INTERIOR WALLS, FLOORS AND CEILING WITH EPOXY PAINT PER PAINTING SPECIFICATIONS


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IO. ALL FASCIA SHALL BE PAINTED ACCORDING TO PAINT SPECIFICATION.

NOTE TO CONTRACTOR:

II. ANY MODIFICATION TO NORMAL BGJWSC SYSTEM OPERATION IS TO BE REQUESTED IN WRITING AS A SERVICE INTERRUPTION REQUEST. DETAILED PLAN TO BE SUBMITTED AND APPROVED BY BGJWSC (48 HOURS MINIMUM) PRIOR TO COMMENCEMENT OF



EXISTING PUMP STATION DEMOLITION ELEVATION FACING NORTH

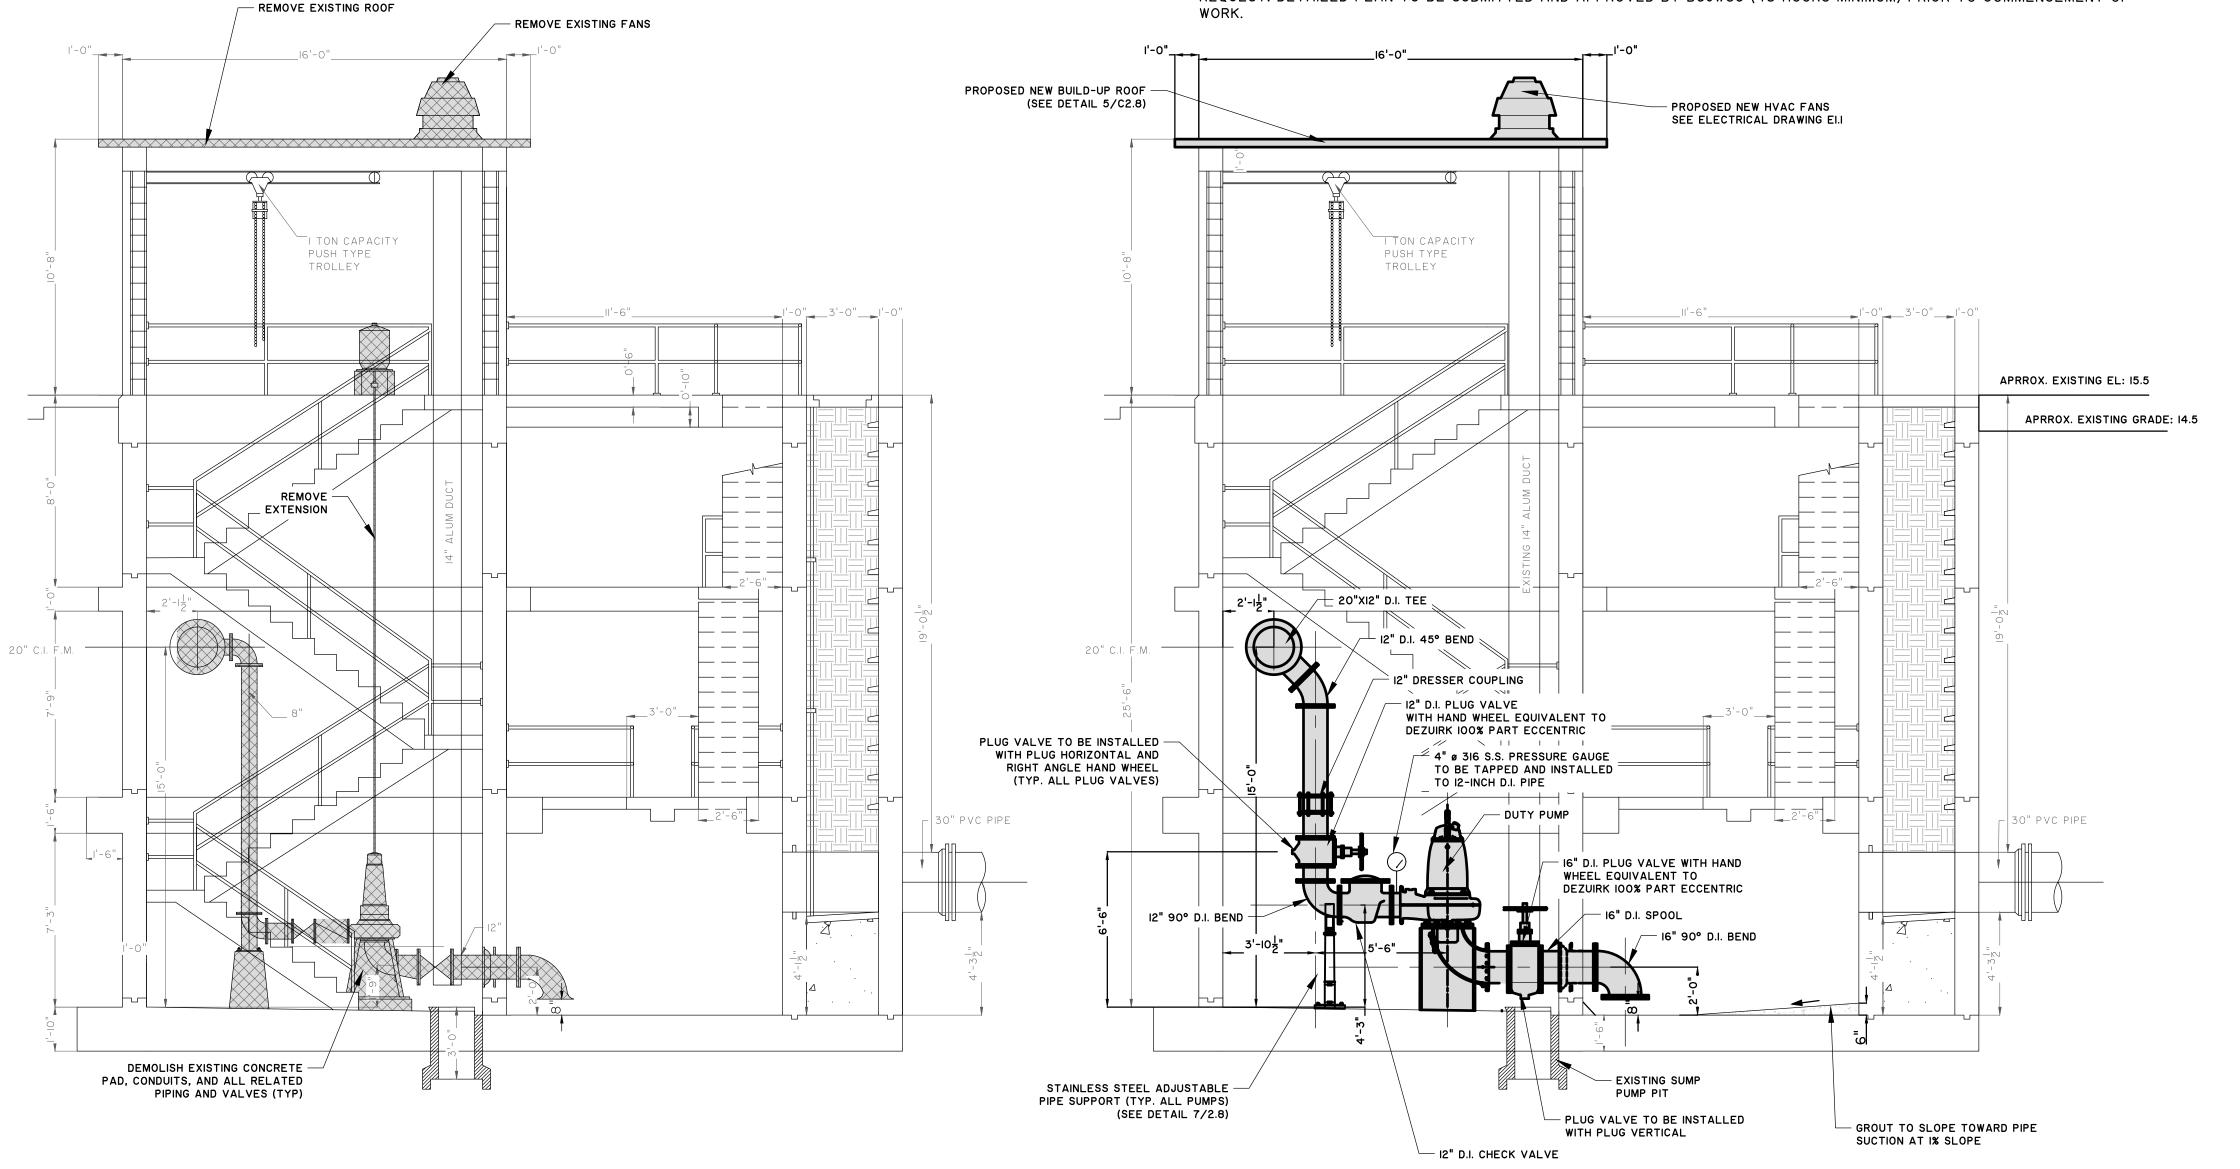MODIFICATION TO PUMP STATION ELEVATION FACING NORTH

| C1.6 | SCALE: 1/4" = 1'-0"




BRUNSWICK-GLYNN JOINT WATER AND SEWER COMMISSION

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*CONSTULT WITH OWNER BEFORE DISPOSAL

NOTE TO CONTRACTOR:

- I. REPLACE PUMP STATION EXISTING ROOF WITH NEW BUILD-UP ROOF TO INCLUDE NEW FLASHING AND NEW PRESSURE TREATED
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EXISTING PUMP STATION DEMOLITION ELEVATION FACING NORTH JOCKEY PUMP

| C1.7 | SCALE: 1/4" = 1'-0"

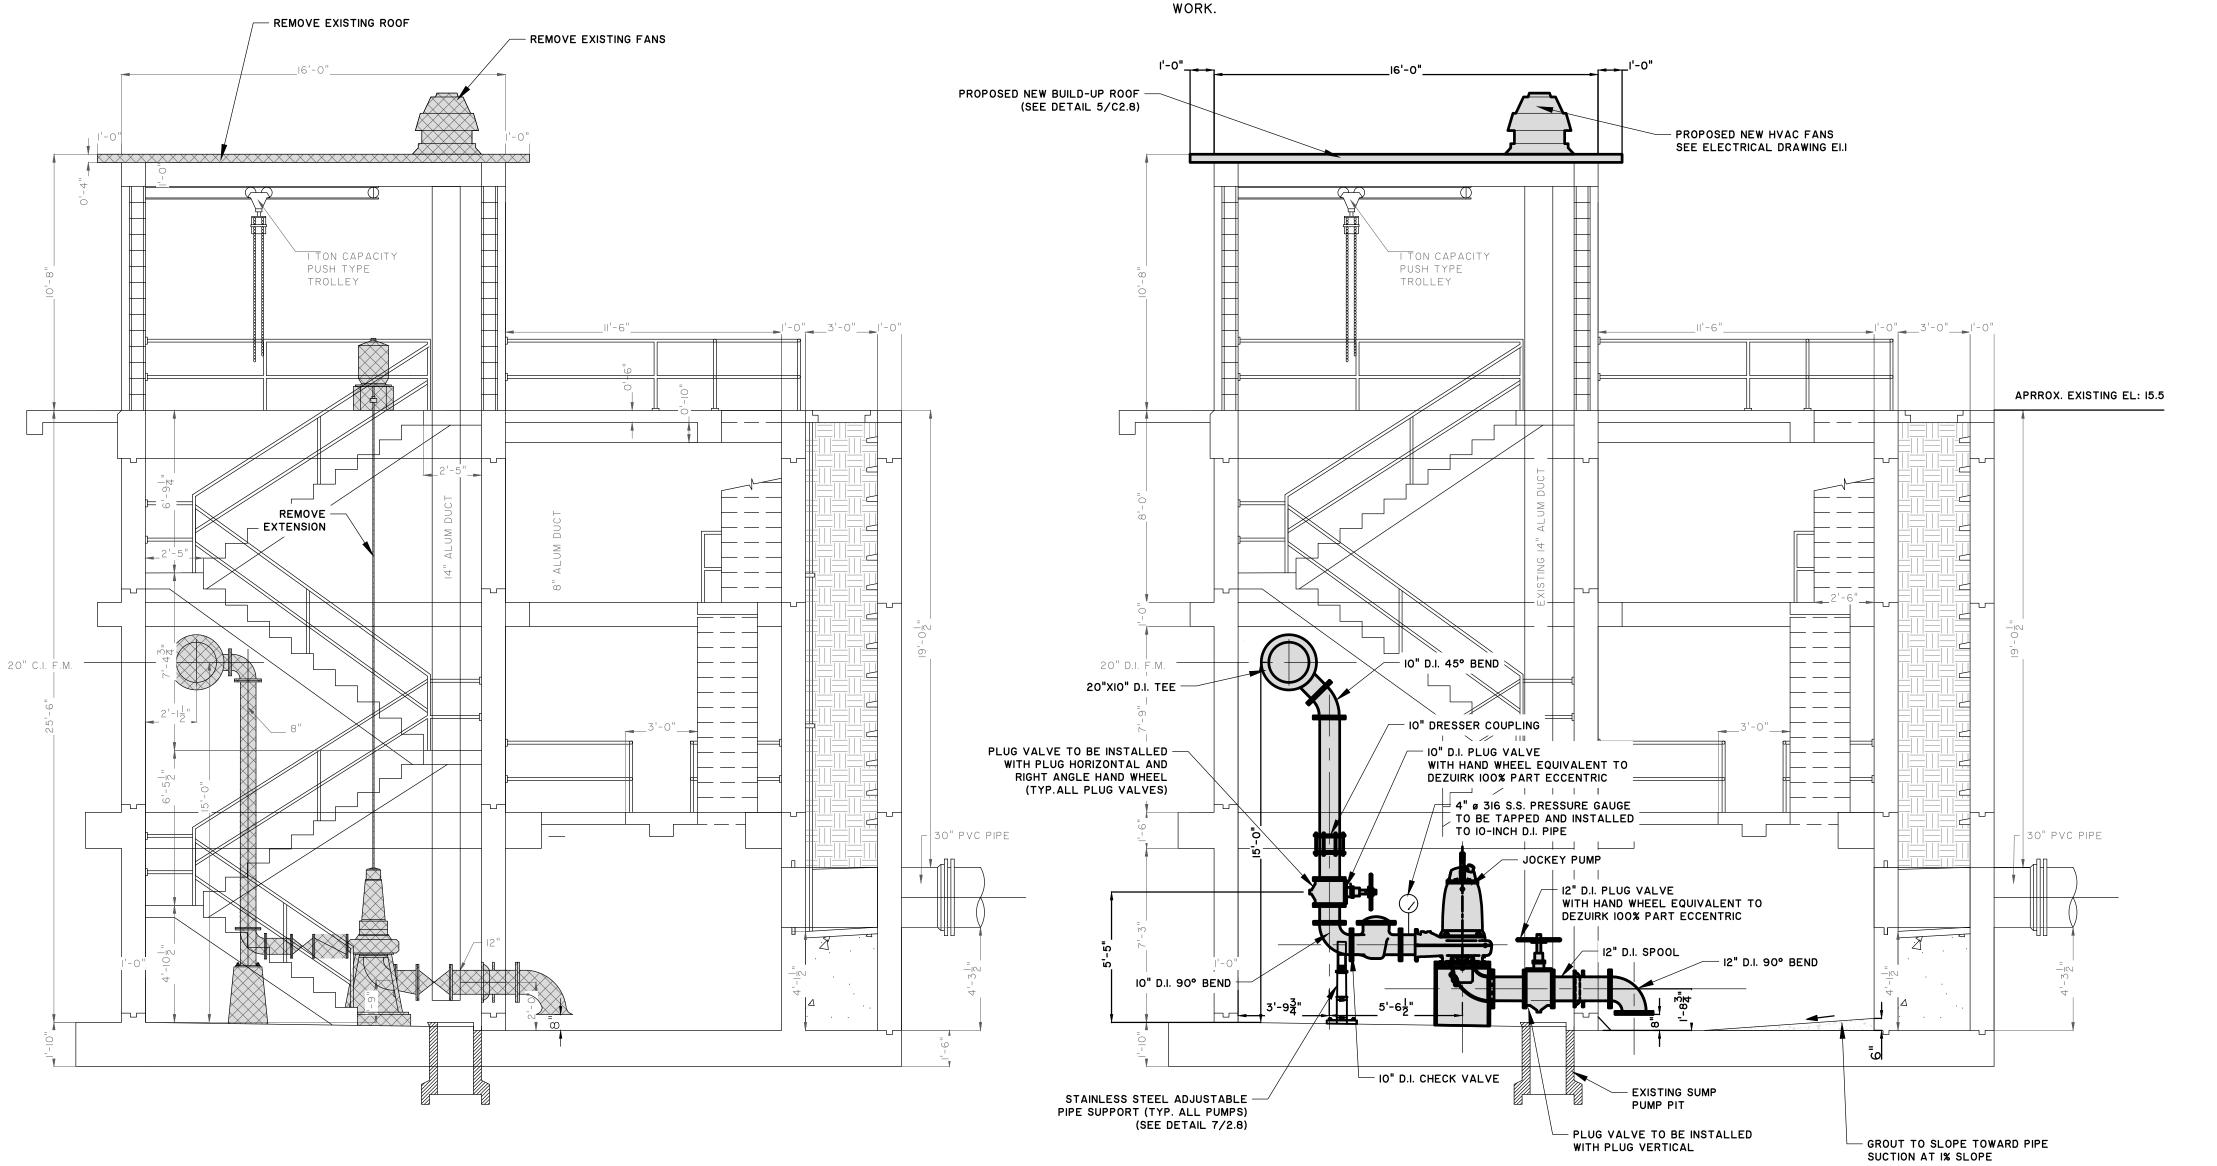
MODIFICATION TO PUMP STATION ELEVATION FACING NORTH JOCKEY PUMP

SCALE: 1/4" = 1'-0"



BRUNSWICK-GLYNN JOINT WATER AND SEWER COMMISSION

DRAWN: CDR DESIGNED: CDR REVIEWED: FS APPROVED: FS

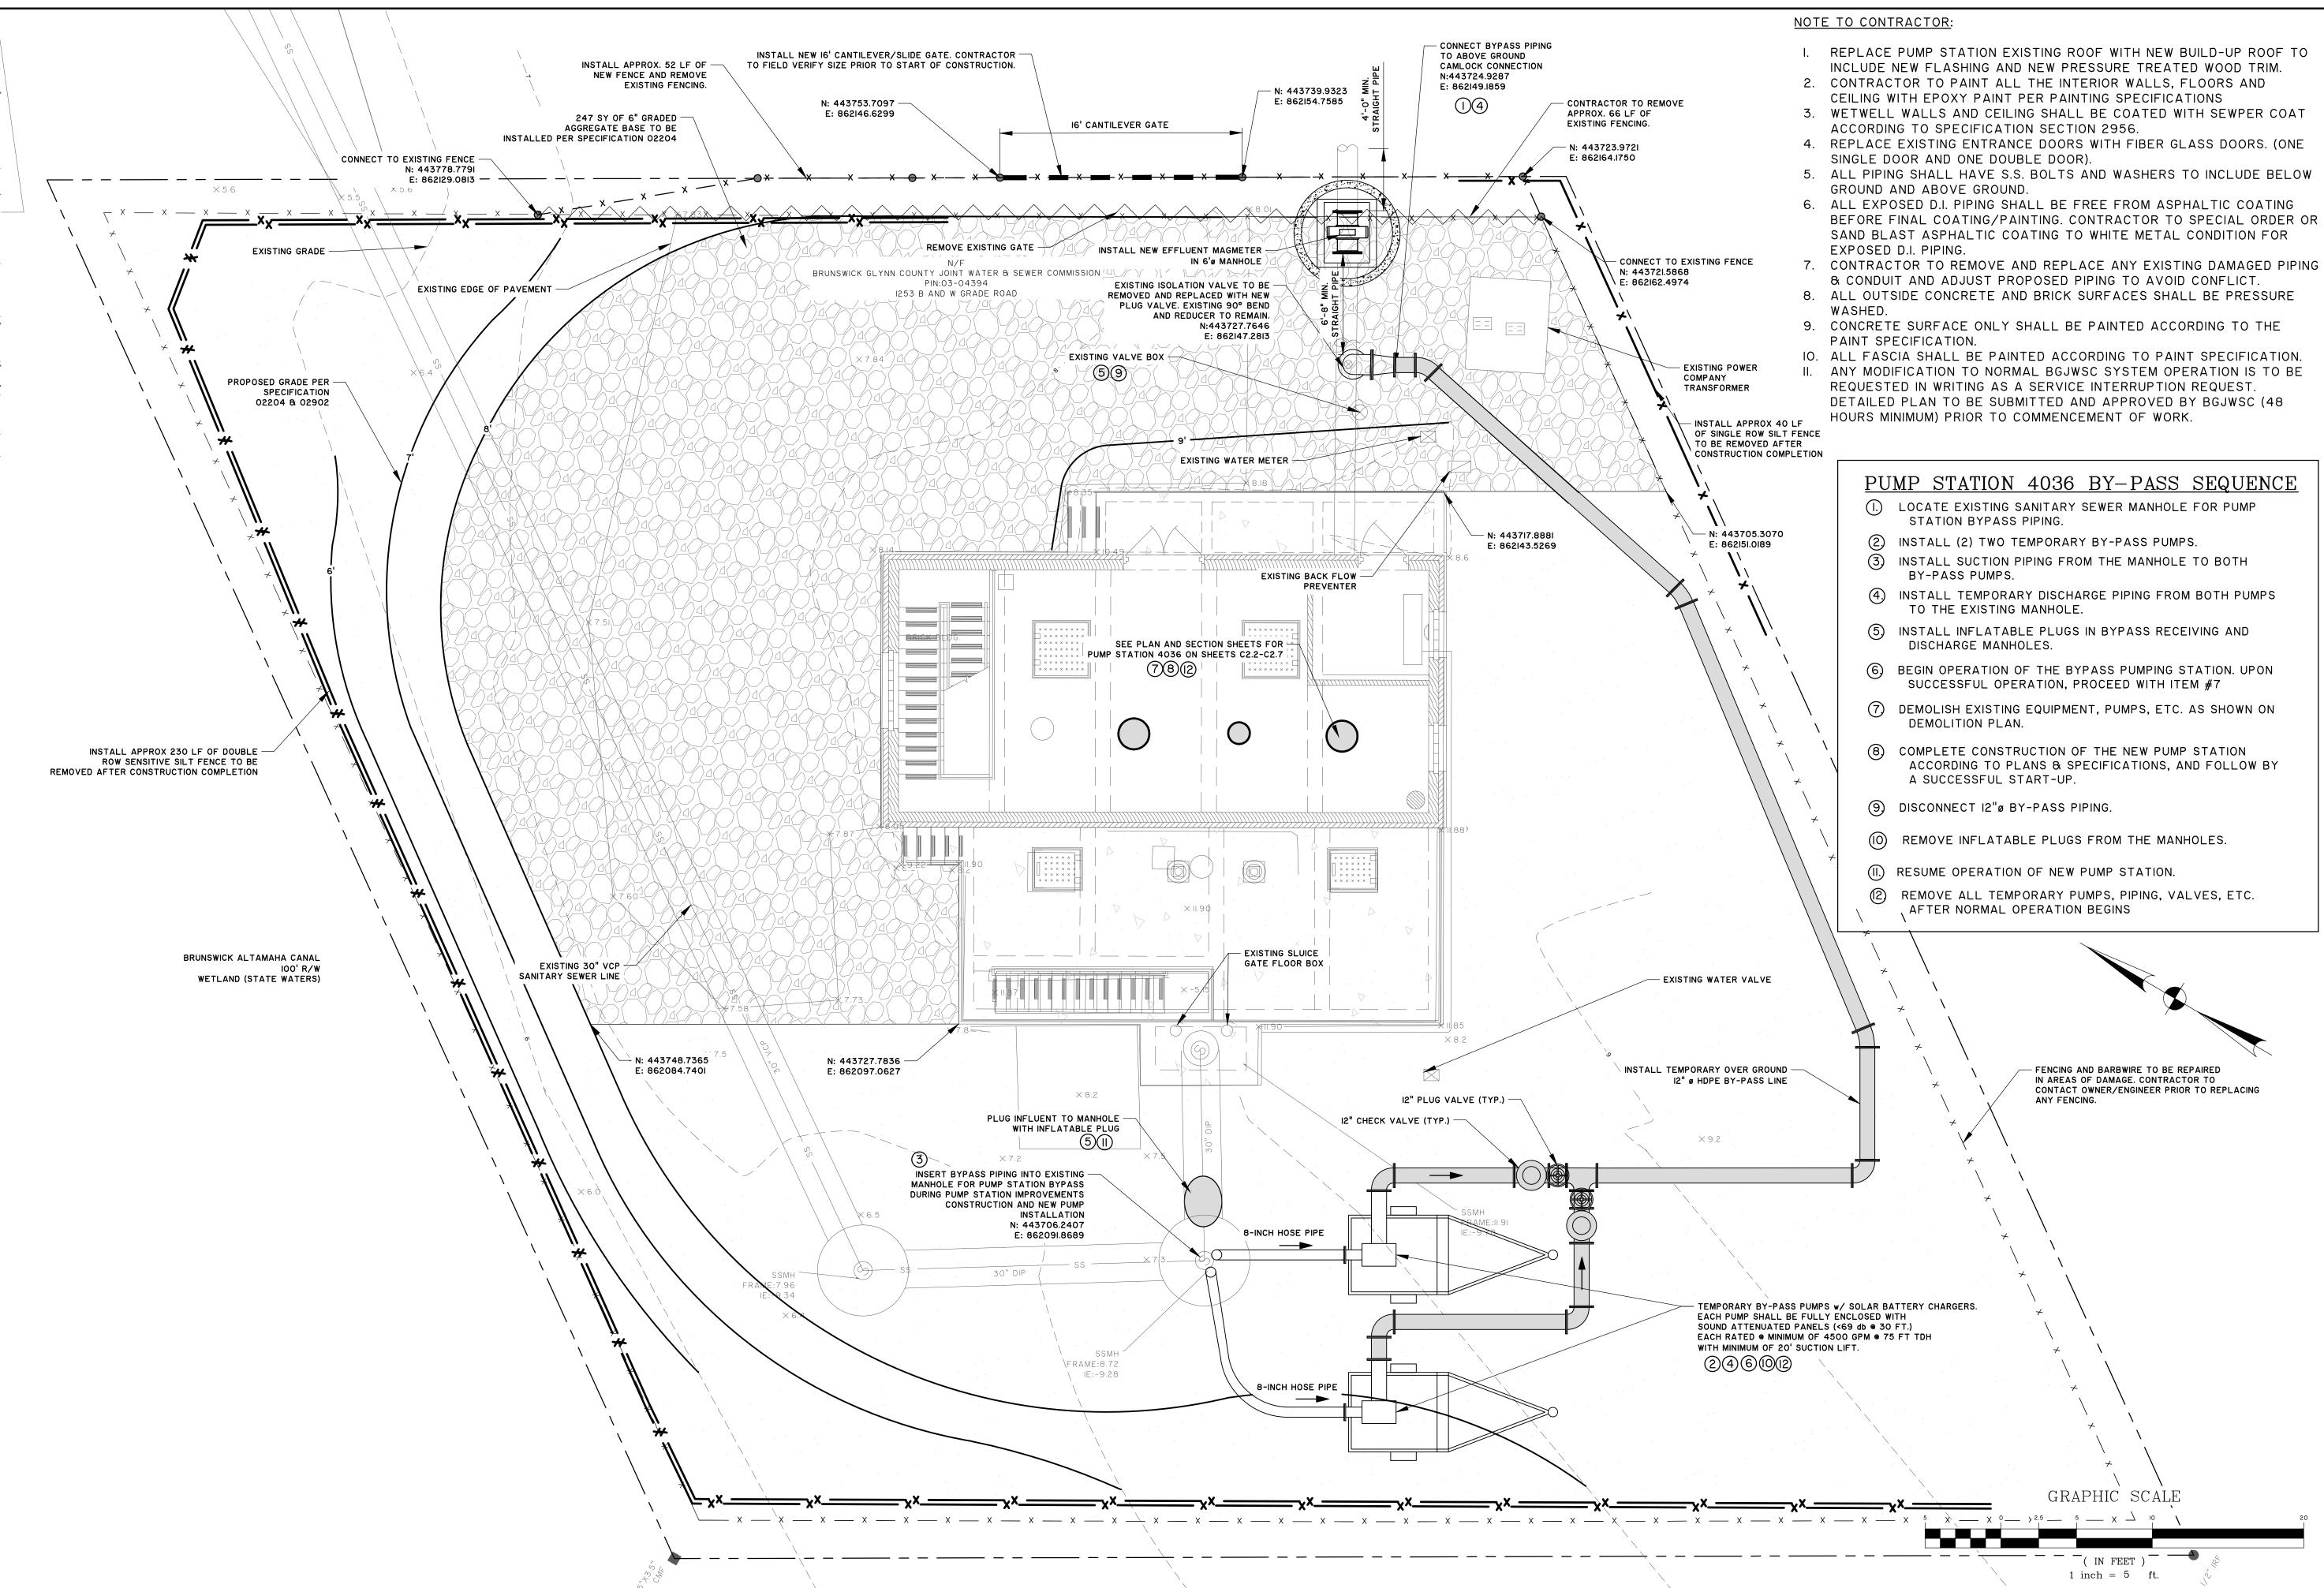



VO. REVISIONS BY DATE

HUTTON FICTION OF COMMERCE WAY

YNN JOINT WATER
IR COMMISSION
INSWICK, GA
ND PH-II PUMP STATION IMPROVEMENTS

BRUNSWICK, G.
2016 SPLOST NORTH MAINLAND PH-II PUMF

JOB NO: J-27784.00
DATE: 8/22/19
DRAWN: CDR
DESIGNED: CDR
REVIEWED: FS
APPROVED: FS
SCALE: I" = 5'

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C2.1



EXISTING ALUMINUM _

ACCESS DOORS

REMOVE EXISTING -

ELECTRICAL CONTROL BOX

CONTRACTOR TO REMOVE -

CONTRACTOR TO -REMOVE HEATER

EXISTING INTEGRATED

ACCESS HATCH

7 ½ KW ELEC. UNIT

HEATER

*CONSTULT WITH OWNER BEFORE DISPOSAL

REMOVE PROPELLER FAN

REMOVE EXISTING WALL

- REMOVE EXISTING PUMP

MOTOR AND BASE (TYP.)

REMOVE ALL ELECTRICAL BOXES AND COMPONENTS

> EXISTING ALUMINUM ACCESS DOORS

CONTRACTOR TO REMOVE

EXISTING ACCESS HATCH

₩**=**

- CONTRACTOR TO REMOVE

EXISTING ACCESS HATCH

NOTE TO CONTRACTOR:

- I. REPLACE PUMP STATION EXISTING ROOF WITH NEW BUILD-UP ROOF TO INCLUDE NEW FLASHING AND NEW PRESSURE TREATED WOOD TRIM.
- 2. CONTRACTOR TO PAINT ALL THE INTERIOR WALLS, FLOORS AND CEILING WITH EPOXY PAINT PER PAINTING SPECIFICATIONS
- 3. WETWELL WALLS AND CEILING SHALL BE COATED WITH SEWPER COAT ACCORDING TO
- SPECIFICATION SECTION 2956. 4. REPLACE EXISTING ENTRANCE DOORS WITH FIBER GLASS DOORS. (ONE SINGLE DOOR
- AND ONE DOUBLE DOOR). 5. ALL PIPING SHALL HAVE S.S. BOLTS AND WASHERS TO INCLUDE BELOW GROUND AND
- ABOVE GROUND. 6. ALL EXPOSED D.I. PIPING SHALL BE FREE FROM ASPHALTIC COATING BEFORE FINAL COATING/PAINTING. CONTRACTOR TO SPECIAL ORDER OR SAND BLAST ASPHALTIC COATING TO WHITE METAL CONDITION FOR EXPOSED D.I. PIPING.
- 7. CONTRACTOR TO REMOVE AND REPLACE ANY EXISTING DAMAGED PIPING & CONDUIT AND
- ADJUST PROPOSED PIPING TO AVOID CONFLICT.
- 8. ALL OUTSIDE CONCRETE AND BRICK SURFACES SHALL BE PRESSURE WASHED. 9. CONCRETE SURFACE ONLY SHALL BE PAINTED ACCORDING TO THE PAINT
- SPECIFICATION.
- IO. ALL FASCIA SHALL BE PAINTED ACCORDING TO PAINT SPECIFICATION.
- II. ANY MODIFICATION TO NORMAL BGJWSC SYSTEM OPERATION IS TO BE REQUESTED IN WRITING AS A SERVICE INTERRUPTION REQUEST. DETAILED PLAN TO BE SUBMITTED AND APPROVED BY BGJWSC (48 HOURS MINIMUM) PRIOR TO COMMENCEMENT OF WORK.

INSTALL ALUMINUM HANDRAIL -

CONTRACTOR TO REMOVE EXISTING

CONTRACTOR TO REPLACE EXISTING — METAL DOORS WITH NEW FIBERGLASS FRAME AND DOORS (SEE SHEET 2.9)

(SEE DETAILS ON SHEET

C2.IO AND C2.II)

WITH INTEGRATED SAFETY GRATE HATCH.

CONTRACTOR TO —


REPLACE HEATER

FIELD VERIFY SIZE OF OPENING.

7 ½ KW ELEC. UNIT


HEATER

HATCH SHALL BE RATED FOR H-20 LOADING.

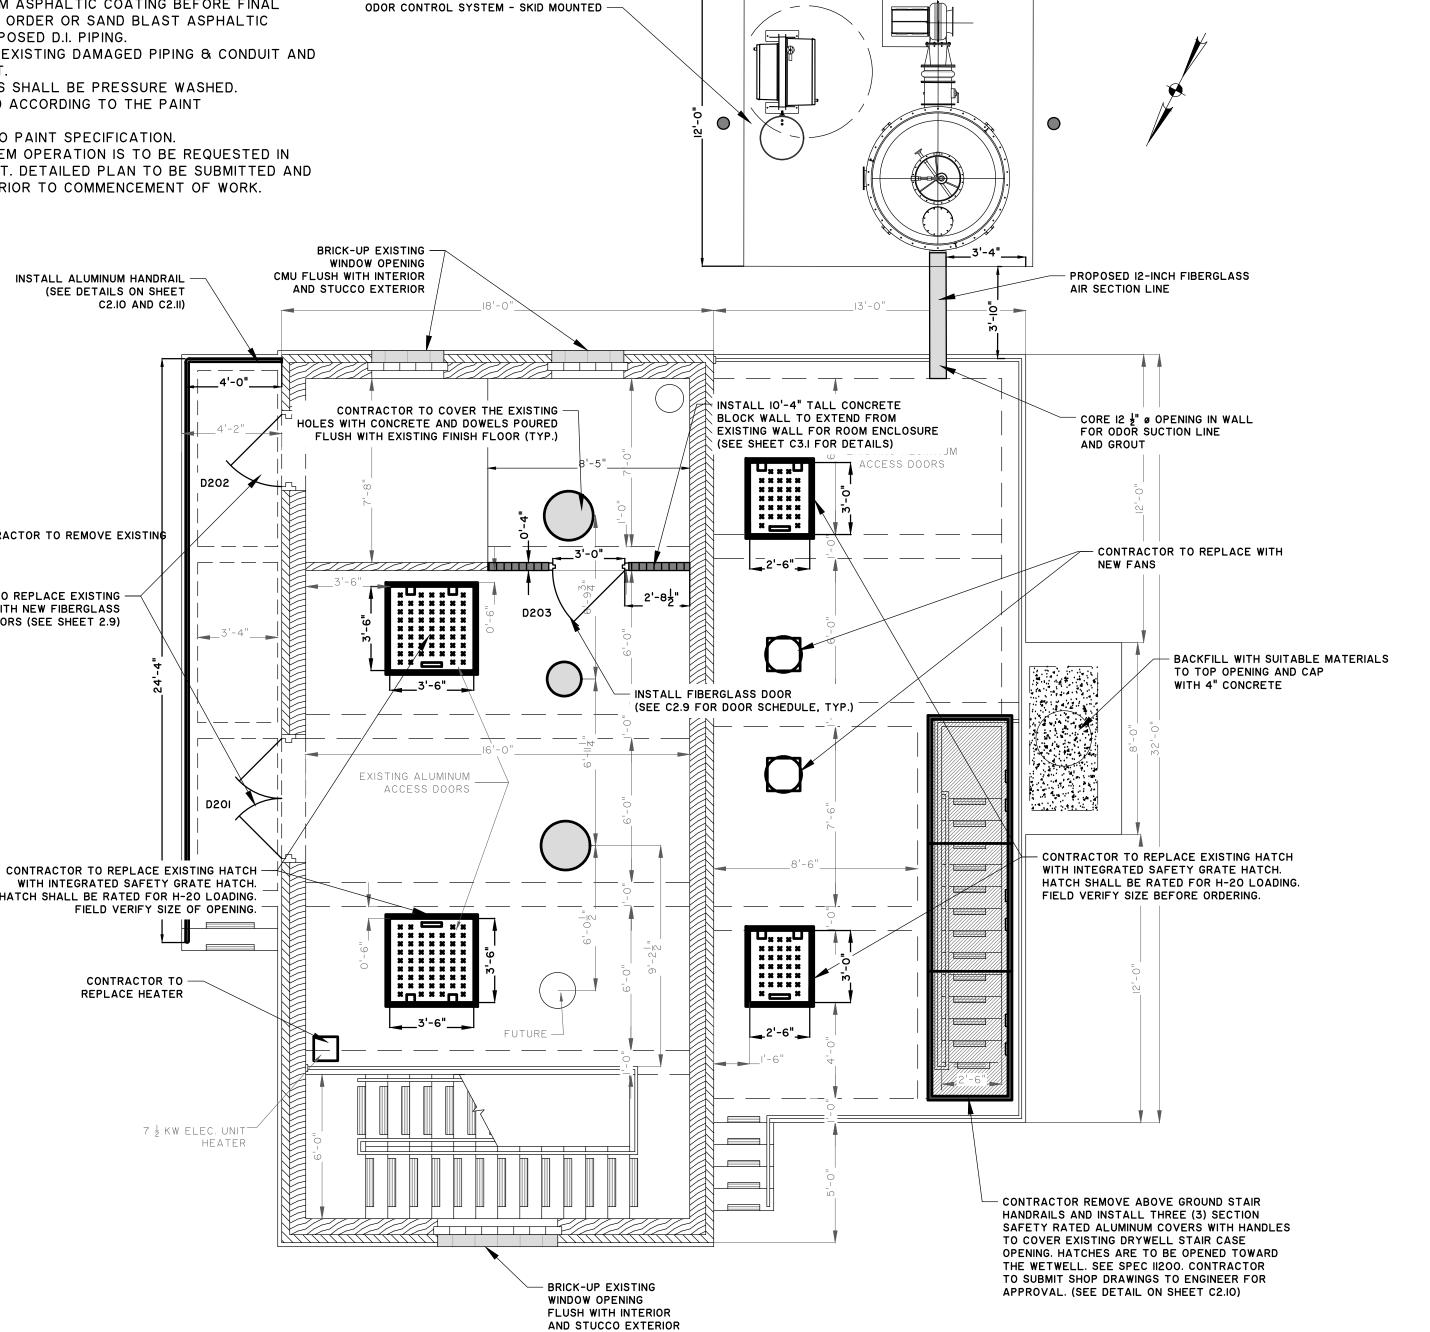


CONTRACTOR TO INSTALL BOLLARDS

(SEE DETAIL)

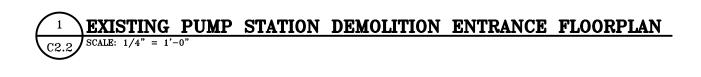





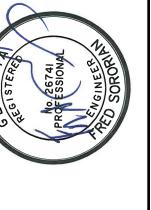

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BRUNSWICK-GLYNN JOINT WATE AND SEWER COMMISSION NORTH MAINLAND PH-II PUMP STATION

DRAWN: CDR DESIGNED: CDR REVIEWED: FS APPROVED: FS

SCALE: ¼" = 1'

TO BE REMOVED AND DISPOSED OFFSITE*


PROPOSED NEW INSTALLATION

*CONSTULT WITH OWNER BEFORE DISPOSAL

NOTE TO CONTRACTOR:

- I. REPLACE PUMP STATION EXISTING ROOF WITH NEW BUILD-UP ROOF TO INCLUDE NEW FLASHING AND NEW PRESSURE TREATED
- 2. CONTRACTOR TO PAINT ALL THE INTERIOR WALLS, FLOORS AND CEILING WITH EPOXY PAINT PER PAINTING SPECIFICATIONS
- 3. WETWELL WALLS AND CEILING SHALL BE COATED WITH SEWPER COAT ACCORDING TO SPECIFICATION SECTION 2956.
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REQUEST. DETAILED PLAN TO BE SUBMITTED AND APPROVED BY BGJWSC (48 HOURS MINIMUM) PRIOR TO COMMENCEMENT OF

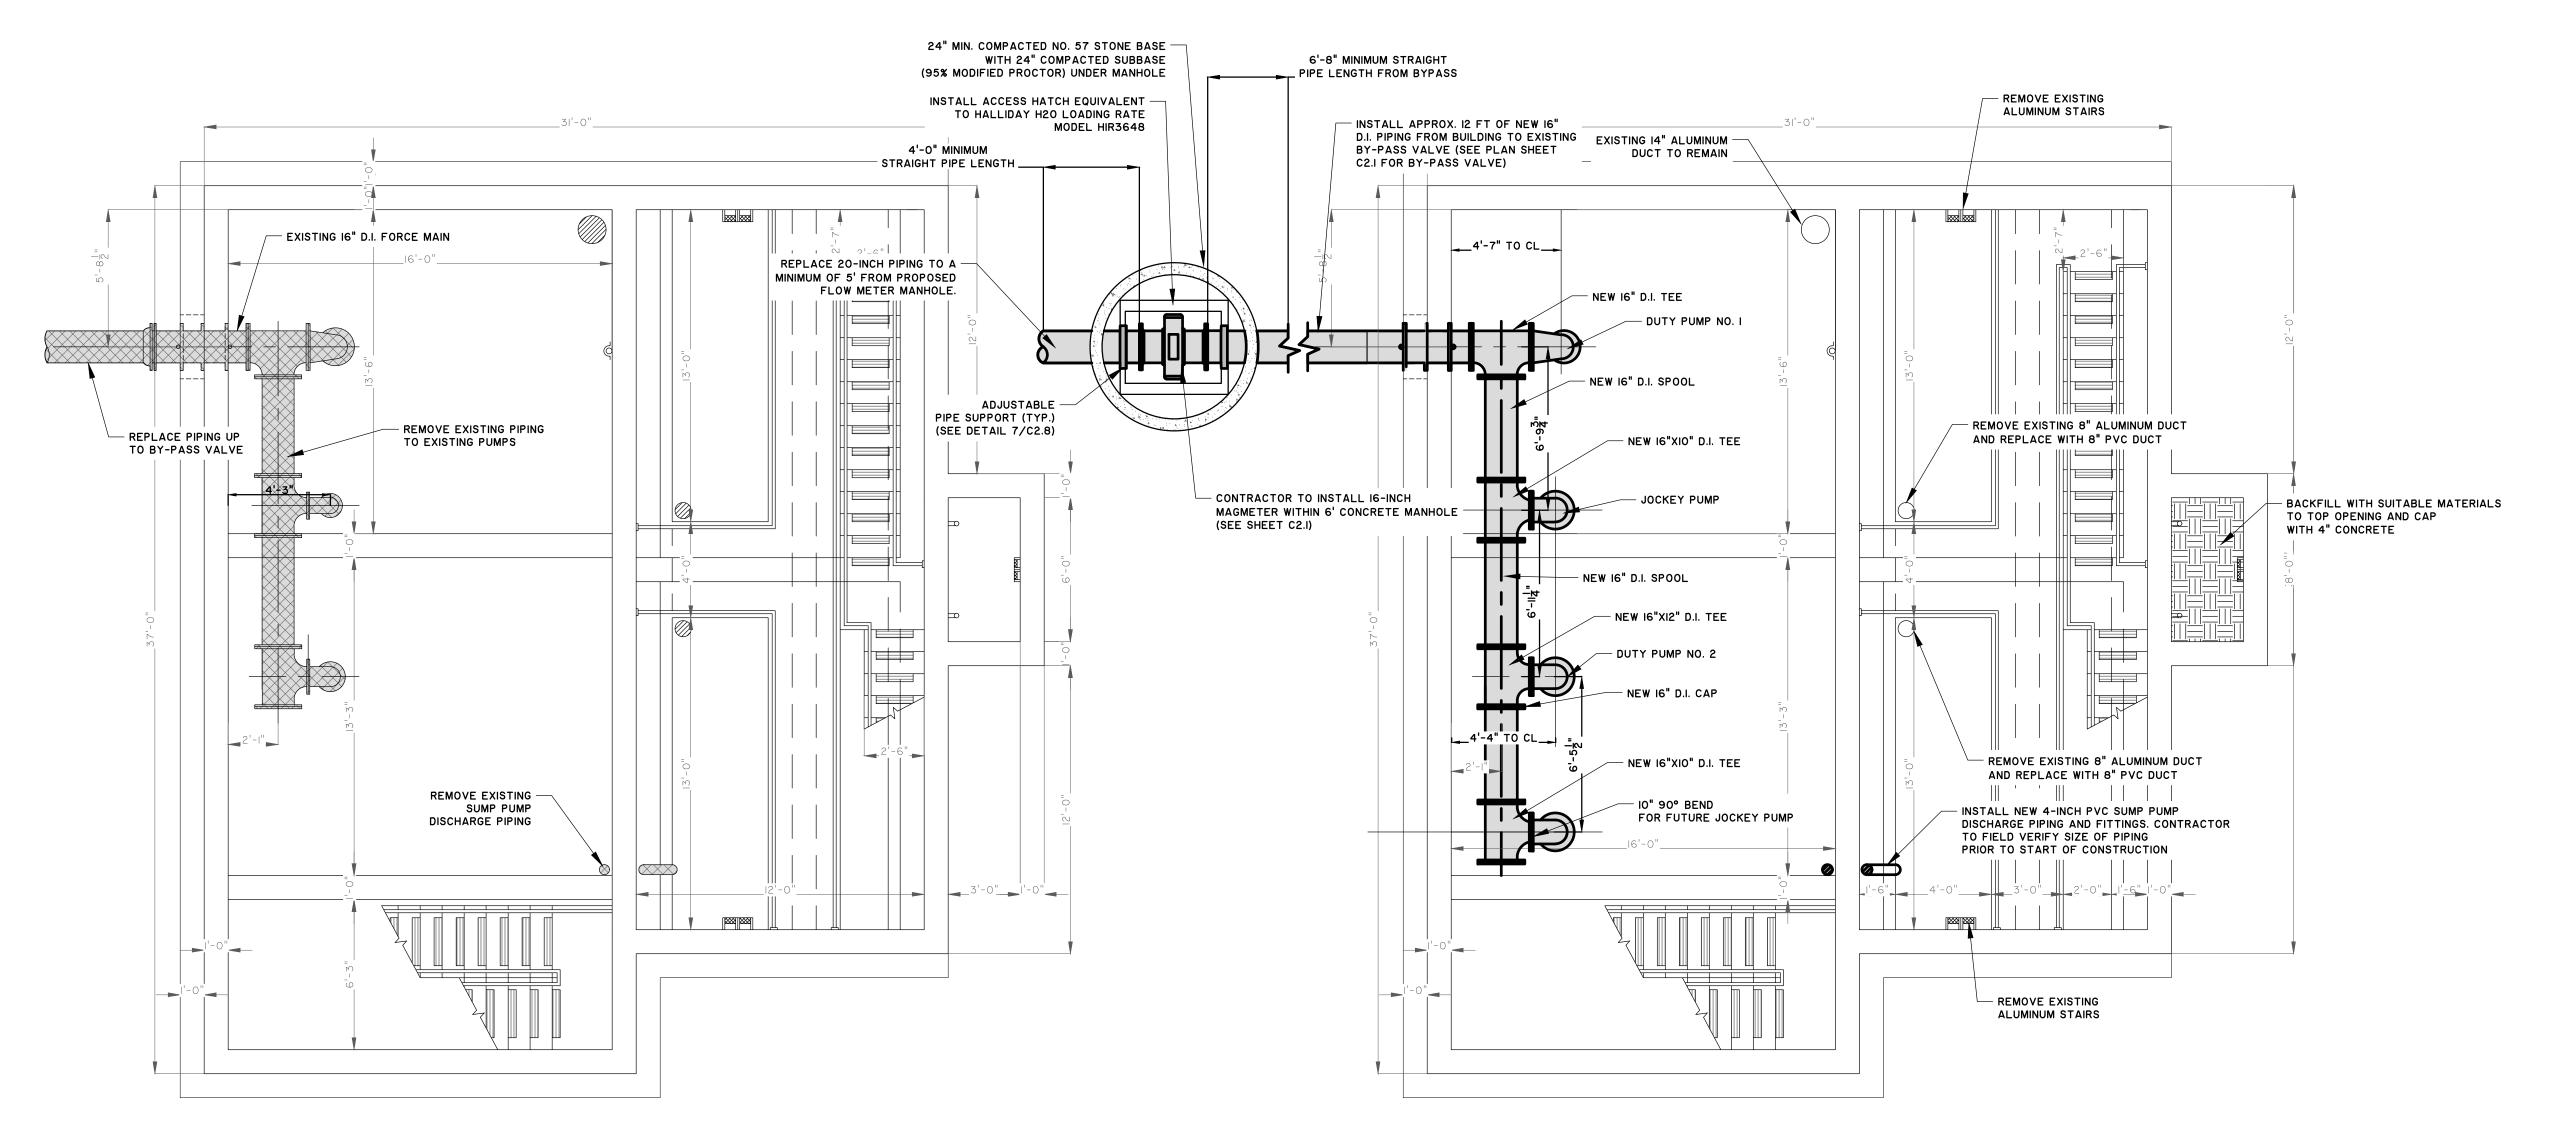


EXISTING PUMP STATION DEMOLITION INTERMEDIATE PLAN

C2.3 SCALE: 1/4" = 1'-0"

MODIFICATION TO PUMP STATION INTERMEDIATE PLAN

C2.3 SCALE: 1/4" = 1'-0"



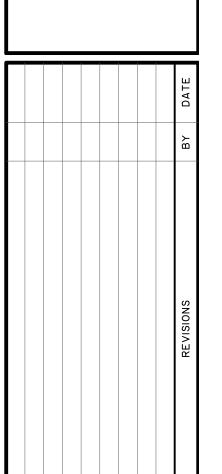


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BRUNSWICK-GLYNN JOINT WATER AND SEWER COMMISSION

DRAWN: CDR DESIGNED: CDR REVIEWED: FS APPROVED: FS


*CONSTULT WITH OWNER BEFORE DISPOSAL

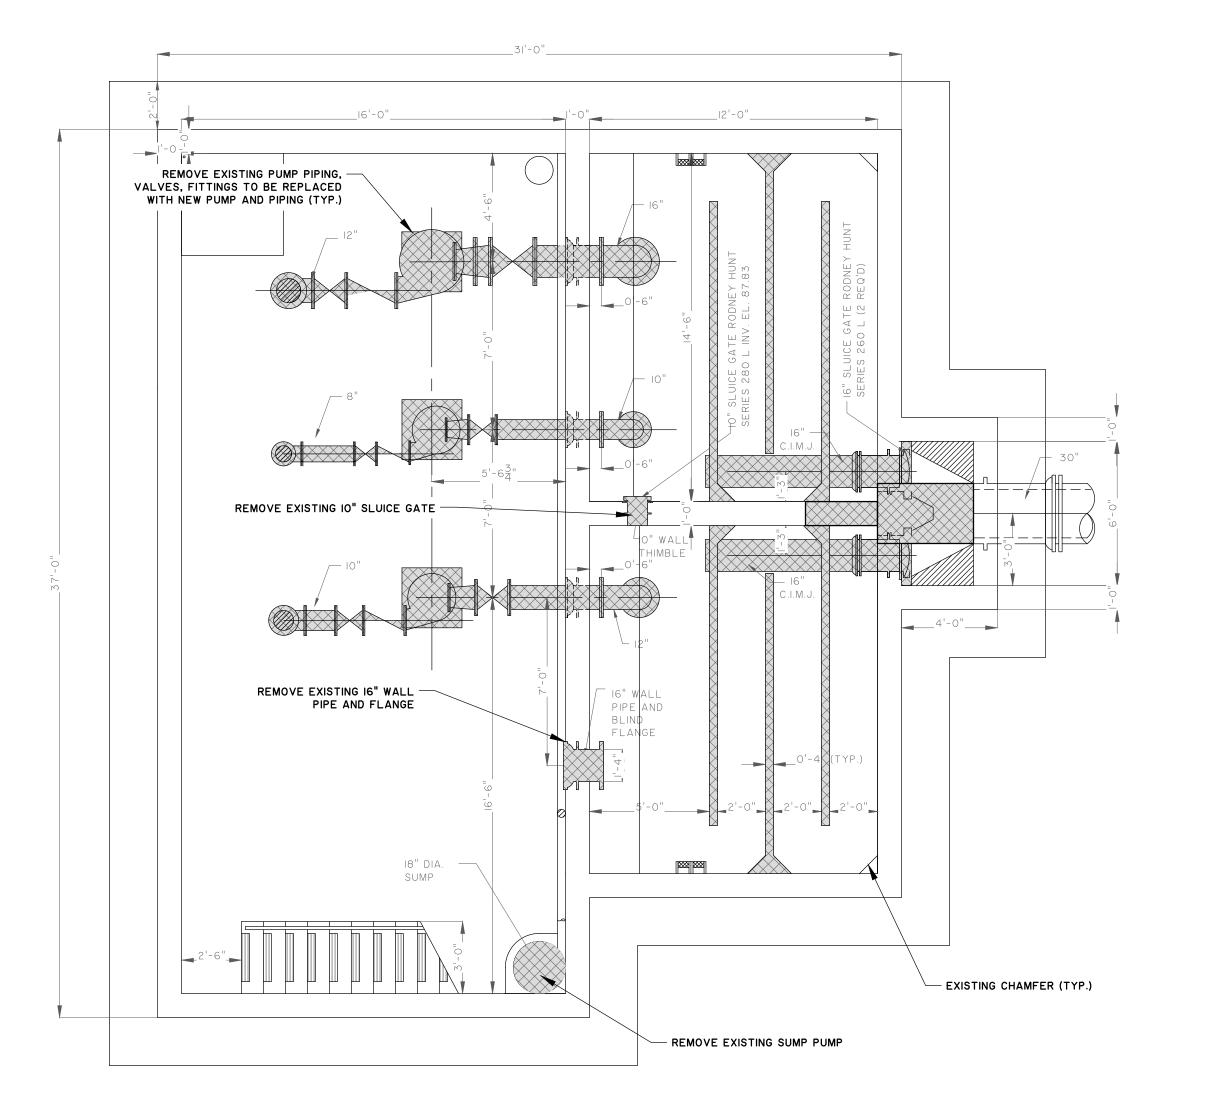

EXISTING PUMP STATION DEMOLITION BOTTOM PLAN


NOTE TO CONTRACTOR:


- I. REPLACE PUMP STATION EXISTING ROOF WITH NEW BUILD-UP ROOF TO INCLUDE NEW FLASHING AND NEW PRESSURE TREATED WOOD TRIM.
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2 MODIFICATION TO PUMP STATION BOTTOM PLAN

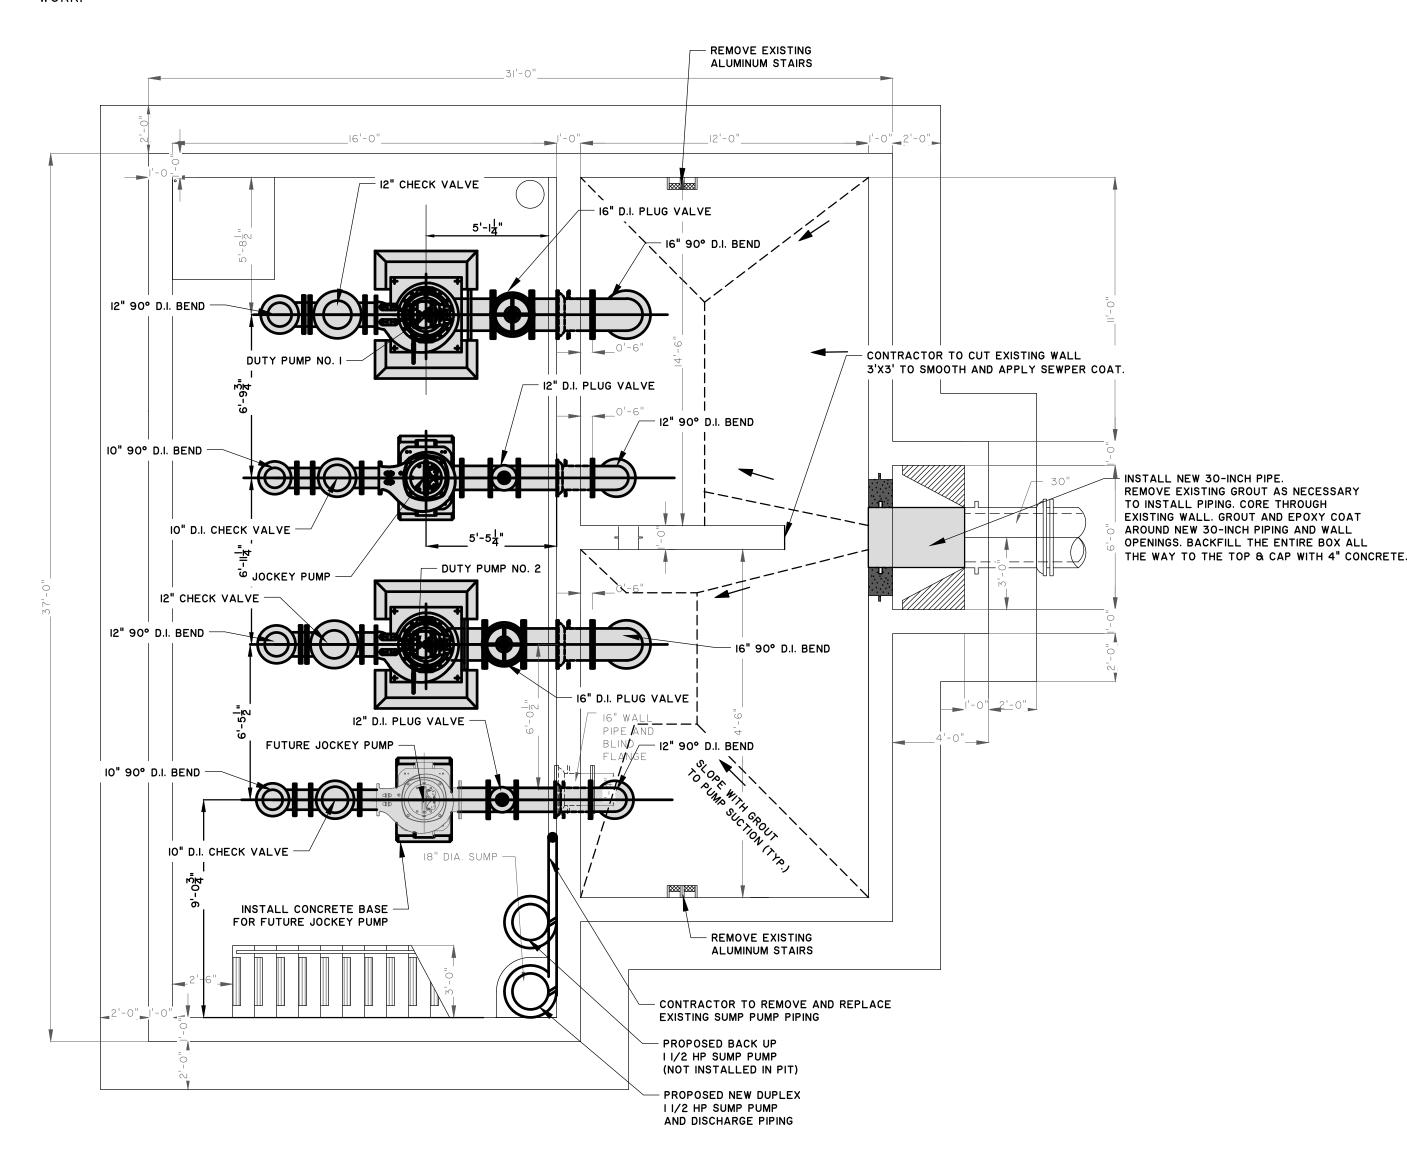



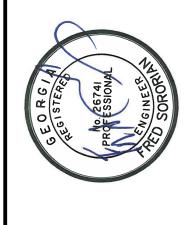

MAS TON

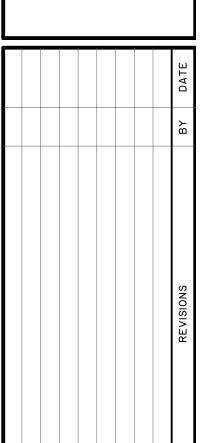BRUNSWICK-GLYNN JOINT WATER AND SEWER COMMISSION

CDR DRAWN: DESIGNED: CDR REVIEWED: FS APPROVED: FS

*CONSTULT WITH OWNER BEFORE DISPOSAL


REMOVE EXISTING ROOF REMOVE EXISTING — SUMP PUMP DISCHARGE PIPING REMOVE -EXTENSION REMOVE -EXTENSION EXTENSION - EXISTING CONCRETE BEAM (TYP.) DEMOLISH EXISTING CONCRETE
 PAD, CONDUITS, AND ALL RELATED
 PIPING AND VALVES (TYP)

EXISTING PUMP STATION DEMOLITION ELEVATION FACING SOUTHWEST

C2.5 SCALE: 1/4" = 1'

NOTE TO CONTRACTOR:


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MODIFICATION TO PUMP STATION ELEVATION FACING SOUTHWEST

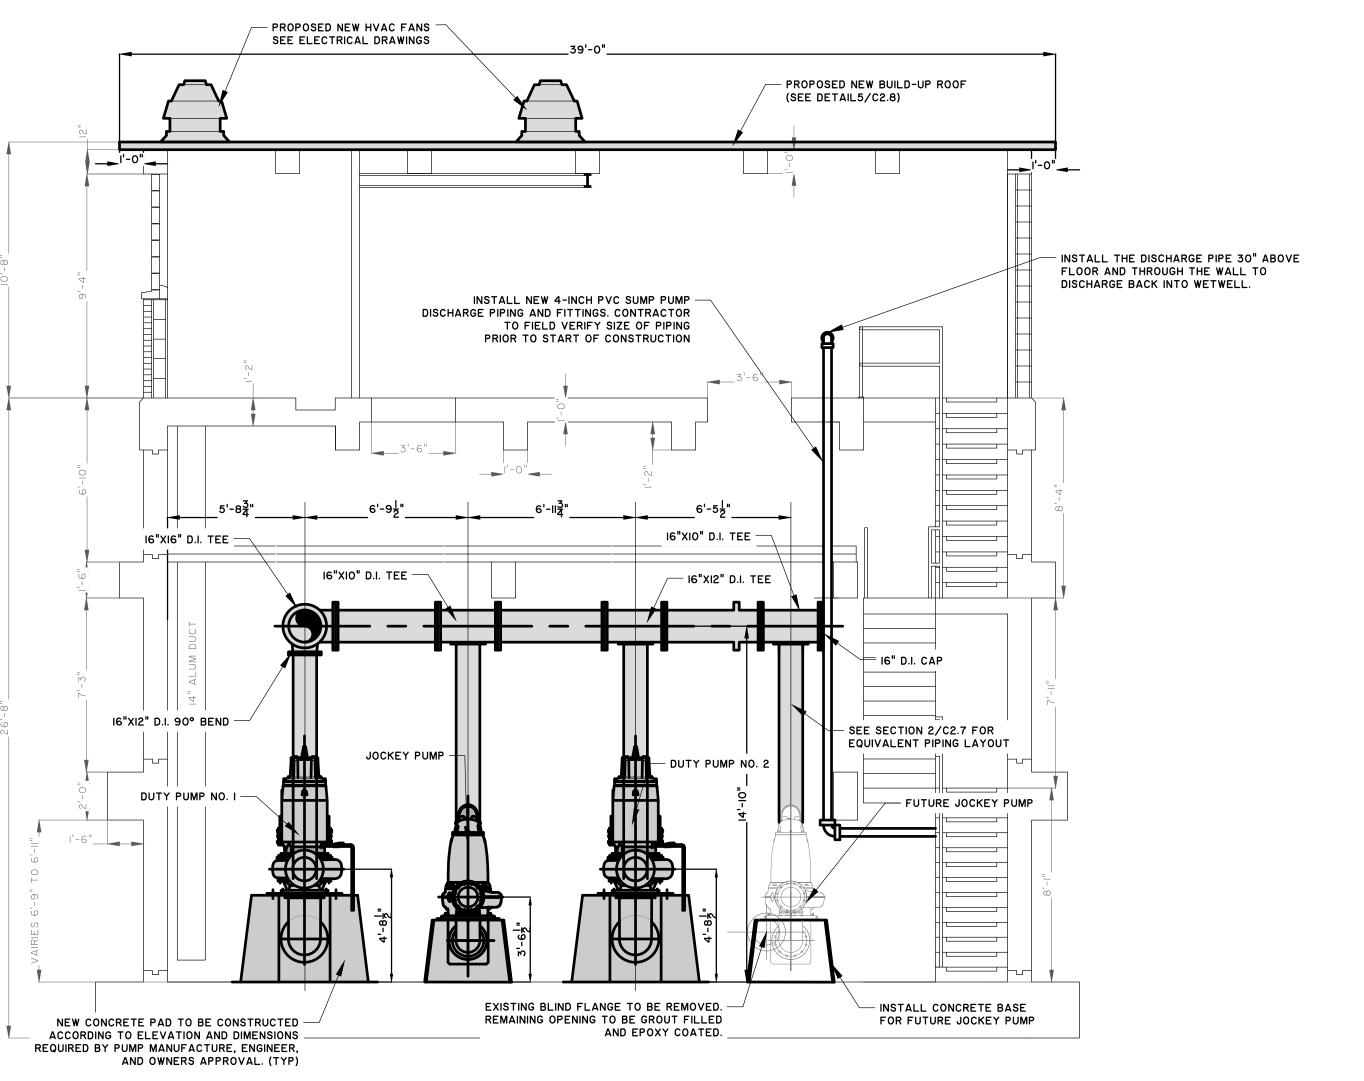C2.5 SCALE: 1/4" = 1'







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BRUNSWICK-GLYNN JOINT WATER AND SEWER COMMISSION

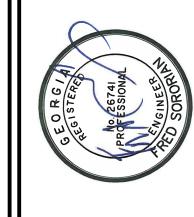DRAWN: CDR DESIGNED: CDR REVIEWED: FS APPROVED: FS



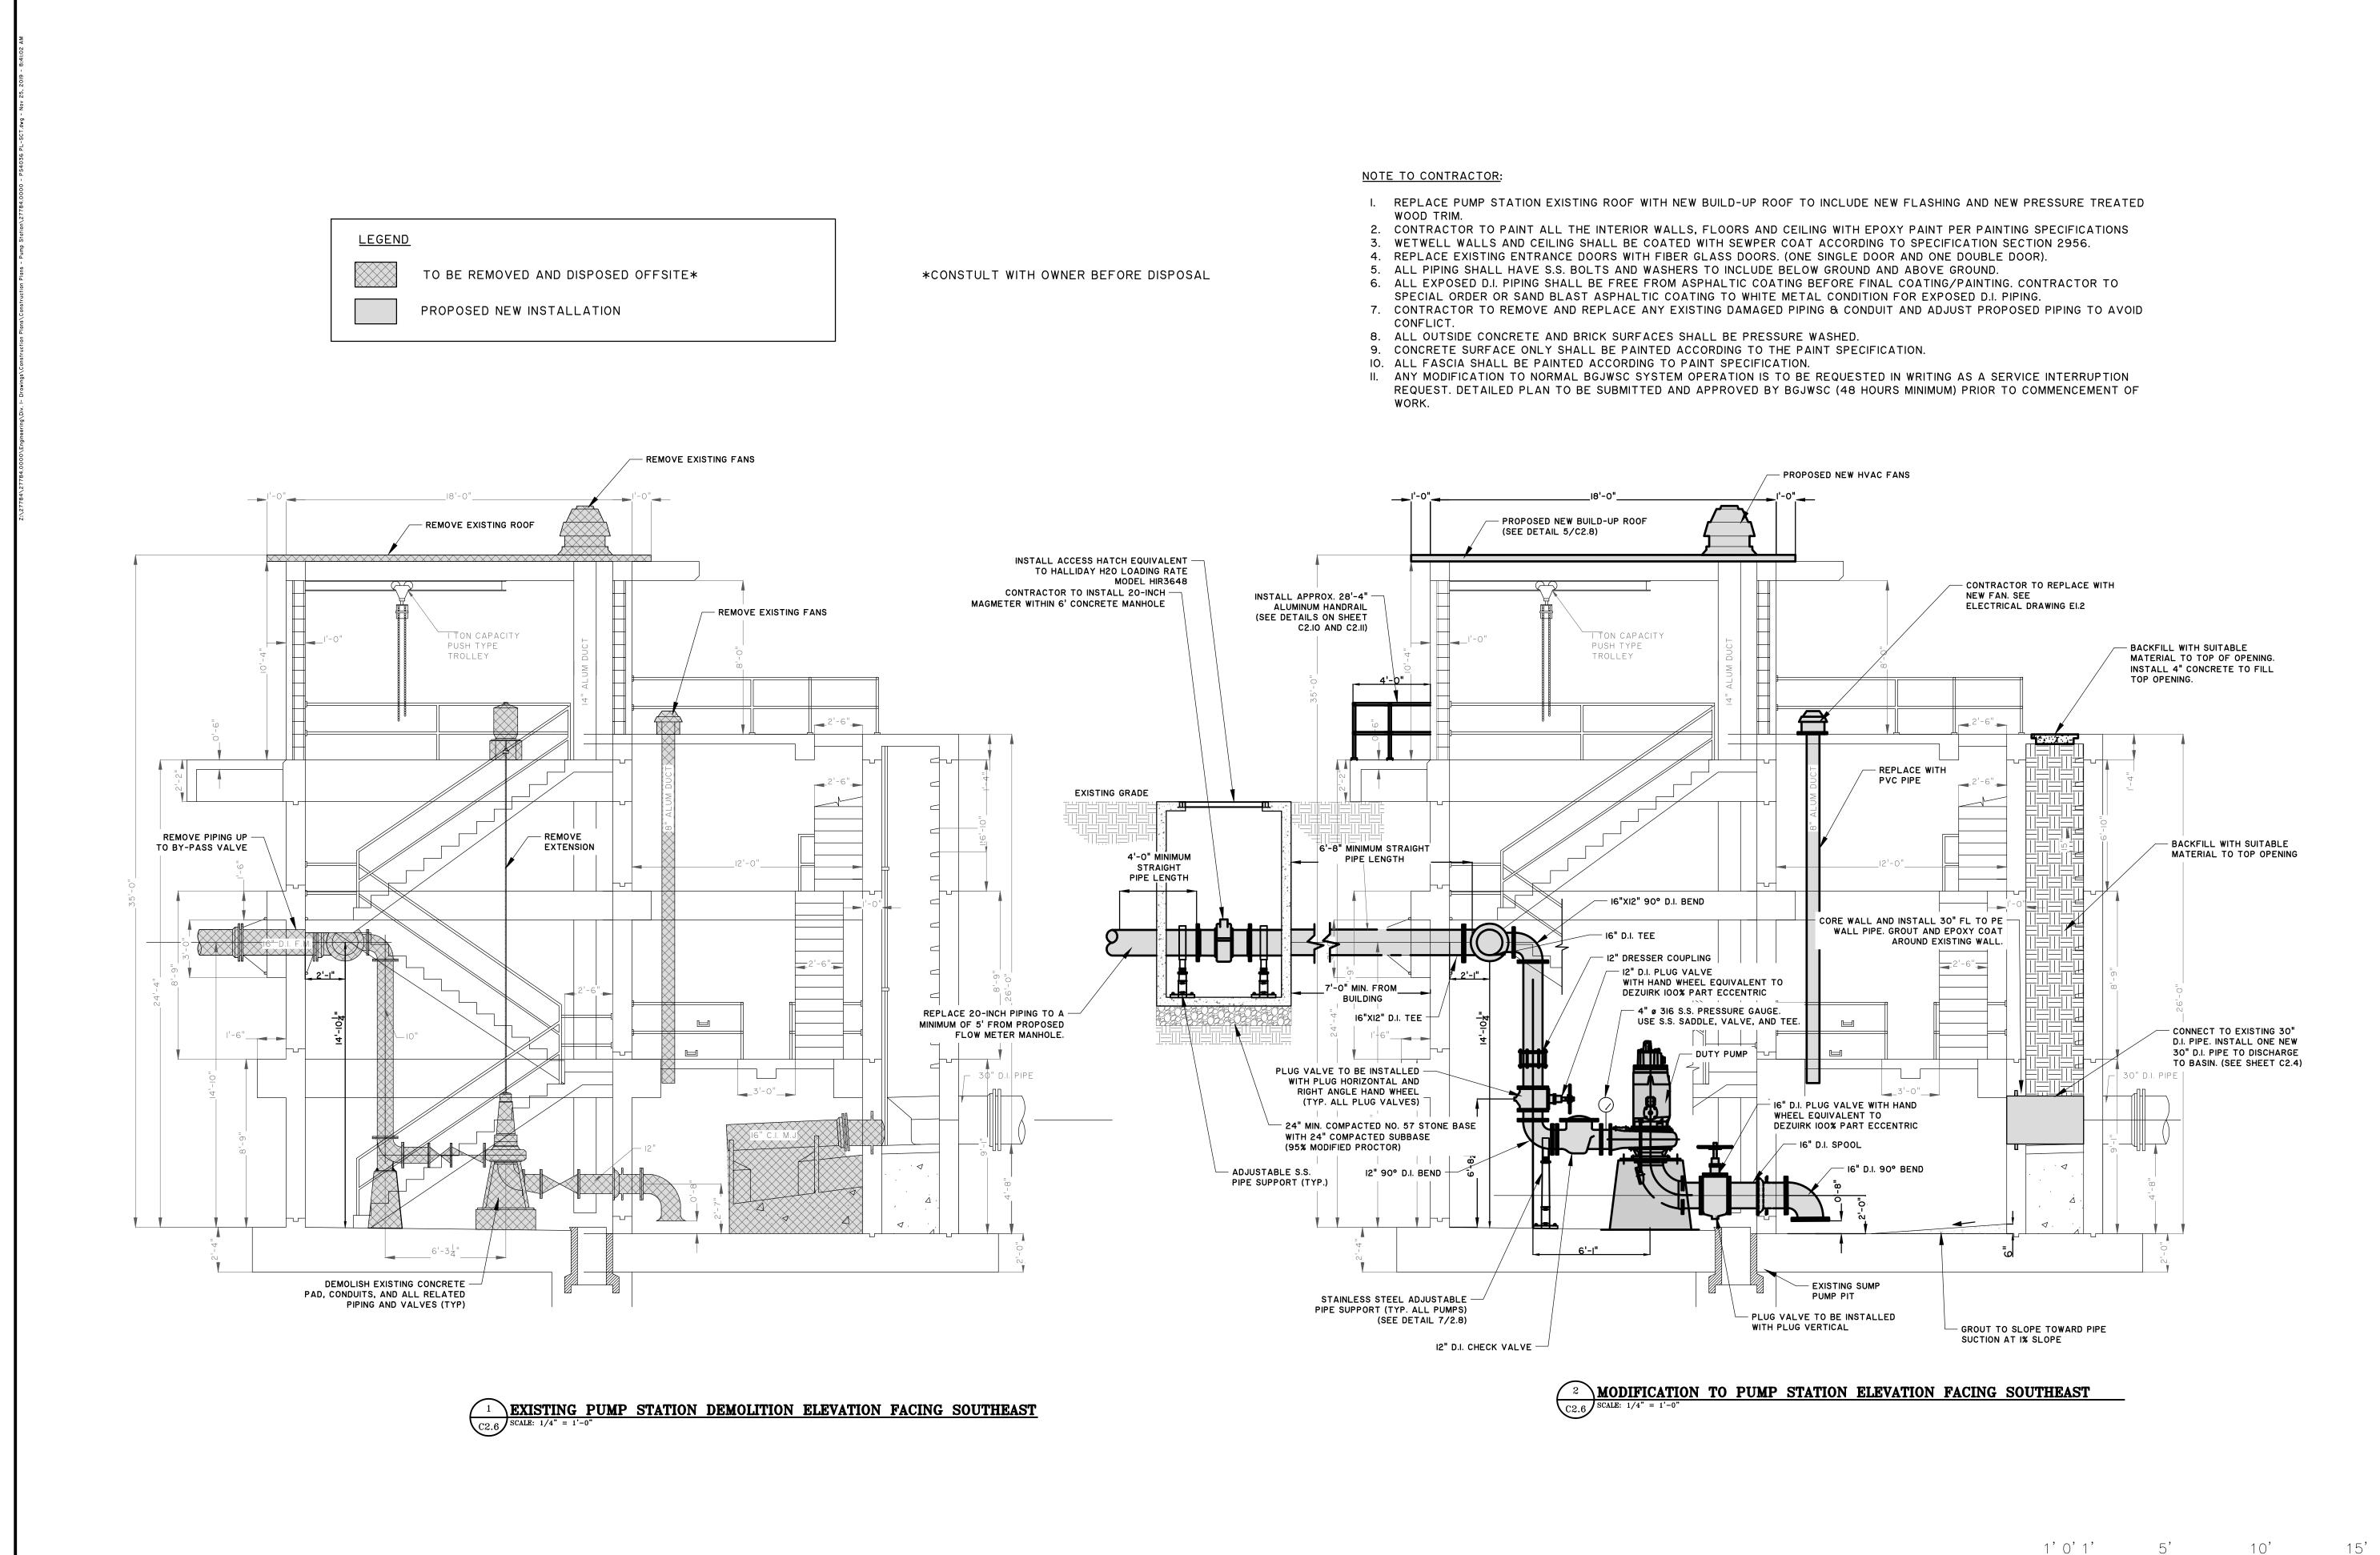

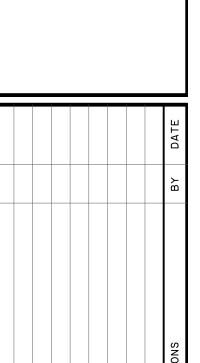

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BRUNSWICK-GLYNN JOINT WAT AND SEWER COMMISSION

DRAWN: CDR DESIGNED: CDR REVIEWED: FS APPROVED: FS SCALE: /4" = 1'




*CONSTULT WITH OWNER BEFORE DISPOSAL

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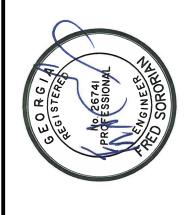
EXISTING PUMP STATION DEMOLITION ELEVATION FACING SOUTHEAST JOCKEY PUMP

C2.7 SCALE: 1/4" = 1'

MODIFICATION TO PUMP STATION ELEVATION FACING SOUTHEAST JOCKEY PUMP

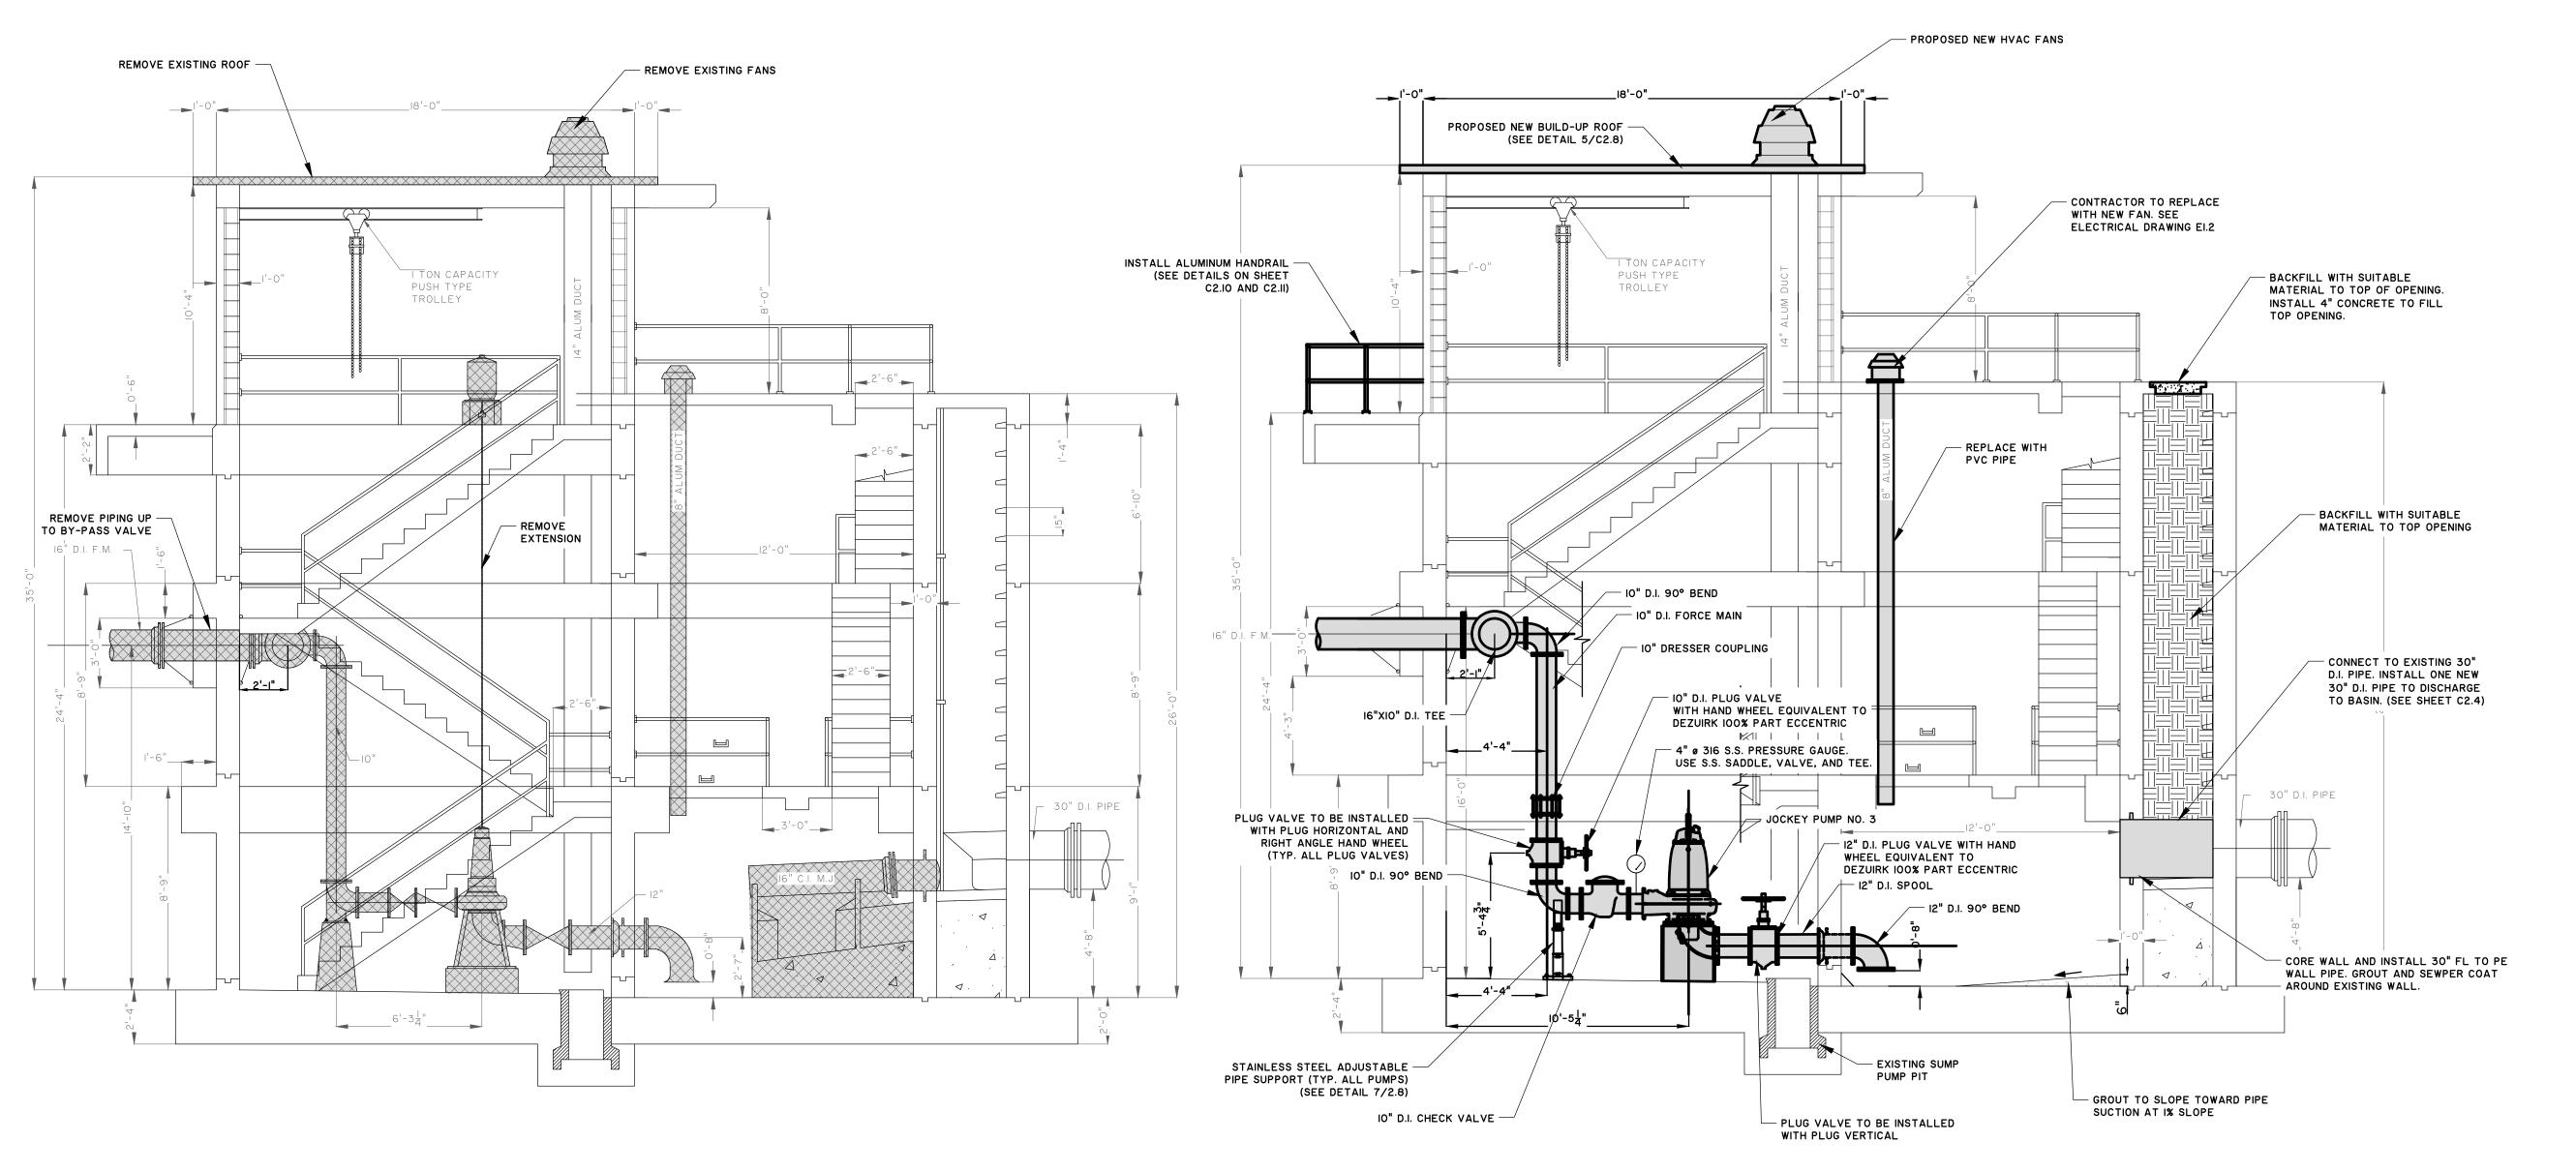C2.7 SCALE: 1/4" = 1'








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BRUNSWICK-GLYNN JOINT WATE AND SEWER COMMISSION

DRAWN: CDR DESIGNED: CDR REVIEWED: FS APPROVED: FS



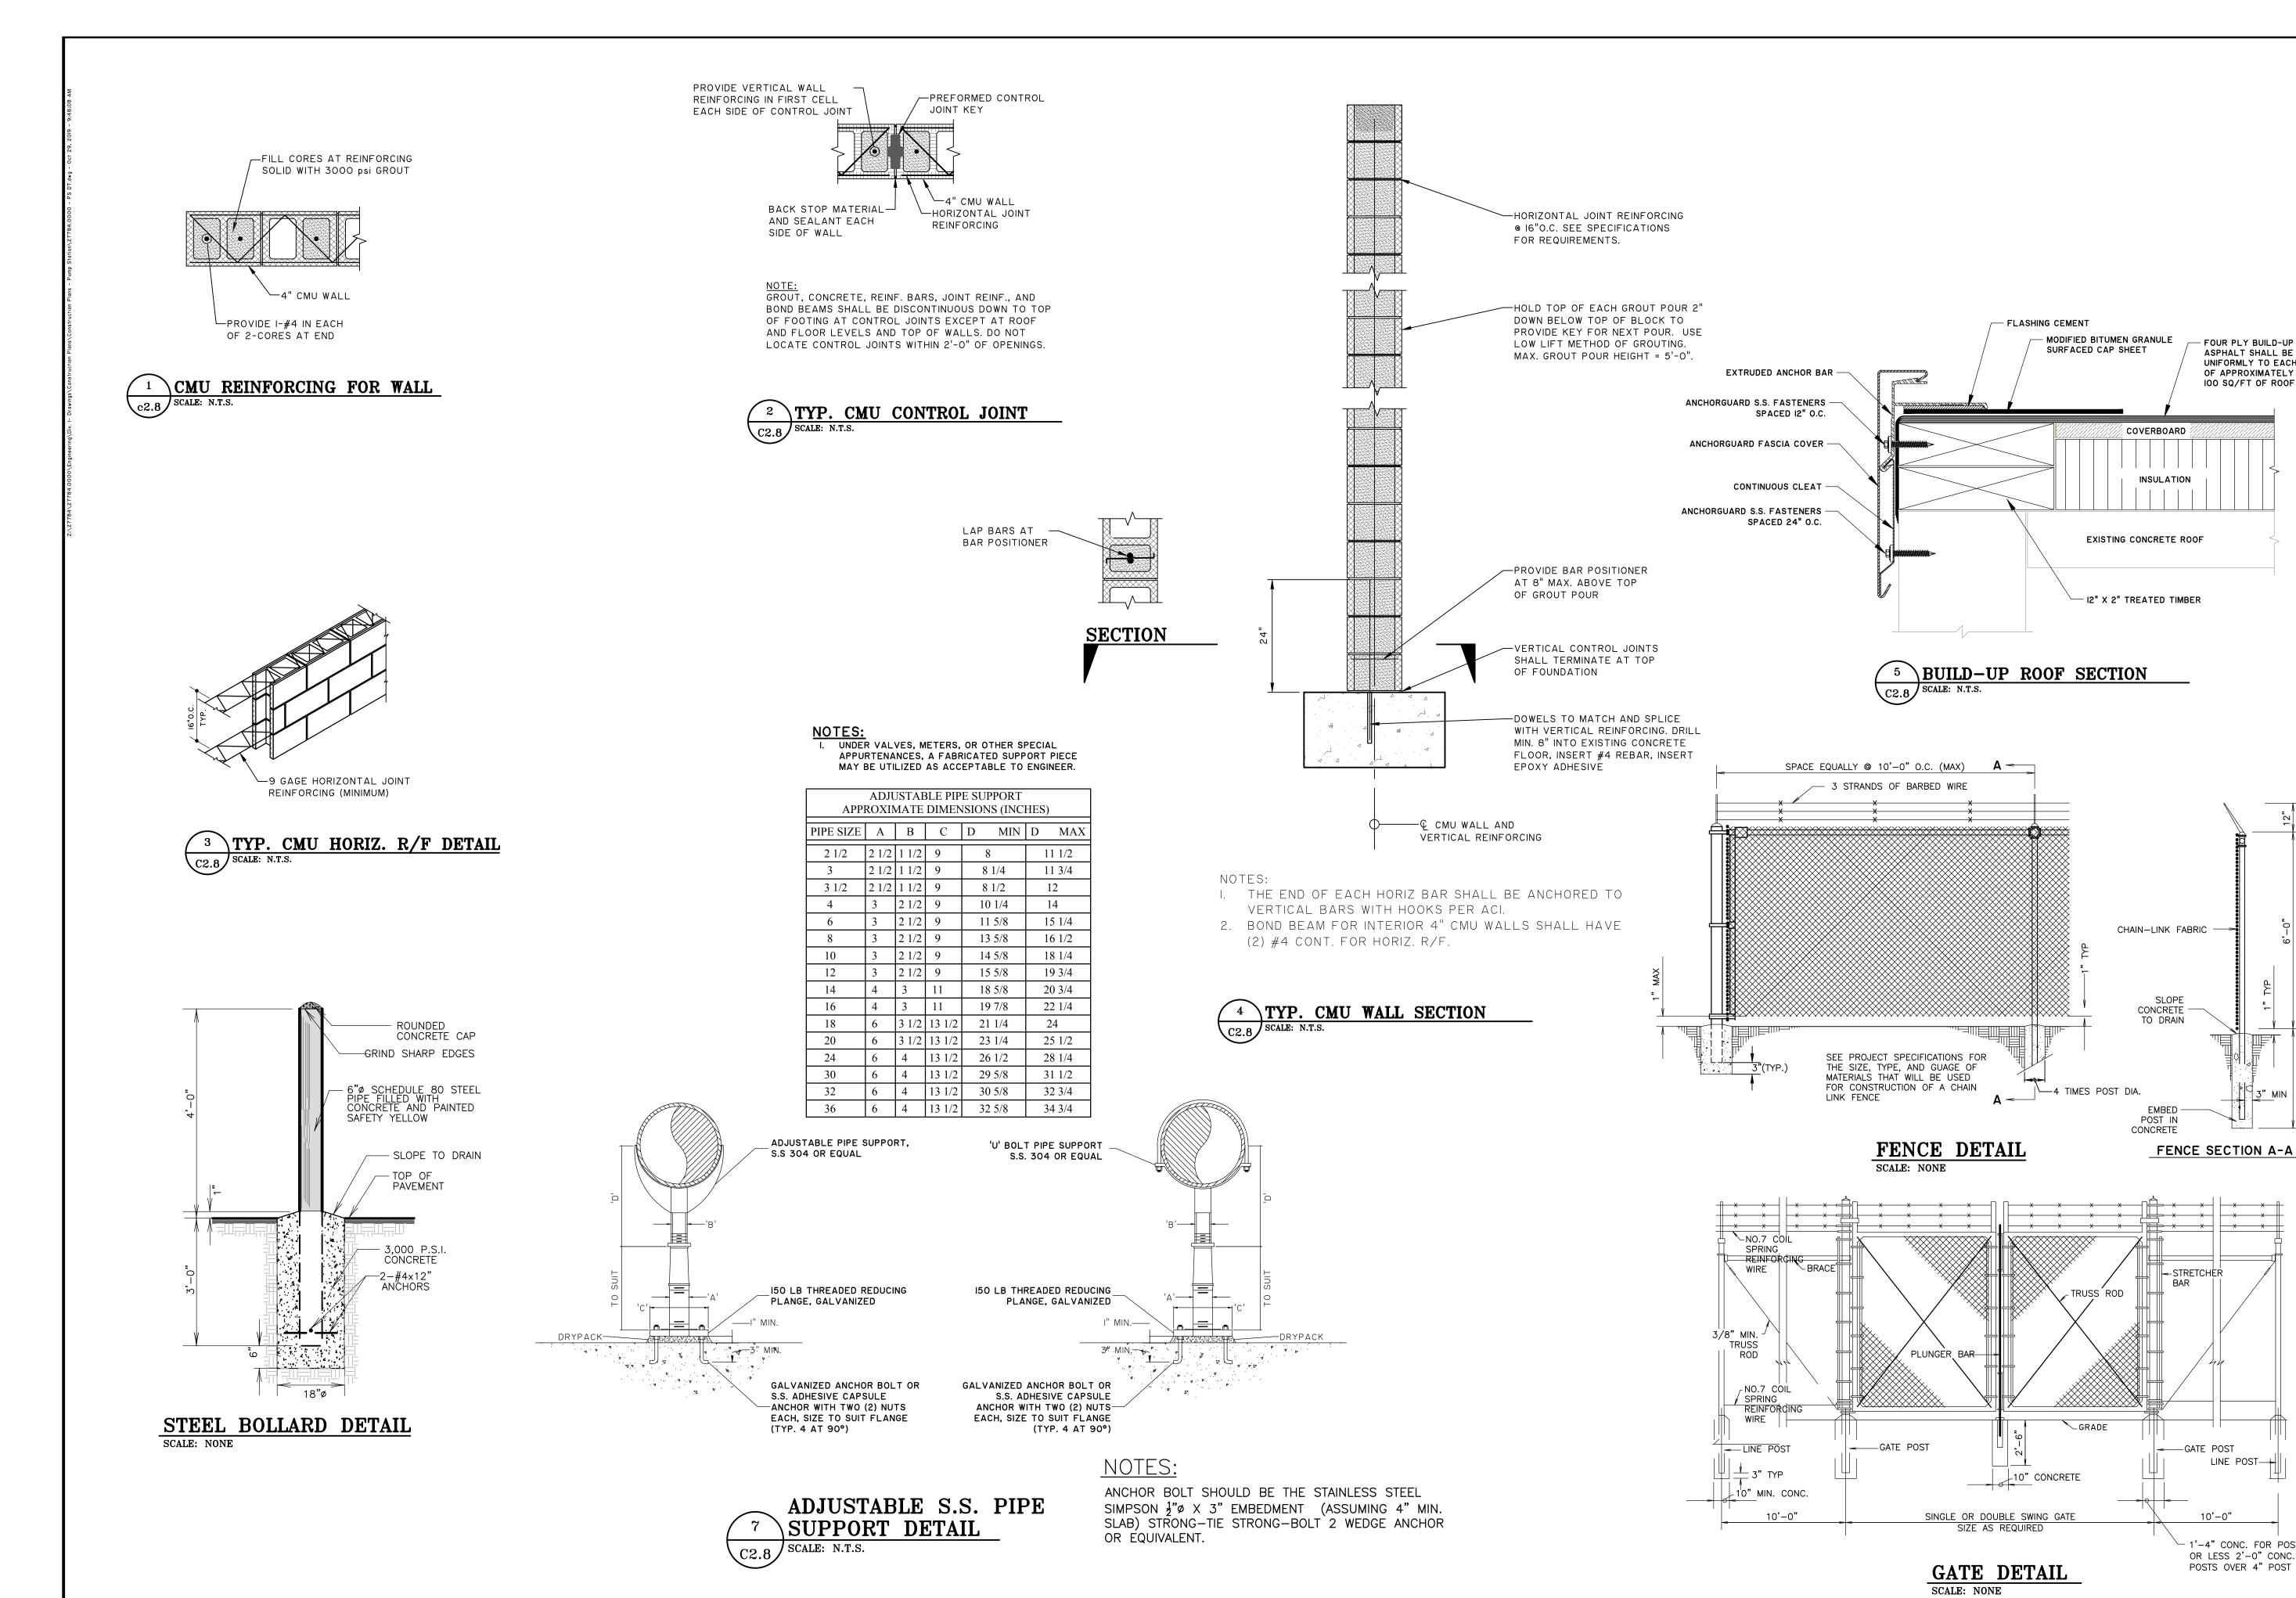

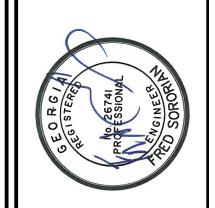

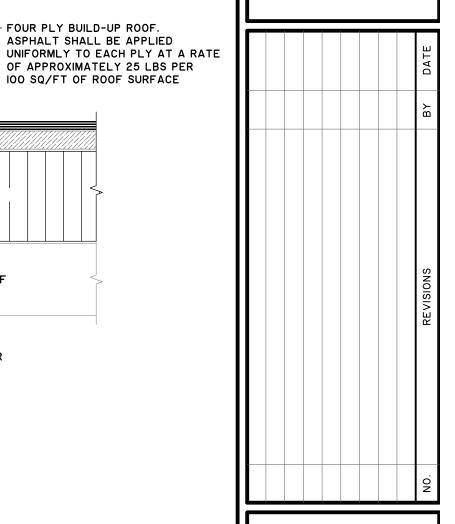- FOUR PLY BUILD-UP ROOF.
ASPHALT SHALL BE APPLIED

100 SQ/FT OF ROOF SURFACE

STRETCHER

GATE POST


LINE POST-+

1'-4" CONC. FOR POSTS 4"
OR LESS 2'-0" CONC. FOR
POSTS OVER 4" POST OVER 4"


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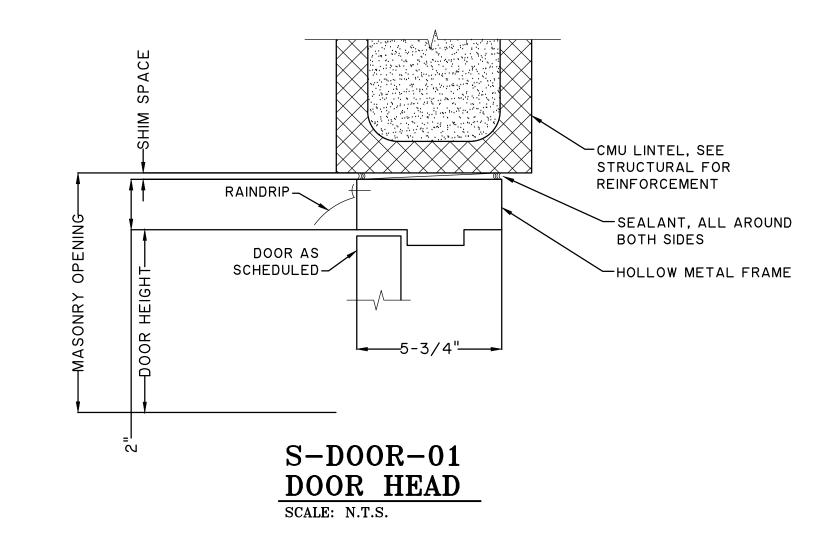
BRUNSWICK-GLYNN JOINT WATER AND SEWER COMMISSION


DRAWN: CDR DESIGNED: CDR REVIEWED: FS APPROVED: FS CALE: NONE

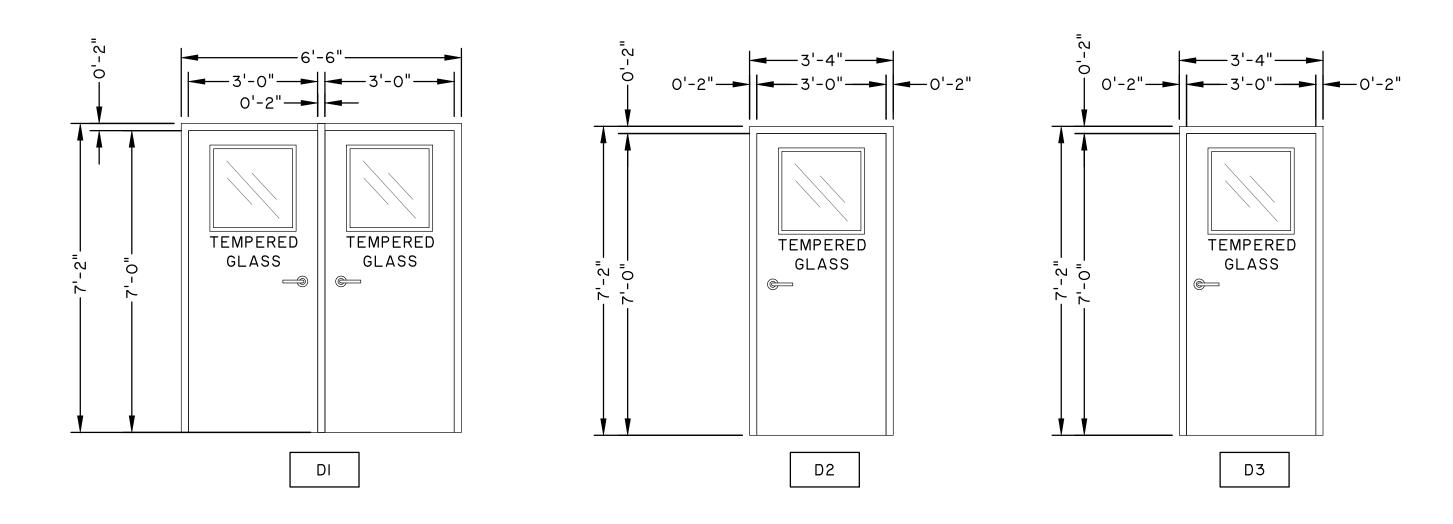



	DOOR SCHEDULE																		
DIIMD CMAMION	DOOR	DOOR	DOOR	DOOR	DOOR	DOOR	DIMENS		ONS		DOOR				FRAME		DOOR DETAILS		
PUMP STATION.	NO.		WIDTH	HEIGHT	THICKNESS	MATERIAL	FINISH	GLASS	FIRE LABEL	MATERIAL	FINISH	HEAD	JAMB	SILL	MISC.				
PS 4035	DIOI	DI	6'-2"	7'-0"	I-3/4"	FIBERGLASS	PAINT	IMPACT RESISTANT	_	FIBERGLASS	PAINT	S-DOOR-I	S-DOOR-I	S-DOOR-2	CLOSER				
PS 4035	DIO2	D2	3'-0"	7'-0"	I-3/4"	FIBERGLASS	PAINT	IMPACT RESISTANT	_	FIBERGLASS	PAINT	S-DOOR-I	S-DOOR-I	S-DOOR-2	CLOSER				
PS 4035	DIO3	D3	3'-0"	7'-0"	I-3/4"	FIBERGLASS	PAINT	IMPACT RESISTANT		FIBERGLASS	PAINT	S-DOOR-I	S-DOOR-I	S-DOOR-2					
PS 4036	D20I	DI	6'-2"	7'-0"	I-3/4"	FIBERGLASS	PAINT	IMPACT RESISTANT		FIBERGLASS	PAINT	S-DOOR-I	S-DOOR-I	S-DOOR-2	CLOSER				
PS 4036	D202	D2	3'-0"	7'-0"	I-3/4"	FIBERGLASS	PAINT	IMPACT RESISTANT		FIBERGLASS	PAINT	S-DOOR-I	S-DOOR-I	S-DOOR-2	CLOSER				
PS 4036	D203	D3	3'-0"	7'-0"	I-3/4"	FIBERGLASS	PAINT	IMPACT RESISTANT		FIBERGLASS	PAINT	S-DOOR-I	S-DOOR-I	S-DOOR-2					



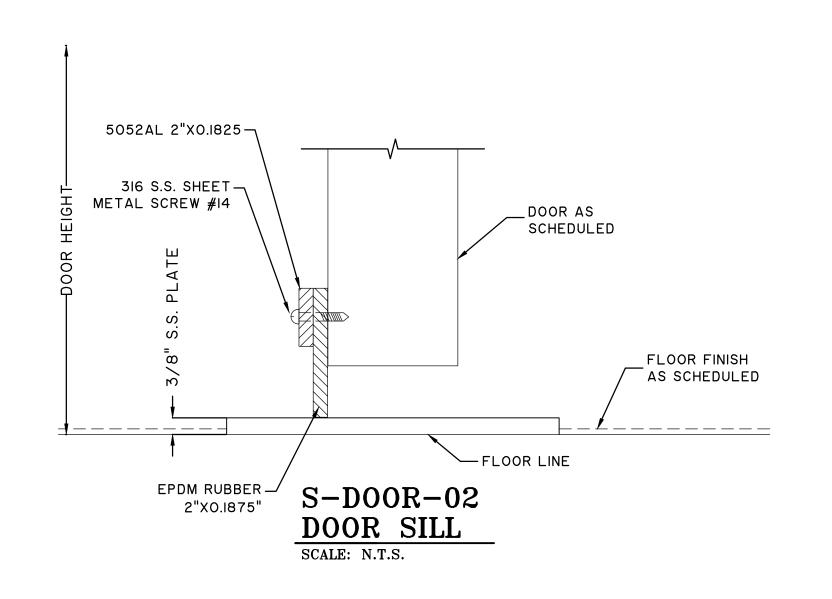

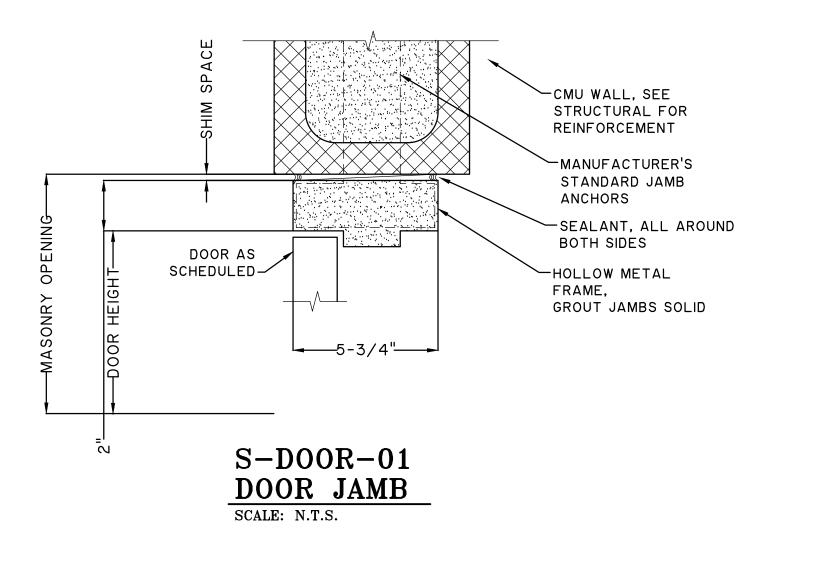

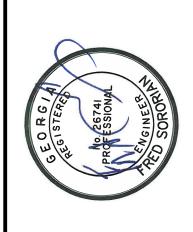

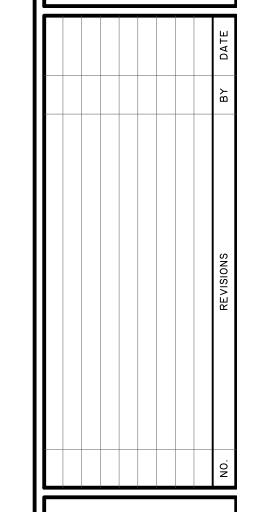


THOMAS HUTTON


BRUNSWICK-GLYNN JOINT WATER
AND SEWER COMMISSION
BRUNSWICK, GA

JOB NO: J-27784.0000
DATE: 8/22/19
DRAWN: CDR
DESIGNED: CDR
REVIEWED: FS
APPROVED: FS
SCALE: N.T.S.

TYPICAL HANDRAIL

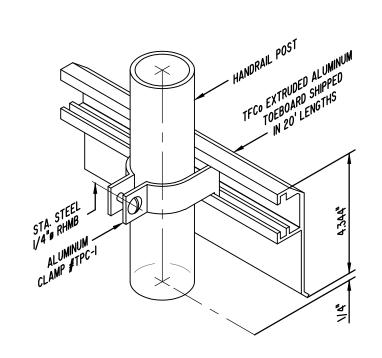

TOEBOARD DETAILS

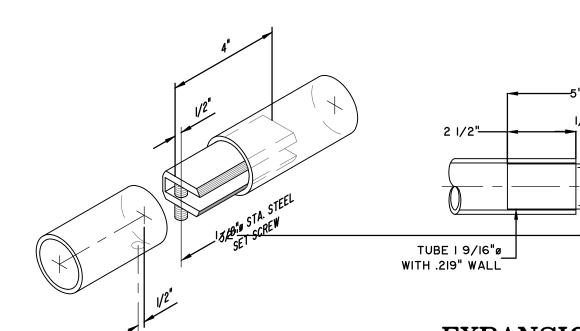

SPLICE LOCK #SL-1

EXPANSION JOINT SPICE #ES-1 (LOCATED AT 60'-0" MAXIMUM INTERVALS)

7/16"ø HOLE IN UNDERSIDE OF RAIL FOR 3/8"ø x 1-3/4" S.S. SET SCREW


OSHA DESIGN SPECIFICATIONS


- HANDRAIL SHALL BE THE PRODUCT OF A COMPANY NORMALLY ENGAGED IN THE MANUFACTURE OF PIPE RAILING. RAILING SHALL BE SHOP ASSEMBLED IN LENGTHS NOT TO EXCEED 24 FEET FOR FIELD ERECTION.
- 2. HANDRAILS SHALL BE DESIGNED TO WITHSTAND 200# CONCENTRATED LOAD APPLIED IN ANY DIRECTION TO THE
- 3. THE MANUFACTURER SHALL SUBMIT CALCULATIONS TO THE ENGINEER FOR APPROVAL. TESTING OF BASE CASTINGS OR BASE EXTRUSIONS BY AN INDEPENDENT LAB OR MANUFACTURER'S LAB (IF MANUFACTURER'S LAB MEETS THE REQUIREMENTS OF THE ALUMINUM ASSOCIATION) WILL BE AN ACCEPTABLE SUBSTITUTE FOR CALCULATIONS. CALCULATIONS WILL BE REQUIRED FOR APPROVAL OF ALL OTHER DESIGN ASPECTS.
- 4. POST SPACING SHALL BE A MAXIMUM OF 6'-O". POSTS AND RAILINGS SHALL BE A MINIMUM OF I-I/2" SCHEDULE 40 ALUMINUM PIPE ALLOY 6105-T5, ASTM-B-429 OR ASTM-B-221. THE HANDRAIL MANUFACTURER SHALL SHOW THAT THEIR POSTS ARE OF ADEQUATE STRENGTH TO MEET THE LOADING REQUIREMENTS. IF THE MANUFACTURER'S POSTS ARE NOT OF ADEQUATE STRENGTH, THE MANUFACTURER MAY REDUCE THE POST
- SPACING OR ADD REINFORCING DOWELS OR MAY DO BOTH IN ORDER TO MEET THE LOADING REQUIREMENTS. THE HANDRAIL SHALL BE MADE OF PIPES JOINED TOGETHER WITH COMPONENT FITTINGS. SAMPLES OF ALL COMPONENTS, BASES, TOE PLATE AND PIPE MUST BE SUBMITTED FOR APPROVAL. COMPONENTS THAT ARE POP-RIVETED OR GLUED AT THE JOINTS WILL NOT BE ACCEPTABLE. ALL COMPONENTS MUST BE MECHANICALLY FASTENED WITH STAINLESS STEEL HARDWARE. HANDRAIL AND COMPONENTS SHALL BE TUF RAIL, AS MANUFACTURED BY THOMPSON FABRICATING COMPANY (BIRMINGHAM, ALABAMA) OR AN APPROVED EQUAL.
- 6. POSTS SHALL NOT INTERRUPT THE CONTINUATION OF THE TOP RAIL AT ANY POINT ALONG THE RAILING, INCLUDING CORNERS AND END TERMINATIONS (OSHA 1910.23). THE TOP SURFACE OF THE TOP RAILING SHALL BE SMOOTH AND SHALL NOT BE INTERRUPTED BY PROJECTED FITTINGS.
- 7. THE MIDRAIL AT A CORNER RETURN SHALL BE ABLE TO WITHSTAND A 200# LOAD WITHOUT LOOSENING. THE MANUFACTURER IS TO DETERMINE THIS DIMENSION FOR THEIR SYSTEM. PROVIDE PHYSICAL TESTS FROM A
- LABORATORY TO CONFIRM COMPLIANCE. 8. EXPANSION BOLTS SHALL BE SPACED IOD APART AND 5D EDGE DISTANCE FOR NO REDUCTION IN PULLOUT STRENGTH. A SAFETY FACTOR OF 4 SHALL BE USED ON EXPANSION BOLT PULLOUT VALUES PUBLISHED BY THE MANUFACTURER. EXPANSION BOLTS SHALL BE STAINLESS STEEL TYPE 18-8 WEDGE BOLTS AND SHALL BE FURNISHED BY THE HANDRAIL MANUFACTURER.
- 9. TOE PLATE SHALL CONFORM TO OSHA STANDARDS. TOE PLATE SHALL BE A MINIMUM OF 4" HIGH AND SHALL BE AN EXTRUSION THAT ATTACHES TO THE POSTS WITH CLAMPS WHICH WILL ALLOW FOR EXPANSION AND CONTRACTION BETWEEN POSTS. TOE PLATES SHALL BE SET I/4" ABOVE THE WALKING SURFACE. TOE PLATES SHALL BE PROVIDED ON HANDRAILS AS REQUIRED BY OSHA AND/OR AS SHOWN ON DRAWINGS. TOE PLATES
- SHALL BE SHIPPED LOOSE IN STOCK LENGTHS WITH PRE-MANUFACTURED CORNERS FOR FIELD INSTALLATION. IO. OPENINGS IN THE RAILING SHALL BE GUARDED BY A SELF-CLOSING GATE (OSHA 1910.23). SAFETY CHAINS SHALL
- NOT BE USED UNLESS SPECIFICALLY SHOWN ON THE DRAWINGS. II. FINISH SHALL BE ALUMINUM ASSOCIATION MIO-C22-A4I (215-RI). THE PIPE SHALL BE PLASTIC-WRAPPED. THE PLASTIC WRAP IS TO BE REMOVED AFTER ERECTION.
- 12. ALUMINUM SURFACES IN CONTACT WITH CONCRETE, GROUT OR DISSIMILAR METALS WILL BE PROTECTED WITH A COAT OF BITUMINOUS PAINT, MYLAR ISOLATORS OR OTHER APPROVED MATERIAL.

BRUNSWICK-GLYNN JOINT WA AND SEWER COMMISSION MAINL

DRAWN: CDR DESIGNED: CDR REVIEWED: FS APPROVED: FS

2-LINE COMPONENT HANDRAIL IN COMPLIANCE WITH OSHA SCALE: NOT TO SCALE

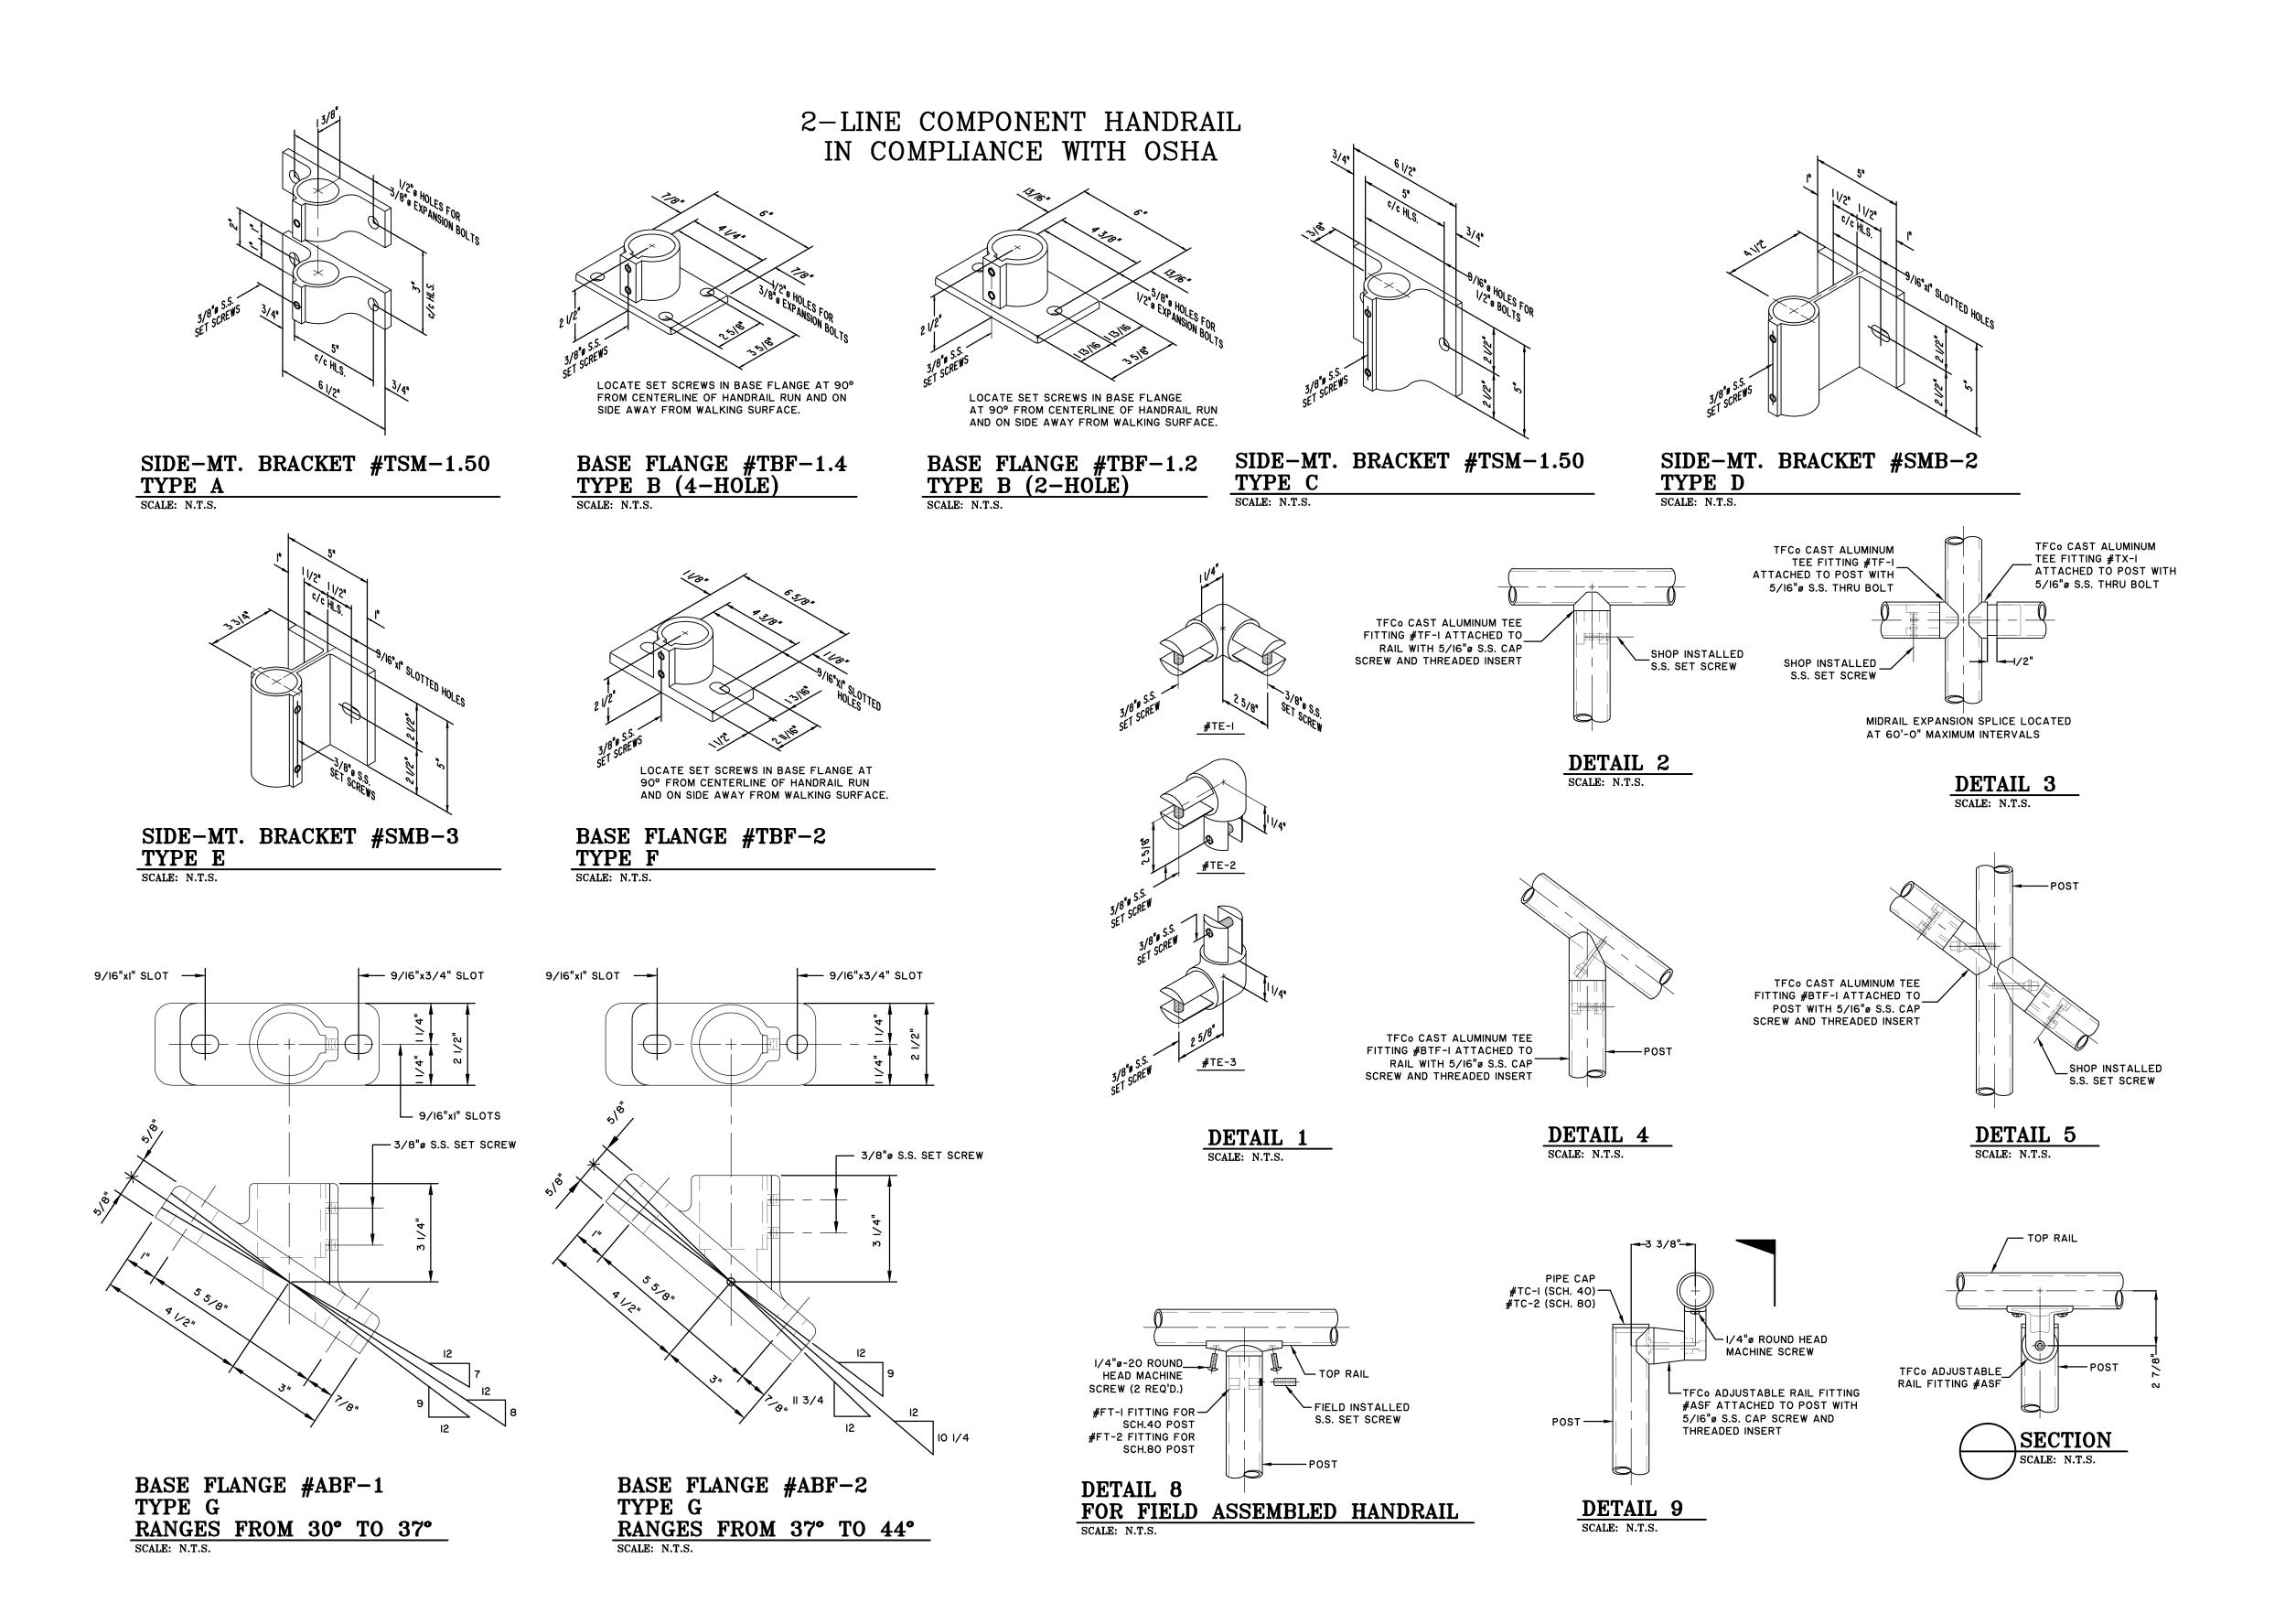

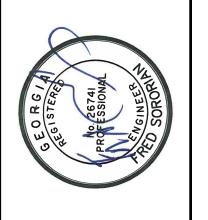

REVISIONS BY DATE

THOMAS FORK of Commerce Way

TION IMPROVEMENTS

BRUNSWICK-GLYNN JOINT WATER
AND SEWER COMMISSION
BRUNSWICK, GA

AND 3E WEE

JOB NO: J-27784.0000
DATE: 8/22/19
DRAWN: CDR
DESIGNED: CDR
REVIEWED: FS
APPROVED: FS

C2.11

LEGEND:

HOME RUN

EQUIPMENT AS NOTED

CIRCUIT BREAKER

20A DUPLEX RECEPTACLE, NEMA 5-20R, TYPE WR
WP WEATHERPROOF

GROUND TO GROUND ROD SYSTEM

GF GROUND FAULT CIRCUIT INTERRUPTER PROTECTION

GF GROUND FAULT CIRCUIT INTERRUPTER PROTEC

AIC INTERRUPTING CAPACITY IN AMPS

CONDUIT SYSTEM CONCEALED BELOW GRADE

----- EXPOSED CONDUIT

10) PUMP MOTOR. HORSEPOWER INDICATED

N.T.S. NOT TO SCALE

SP SURGE PROTECTION DEVICE

DRIVEN GROUND ROD LOCATION

SERVICE POLE WITH DOWN GUY

S SWITCH, 48" UP

S3 THREE WAY SWITCH, 48" AFF

S 3P 20A 120/277V 3-WAY TOGGLE SWITCH WITH PILOT LIGHT, 48" AFF

NEMA 4X STAINLESS STEEL DISCONNECT SWITCH MOUNTED ON EQUIPMENT FRAME. RATINGS AS NOTED ON ONE-LINE

ALARM HORN, MOUNT 12' AFF ON BUILDING - NOTE G6

H RED ALARM LIGHT, MOUNT 12' AFF ON BUILDING - NOTE G7

MULTI-COLOR ALARM LIGHT ON BUILDING - NOTE G6.

MOLIT-COLOR ALARM LIGHT ON BUILDING - NOTE G

PHOTO CELL: TORK MODEL 2107: 120/277V, 2000W/1800W/600W TUNGSTON/BALLAST/LED RATED


WALL MOUNTED LED EMERGENCY BATTERY PACK

EXP EXPLOSION PROOF: CLASS 1, DIV. 1

GENERATOR RECEPTACLE - SEE 3/E0.1

GENERAL NOTES (APPLICABLE TO ALL DRAWINGS)

- G1. FIELD COORDINATE THE ELECTRICAL SERVICE WITH LEAH HALL, GEORGIA POWER ACCOUNT MANAGER, 912-267-5155.
- G2. INSTALL GROUNDING DELTA IN THIS AREA. REFER TO SECONDARY GROUNDING DETAIL, SHEET E0.1, FOR INSTALLATION REQUIREMENTS
- G3. PROVIDE A TRANS-SOCKET. METER SYSTEM. EQUIPMENT SHALL COMPLY WITH THE REQUIREMENTS OF THE GEORGIA POWER BLUE BOOK.
- G4. ALL CONDUIT TERMINATIONS TO ELECTRICAL ENCLOSURES SHALL UTILIZE THREADED HUBS; LOCK NUTS AND BUSHINGS ARE NOT ACCEPTABLE. SEE SPECIFICATIONS FOR CONDUIT REQUIREMENTS.
- G5. EXTEND UNSWITCHED AND ENERGIZED CONDUCTOR TO ALL EXIT SIGNS AND EMERGENCY BATTERY PACKS.
- G6. PROVIDE MULTI-COLOR ALARM LIGHT AND RED LIGHT ON OUTSIDE OF EACH STATION. REFER TO SCADA SPEC ON SHEET E3.1. PROVIDE PLASTIC ENGRAVED SIGN WITH 11/2" LETTERING ADJACENT TO FRONT DOOR IDENTIFYING LIGHT STATUS.
- G7. IF EITHER ALARM OCCURS, HORN TO SOUND UNTIL SILENCE SWITCH IS PUSHED.
- G8. ANY CONDUIT WITHOUT DESIGNATION CONTAINS 3 #10, #12 GND IN 1" CONDUIT, CONDUITS IMBEDDED IN STRUCTURAL CONCRETE (FLOOR SLABS, ETC) SHALL BE SO LOCATED AS NOT TO UNDULY IMPAIR THE STRENGTH OF THE CONSTRUCTION AND SHALL BE SPACED NOT LESS THAN TWO TIMES THE CONDUIT OD BETWEEN ADJACENT CONDUITS EXCEPT WHERE CROSSING OR OTHERWISE APPROVED BY THE ENGINEER. WIRING FOR LIGHTING, RECEPTACLES AND OTHER MISCELLANEOUS CIRCUITS SHALL CONFORM TO THE CIRCUITING INDICATED ON THE DRAWINGS WITH FIELD ARRANGMENT AND ROUTING AS REQUIRED. THE WIRING SHALL BE SO ARRANGED THAT NO MORE THAN 3 CURRENT CONDUCTORS SHALL BE INSTALLED PER CONDUIT AND CIRCUITS OF DIFFERENT PANELS SHALL BE INSTALLED IN SEPARATE RACEWAYS.
- G9. CONNECT TO AIR FLOW SWITCH PROVIDED BY MECHANICAL EXTEND CIRCUIT TO SCADA PANEL.

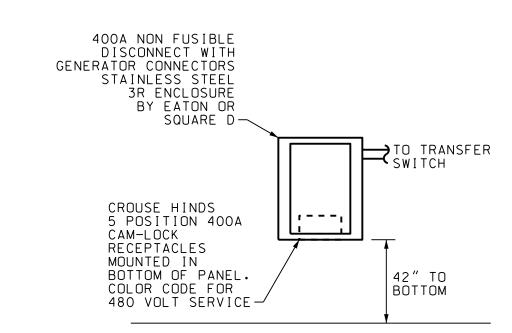


3 GENERATOR RECEPTACLE DETAIL

E0.1 NOT TO SCALE

DEMOLITION NOTES

- D1. THE EXISTING MCC, TRANSFER SWITCH, LIGHTING SYSTEM, RECEPTACLES, VFDS, AND OTHER ELECTRICAL EQUIPMENT INCLUDING ALL CONDUITS AND CONDUCTORS SHALL BE DEMOLISHED AND REMOVED FROM THE PROJECT SITE AS PART OF THIS CONTRACT. THE CONTRACTOR SHALL DISPOSE OF THEMATERIAL OFF-SITE AS PART OF THE CONTRACT. COORDINATE WITH OWNER FOR ANY MATERIALS TO BE RETAINED BY THE OWNER.
- D2. THE CONTRACTOR SHALL COORDINATE WITH GEORGIA POWER FOR MODIFICATIONS AND/OR REMOVAL OF THE EXISTING SERVICES TO THE EXISTING PUMP STATION BUILDINGS.

*	10'-0", TYPICAL		EXOTHERMIC WELD 4/0 BARE COPPER CABLE TO 3/4" DIA X10'-0" COPPER-WELD GROUND RODS AT 24" BELOW GRADE (TYPICAL 3 LOCATIONS)
10.0°			1#4/O BARE STRANDED COPPER CONDUCTOR BOND TO GROUND RODS
**			1#4/0 BARE STRANDED COPPER CONDUCTOR TO UNIT SUBSTATION
	\\ \\ \\ \\ \\ \\ \\ \\ \\ \\ \\ \\ \\	ELECTRICAL ROMASONRY WALL	DOM
1 SECONDA E0.1 NOT TO SCALE	ARY ELECTI	RICAL GE	ROUNDING

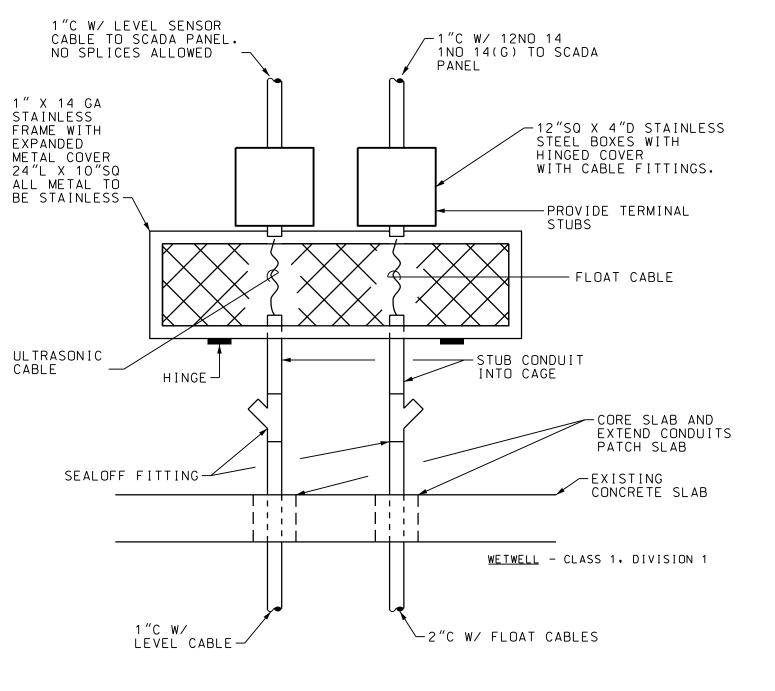

JUNCTION BOX DETAIL

NOT TO SCALE

	LIGHTING FIXTURE S	CHEDULE - LF	-/	
TYPE	DESCRIPTION	LAMP	MOUNTING	NOTES
А	LED ENCLOSED/GASKETED INDUSTRIAL	LED INCLUDED	PENDANT	LF-2
	LITHONIA FEM-L48-6000-LM-LPPCL-MD-MVOLT-GZ10-			
	40K-80CRI-DPMB-STSL			
В	LED ENCLOSED/GASKETED INDUSTRIAL WALL MTD	LED INCLUDED	WALL	10' AFF
	LITHONIA FEM-L48-6000-LM-LPPCL-MD-MVOLT-GZ10-			
	40K-80CRI-DPMB-STSL			
С	LED EXTERIOR WALL SCONCE	LED INCLUDED	WALL	12' AFF
	LITHONIA WSTLED-P3-40K-VW-MVOLT-E20WH-DDBXD			
	WITH WSTVCPBBW DDBXD U SURFACE MTD BACKBOX			
D	LED HAZARDOUS LOCATION CEILING FIXTURE	LED INCLUDED	SURFACE	LF-3
	APPLETON AAL-C-L2-2-C-BU-AAP-75			
ΧA	LED EXIT SIGN	LED INCLUDED	WALL	8' AFF
	LITHONIA LHQM-LED-R-SD			
ELU	LED EMERGENCY LIGHT	LED INCLUDED	WALL	8' AFF
	ELM2-LED-SD			

NOTES - LIGHTING FIXTURE SCHEDULE

- LF-1. FIXTURES SHOWN INDICATE QUALITY OF FIXTURES DESIRED. OTHER MANUFACTURERS OF EQUAL FIXTURES ARE ACCEPTABLE UPON REVIEW AND APPROVAL OF THE ENGINEER. PRIOR APPROVAL NOT REQUIRED.
- LF-2. MOUNT FIXTURE WITH BOTTOM OF LENS AT SAME ELEVATION AS BOTTOM OF CONCRETE STRUCTURE.
- LF-3. PROVIDE CLASS 1. DIV 1 RATED FIXTURE.

No. 11726
PROFESSIONAL
MAMALA

50 Park of Commerce Way vannah, GA 31405 • 912.234.5300

0

Savannah,

BRUNSWICK, GA

H MAINLAND PHASE II & I

BRUNSWICK, G.

3 JWSC NORTH MAINLA

JOB NO: J-27784.0000

DATE: 01/07/2020

DRAWN: A.L.


DESIGNED: A.L.

REVIEWED: P.M.

APPROVED: P.M.


SCALE: NO SCALE

E0.1

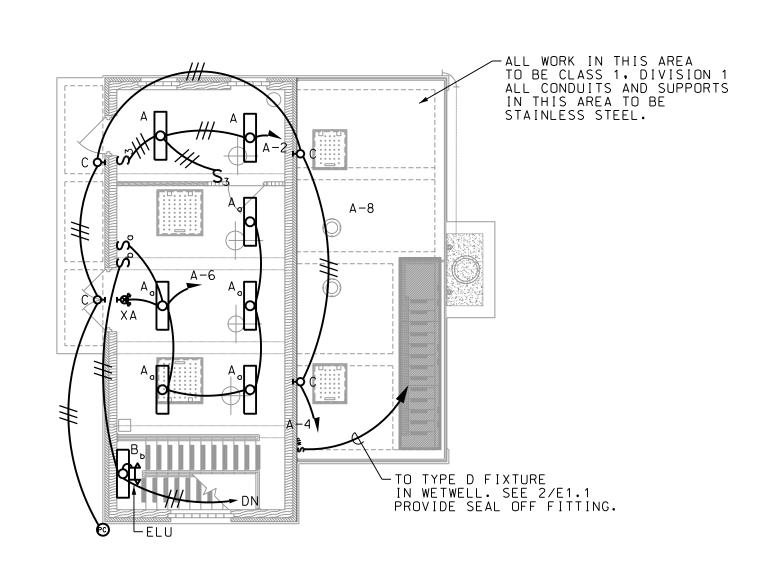


1 LIGHTING ENTRANCE LEVEL FLOOR PLAN

E1.1 SCALE: 1/8" = 1'-0"

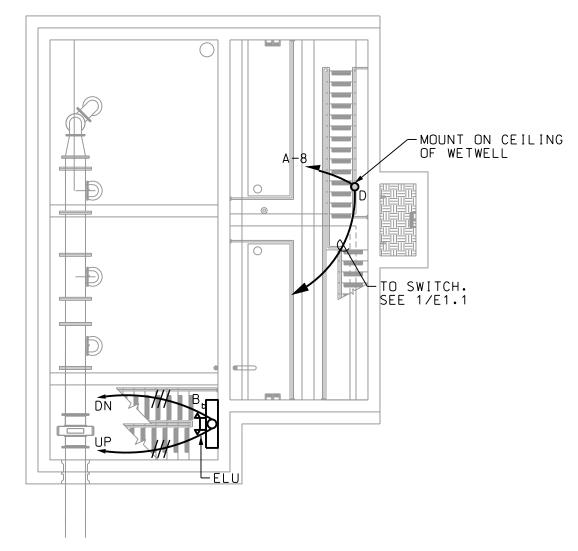

2 LIGHTING INTERMEDIATE LEVEL FLOOR PLAN

SCALE: 1/8" = 1'-0"

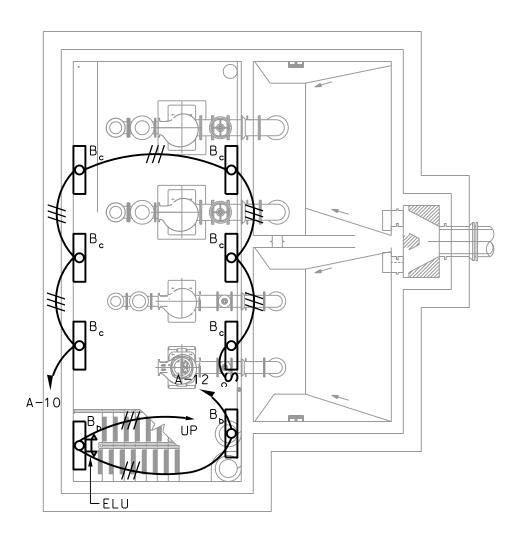

3 LIGHTING BOTTOM LEVEL FLOOR PLAN

E1.1 SCALE: 1/8" = 1'-0"

600A AUTOMATIC TRANSFER SWITCH— -- LOCATE GROUND RODS IN GRASS AREA 600A MAIN SWITCH -GENERATOR RECEPTACLE GA POWER TRANS-SOCKET 60/2/4X-A-26 (40/2) -1"C W/ 2 NO.8, _1 NO.10(G) U/G CONDUIT TO GA
POWER POLE APPROXIMATELY—
100 FT AWAY. VERIFY
EXACT LOCATION IN FIELD— — EF −1 A ¦ 1/2 HP, 1PH, 120V EXHAUST FAN ON ROOF NOTE 1, 69 23A,1PH,208V 600A PANEL HPA PANEL A-SCADA PANEL -PUMP #1 VF.D TERMINATE LEVEL SENSOR

X AND FLOAT CABLES HERE


X AND EXTEND CIRCUITS TO

X SCADA PANEL.

X SEE 2/E0.1 PUMP #2/VFD JOCKEY PUMP #1+ JOCKEY PUMP #2 NOTE 3 A-11 SUSPENDED* 25KVA * TRANSFORMER | * * * * * * NOTE 5 -PUMŘ ĎIŠČŎNNECT SWITCHES AND CONTROL BOXES. SEE 3/E2.1 SF-1A 1/4 HP, 1PH, 120V SUPPLY FAN NOTE 1 -EF-2A 1/4 HP, 1PH, 12OV | EXHAUST FAN | ON ROOF - NOTE 1, G9 EXTERIOR SILENCE SWITCH, 48" UP. -REFER TO SCADA SPECS FOR ALARMS FLOWMETER TOTALIZER--- UH-1A 7.5KW, 3PH, 460V -- UNIT HEATER TO FLOWMETER
SEE 5/E1.1-

NOTES:

- 1. EXTEND CIRCUIT THROUGH MOTOR SWITCHES WITH OL PROTECTION LOCATED ADJACENT TO PANEL A. LABEL EACH SWITCH.
- 2. MOUNT SWITCHES ON INTERMEDIATE STAIR LANDING. LABEL EACH SWITCH. SUPPORT SUMP PUMP CABLE AND PROVIDE CABLE FITTING. CONNECT TO ALL CONTROLS AS REQUIRED.
- 3. AHU IS FED FROM OUTDOOR HP UNIT.
- 4. PROVIDE SOLAR PANEL FOR SCADA BATTERY CHARGER AS SPECIFIED.
- 5. MOUNT TOP OF TRANSFORMER WITH 12" TO ROOF DECK. MOUNT SECONDARY BREAKER ON WALL BELOW, 48" UP.

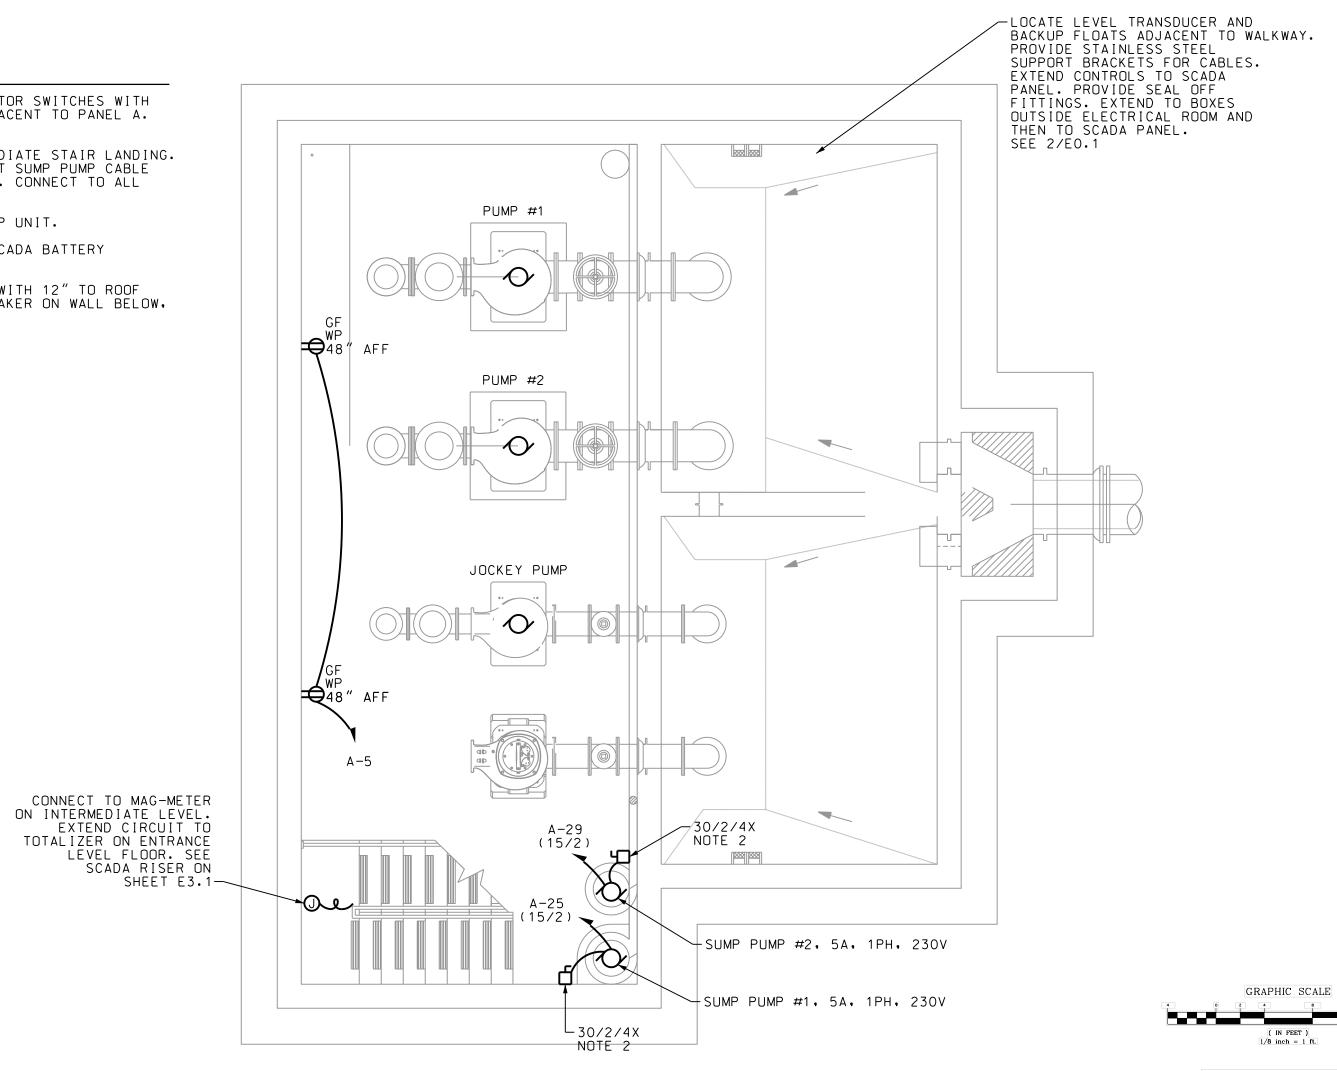

POWER ENTRANCE LEVEL FLOOR PLAN

SCALE: 1/4"=1'-0"

5 POWER BOTTOM LEVEL FLOOR PLAN

E1.1 SCALE: 1/4" = 1'-0"

GRAPHIC SCALE

O 2 4 8

(IN FEET)

1/4 inch = 1 ft.

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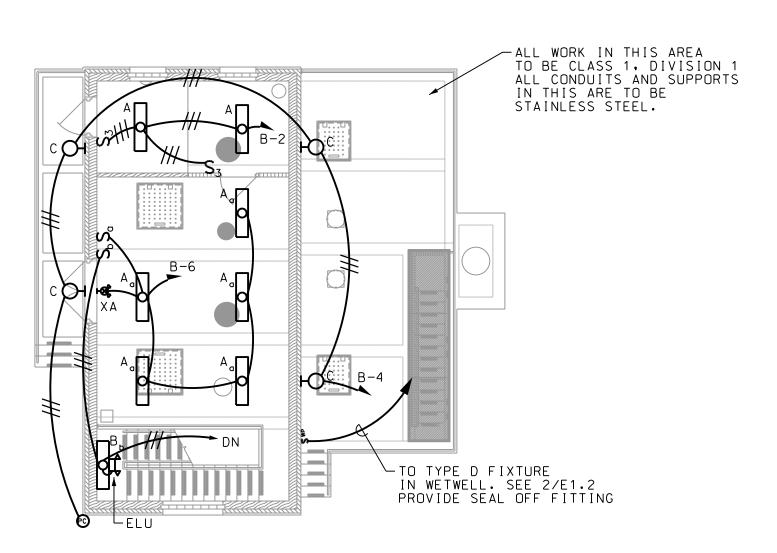
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STAND TO SERVICE TO SE

SEWER COMINISSION
BRUNSWICK, GA
NORTH MAINLAND PHAS


BRUNSWICK GLYN SEWER BRU BGJWSC NORTH M

JOB NO: J-27784.0000
DATE: OI/O7/2020
DRAWN: A.L.
DESIGNED: A.L.
REVIEWED: P.M.
APPROVED: P.M.
SCALE: AS NOTED




LIGHTING ENTRANCE FLOOR PLAN

SCALE: 1/8"=1'-0"

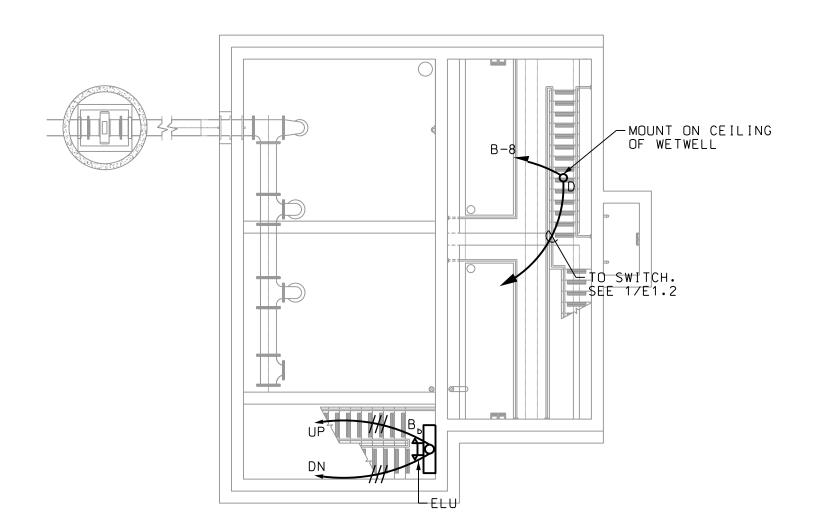


LIGHTING INTERMEDIATE FLOOR PLAN SCALE: 1/8"=1'-0"

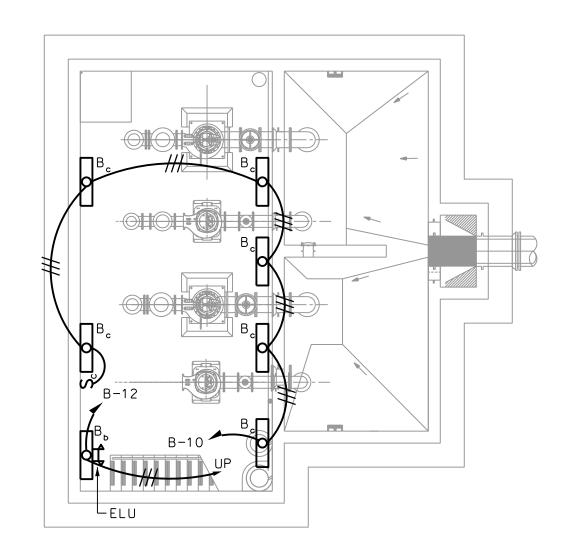


LIGHTING BOTTOM FLOOR PLAN

SCALE: 1/8"=1'-0"

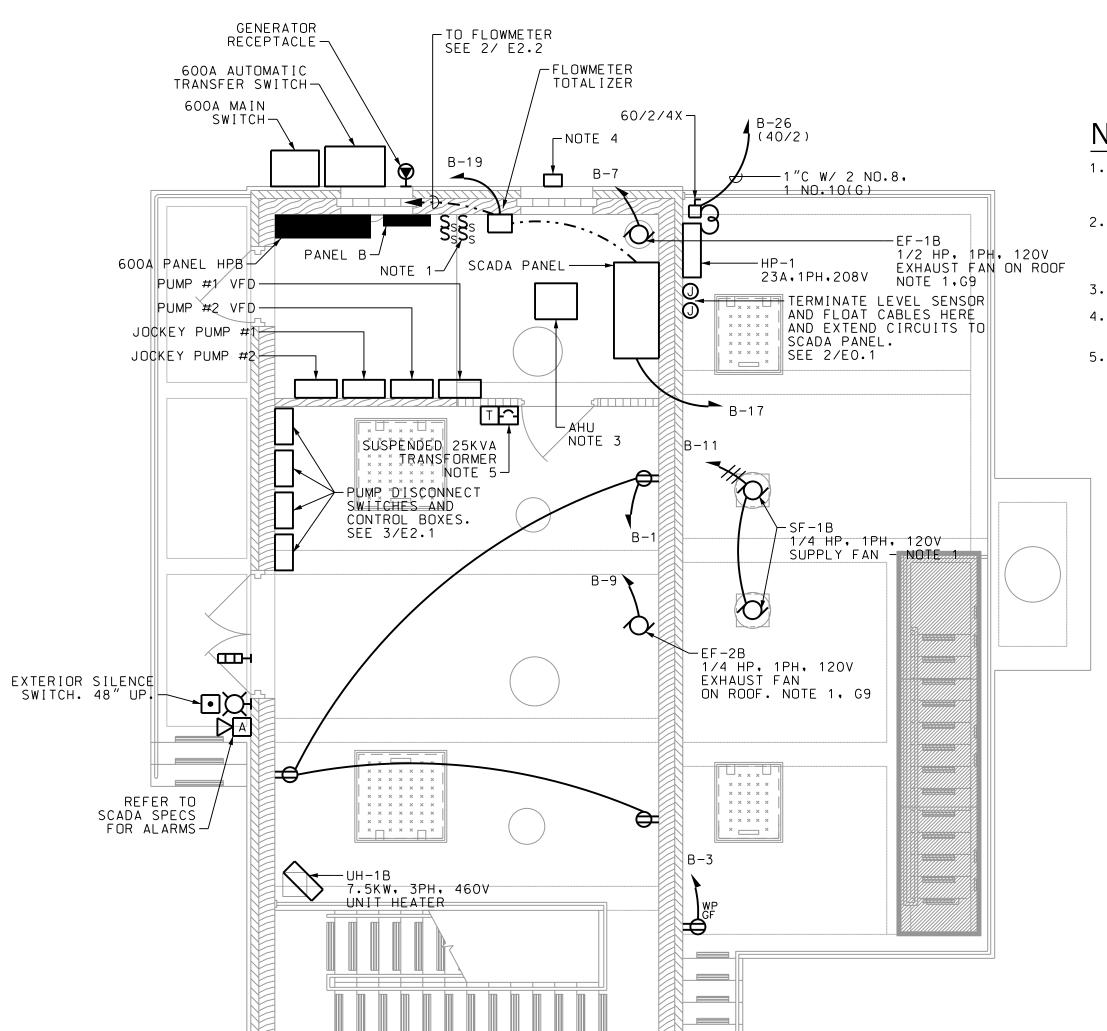

NOTES:

- 1. EXTEND CIRCUIT THROUGH MOTOR SWITCHES WITH OL PROTECTION LOCATED ADJACENT TO PANEL A. LABEL EACH SWITCH.
- 2. MOUNT SWITCHES ON INTERMEDIATE STAIR LANDING. LABEL EACH SWITCH. SUPPORT SUMP PUMP CABLE AND PROVIDE CABLE FITTING. CONNECT TO ALL CONTROLS AS REQUIRED.
- 3. AHU IS FED FROM OUTDOOR HP UNIT.
- PROVIDE SOLAR PANEL FOR SCADA BATTERY CHARGER AS SPECIFIED.
- 5. MOUNT TOP OF TRANSFORMER WITH 12" TO ROOF DECK. MOUNT SECONDARY BREAKER ON WALL BELOW, 48" UP.

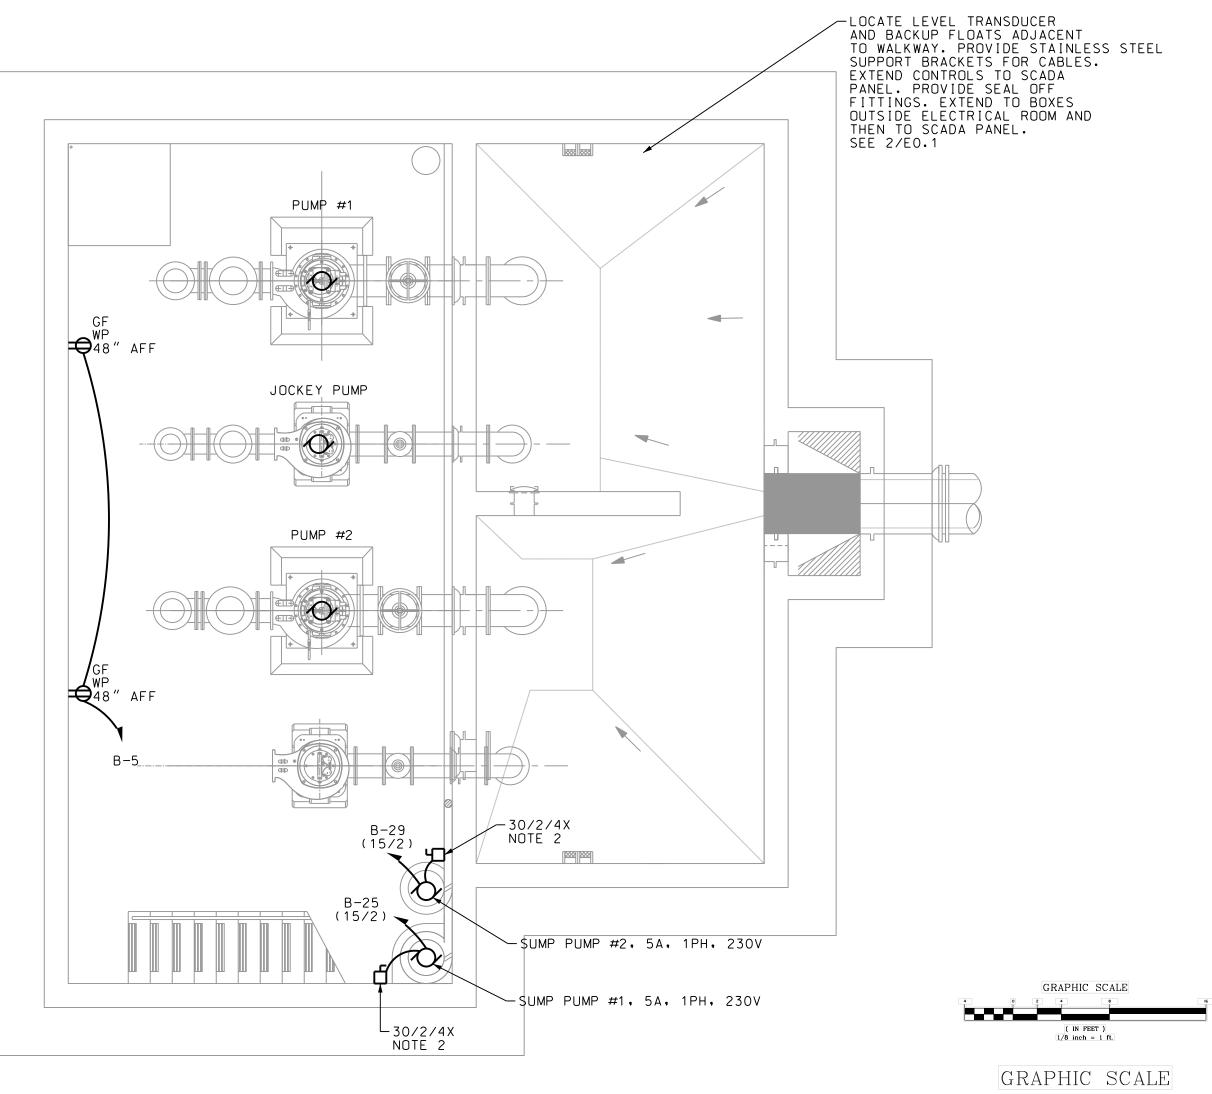

POWER ENTRANCE FLOOR PLAN

SCALE: 1/4"=1'-0"

POWER BOTTOM FLOOR PLAN

(IN FEET) 1/4 inch = 1 ft.


E1.2 SCALE: 1/4 = 1'-0

E:\BGCJWSC LS 4035-4036 - 19000.07\CADD\E1.2.dgn

N N N N JOB NO: J-27784.0000 DATE: 01/07/2020

DRAWN: A.L.
DESIGNED: A.L. REVIEWED: P.M. APPROVED: P.M.
SCALE: AS NOTE

E1.2

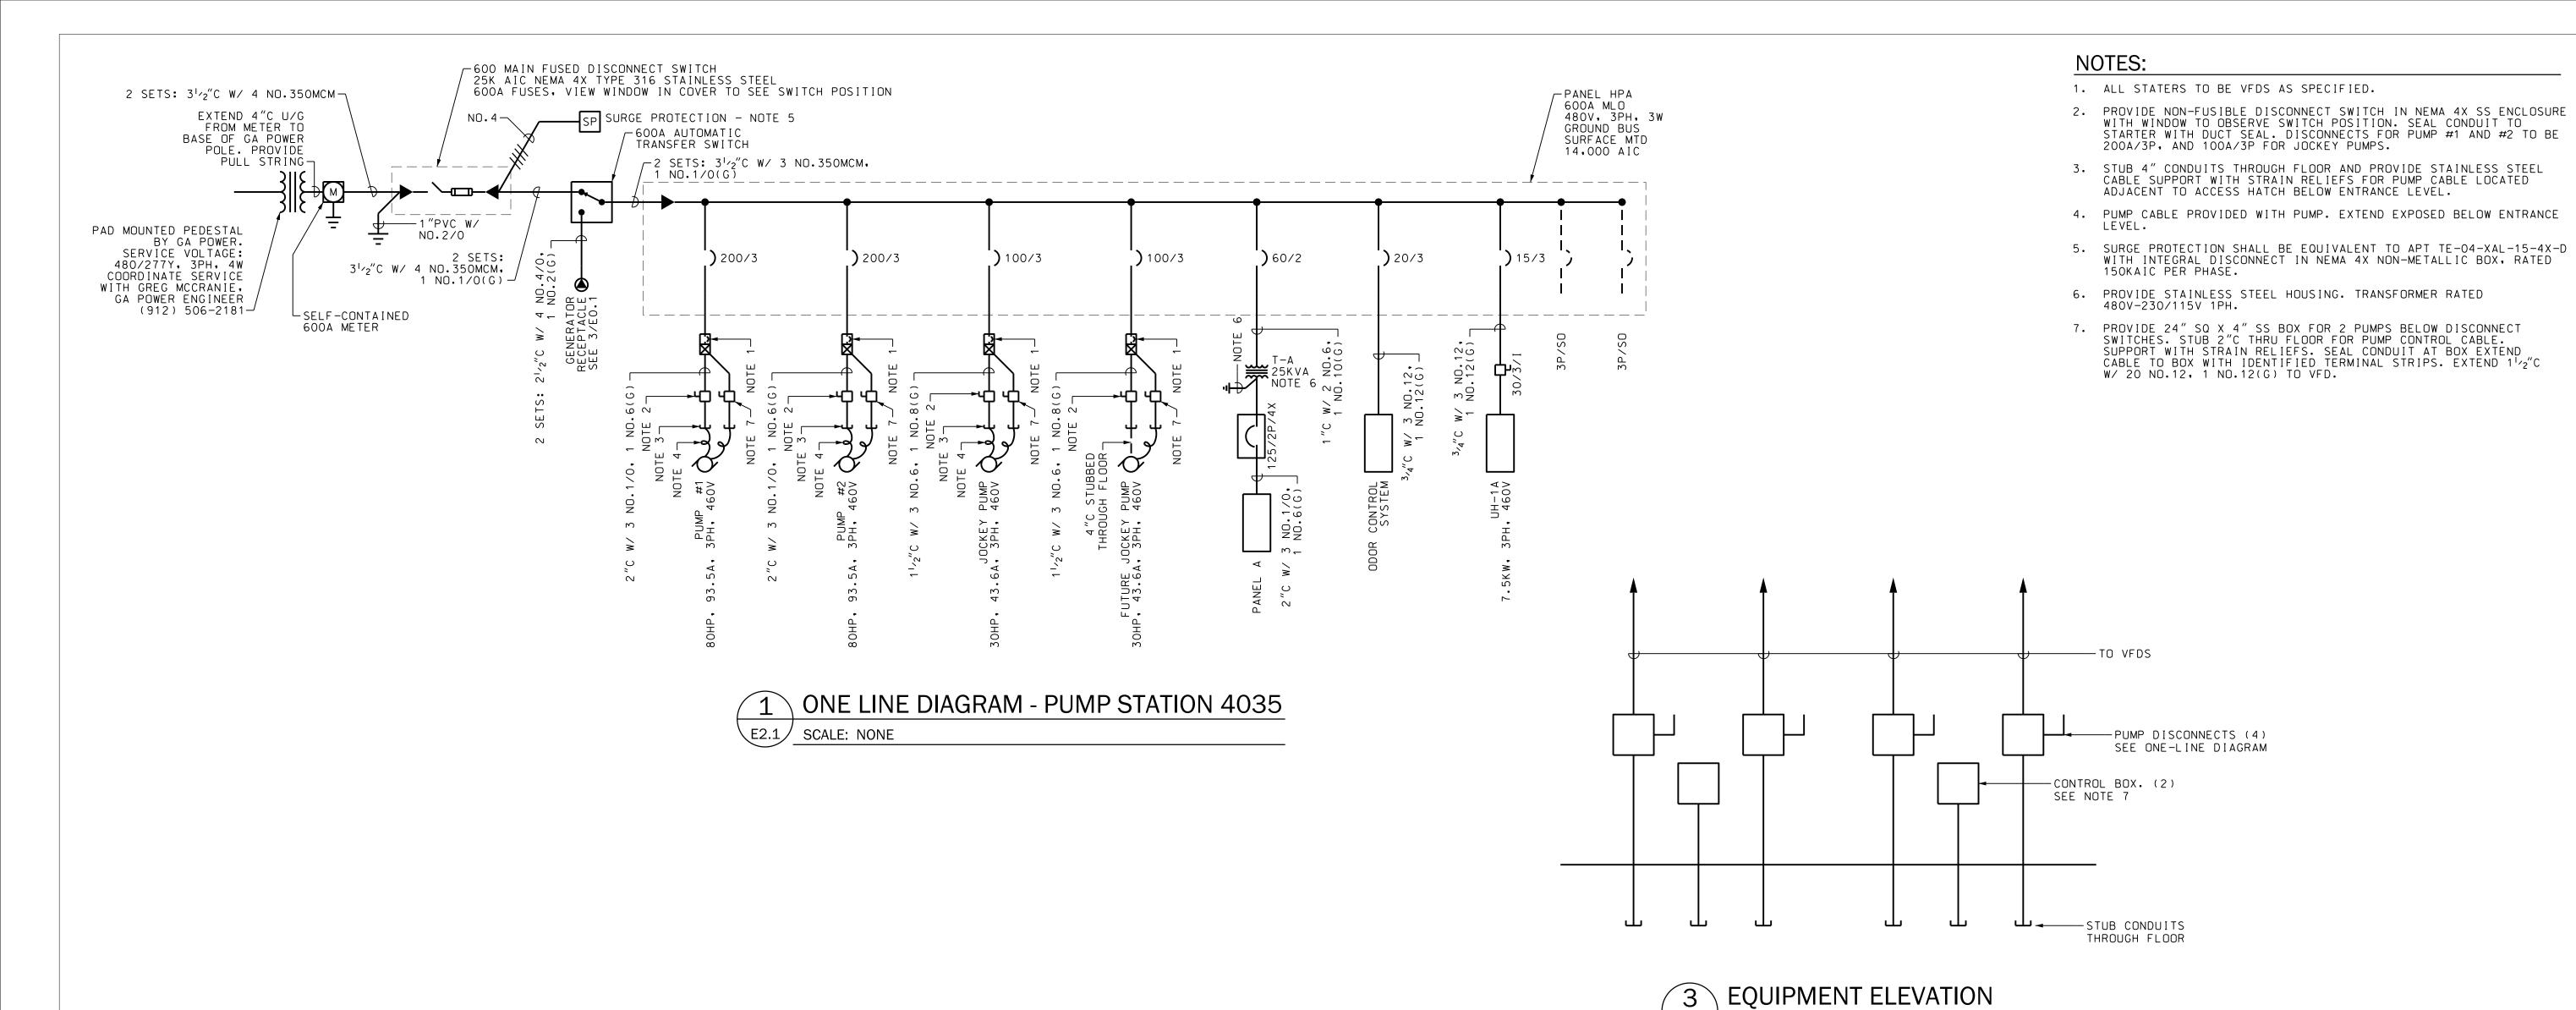

			SCH	EDULE PA	NELBOA	ARD A			
	MAINS		VOLTAGE	PHASE	WIRE	MOUNTING			
	125A	MLO	120/240	1	3	SURFACE			
CIR.	TRIP/			CONNECTED	LOAD KVA			TRIP/	CIR
#	POLE	KVA	DESCRIPTION	PH. A	PH. B	DESCRIPTION	KVA	POLE	#
1	20/1	0.60	RECEPTACLES	0.7		LIGHTING	0.10	20/1	2
3	20/1	0.20	RECEPTA CLE		0.4	LIGHTING	0.20	20/1	4
5	20/1	0.40	RECEPTACLES	0.7		LIGHTING	0.25	20/1	6
7	20/1	1.20	EF-1A		1.2	LIGHTING	0.03	20/1	8
9	20/1	0.70	EF-2A	1.0		LIGHTING	0.25	20/1	10
11	20/1	1.40	SF-1A		1.7	LIGHTING	0.30	20/1	12
13	20/1		SPARE	0.0		SPARE		20/1	14
15	20/1		SPARE		0.0	SPARE		20/1	16
17	20/1	0.50	SCADA PANEL	0.5		SPARE		20/1	18
19	20/1	0.10	MA G-METER		0.1	SPARE		20/1	20
21	20/1		SPARE	0.0		SPARE		20/1	22
23	20/1		SPARE		0.0	SPARE		20/1	24
25	15/2	0.60	SUMP PUMP 1	3.3		HP/AHU	2.70	40/2	26
27	-	0.60	SUMP PUMP 1		3.3	HP/AHU	2.70	-	28
29	15/2	0.60	SUMP PUMP 2	0.6		SPACE		/1	30
31	-	0.60	SUMP PUMP 2		0.6	SPACE		/1	32
33	/1		SPACE	0.0		SPACE		/1	34
35	/1		SPACE		0.0	SPACE		/1	36
37	/1		SPACE	0.0		SPACE		/1	38
39	/1		SPACE		0.0	SPACE		/1	40
*****		ţ			-	·		+	

0.0

6.7

6.7

SPACE

10,000 AIC

/1 42


SPACE

7.3 TOTAL CONNECTED LOAD | 14.03


7.3 TOTAL DEMAND LOAD 14.03


41 /1

MIN. BREAKER AIC:

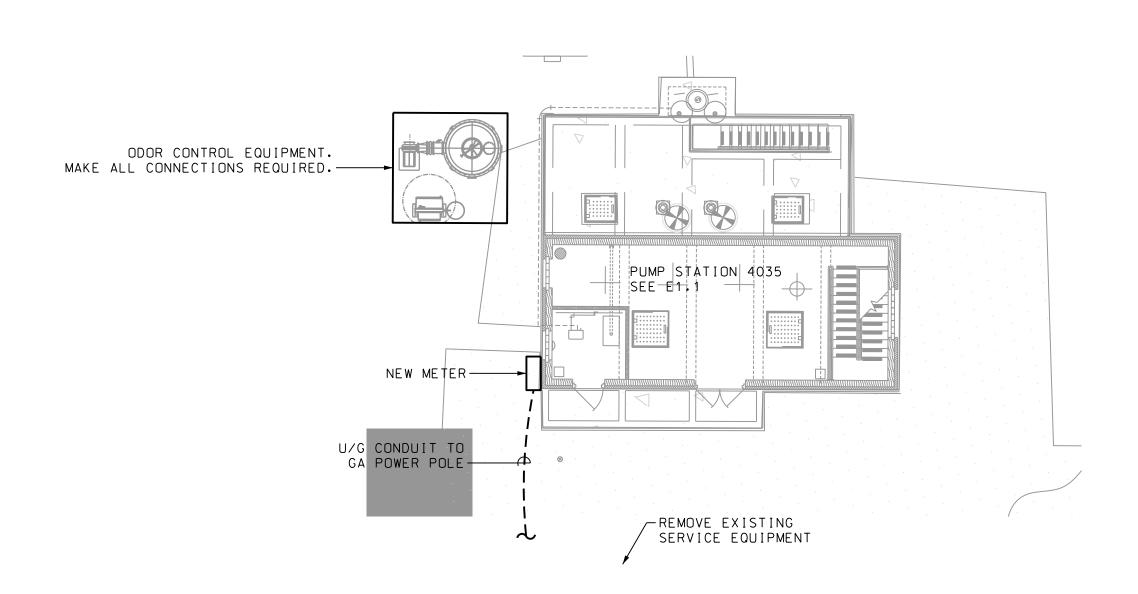

E2.1 SCALE: NOT TO SCALE

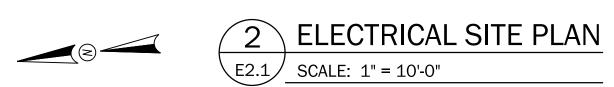


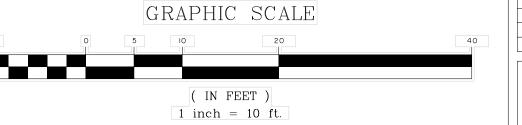

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JOB NO: J-27784.0000
DATE: OI/07/2020
DRAWN: A.L.
DESIGNED: A.L.
REVIEWED: P.M. APPROVED: P.M.
SCALE: AS NOTE

E2.1

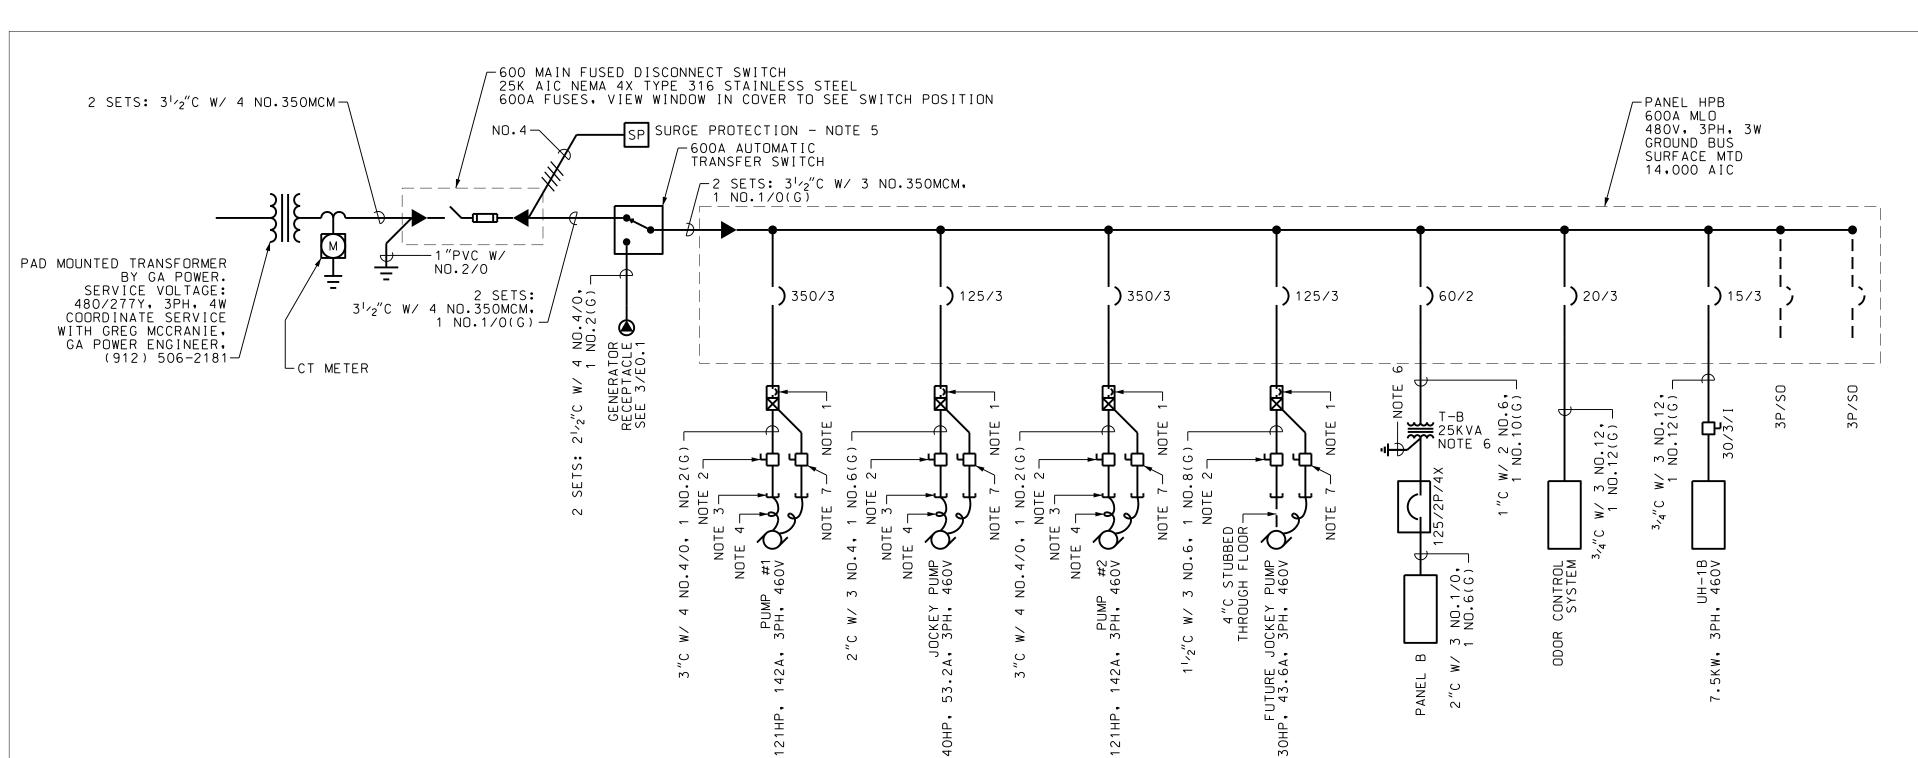

SCALE: NONE

2.70 40/2 26

/1

/1

/1

/1

/1

/1 30

/1 | 38 |

42

2.70 -

HP/AHU

HP/AHU

SPACE

SPACE

SPACE

SPACE

SPACE

SPACE

7.3 TOTAL CONNECTED LOAD | 13.98

7.3 TOTAL DEMAND LOAD 13.98

ONE LINE DIAGRAM - PUMP STATION 4036

SCHEDULE PANELBOARD B MAINS **VOLTAGE** MOUNTING 125A MB 120/240 SURFACE TRIP/ CONNECTED LOAD KVA TRIP/ CIR. # | POLE KVA DESCRIPTION PH. A PH. B **DESCRIPTION** KVA POLE 0.7 20/1 0.60 0.10 20/1 **RECEPTACLES** LIGHTING 20/1 0.20 0.4 0.20 20/1 **RECEPTACLE** LIGHTING 5 20/1 0.40 0.7 0.25 20/1 **RECEPTACLES** LIGHTING 20/1 1.20 1.2 0.03 20/1 LIGHTING 20/1 0.70 1.0 0.25 20/1 EF-2B LIGHTING 11 20/1 1.40 1.7 0.25 20/1 SF-1B LIGHTING 13 20/1 0.0 20/1 SPARE SPARE 15 20/1 0.0 20/1 SPARE 17 | 20/1 | 0.50 0.5 20/1 SCADA PANEL SPARE 19 20/1 0.10 0.1 20/1 MAG METER SPARE 20/1 0.0 20/1 SPARE SPARE 23 20/1 0.0 20/1

3.3

0.6

0.0

0.0

0.0

6.7

6.7

3.3

0.6

0.0

0.0

15/2 0.60

- 0.60

15/2 0.60

/1

39 | /1

MIN. BREAKER AIC:

0.60

27

33

35

SUMP PUMP 1

SUMP PUMP 1

SUMP PUMP 2

SUMP PUMP 2

SPACE

SPACE

SPACE

SPACE

10,000 AIC


NOTES:

1. ALL STATERS TO BE VFDS AS SPECIFIED.


- PROVIDE NON-FUSIBLE DISCONNECT SWITCH IN NEMA 4X SS ENCLOSURE WITH WINDOW TO OBSERVE SWITCH POSITION, SEAL CONDUIT TO STARTER WITH DUCT SEAL, DISCONNECTS FOR PUMP #1 AND #2 TO BE 200A/3P, AND 100A/3P FOR JOCKEY PUMPS.
- 3. STUB 4" CONDUITS THROUGH FLOOR AND PROVIDE STAINLESS STEEL CABLE SUPPORT WITH STRAIN RELIEFS FOR PUMP CABLE LOCATED ADJACENT TO ACCESS HATCH BELOW ENTRANCE LEVEL.
- 4. PUMP CABLE PROVIDED WITH PUMP. EXTEND EXPOSED BELOW ENTRANCE
- 5. SURGE PROTECTION SHALL BE EQUIVALENT TO APT TE-04-XAL-15-4X-D WITH INTEGRAL DISCONNECT IN NEMA 4X NON-METALLIC BOX, RATED 150KAIC PER PHASE.
- 6. PROVIDE STAINLESS STEEL HOUSING. TRANSFORMER RATED 480V-230/115V 1PH.


THROUGH FLOOR


7. PROVIDE 24" SQ X 4" SS BOX FOR 2 PUMPS BELOW DISCONNECT SWITCHES. STUB 2"C THRU FLOOR FOR PUMP CONTROL CABLE. SUPPORT WITH STRAIN RELIEFS. SEAL CONDUIT AT BOX EXTEND CABLE TO BOX WITH IDENTIFIED TERMINAL STRIPS. EXTEND 1 2"C W/ 20 NO.12, 1 NO.12(G) TO VFD.

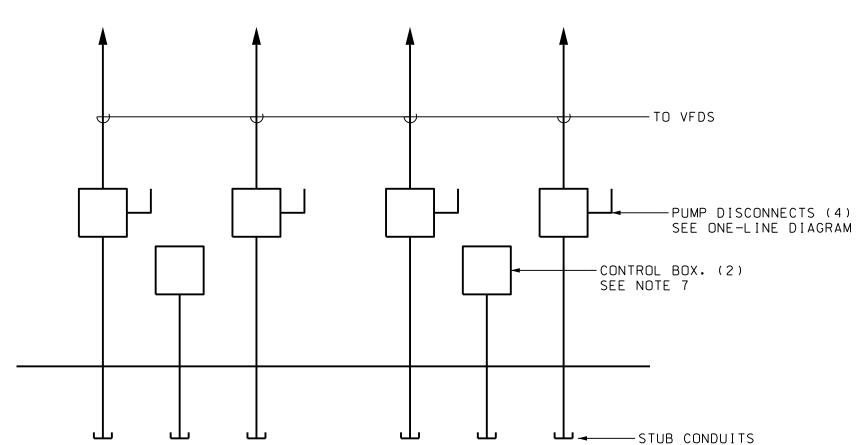

EQUIPMENT ELEVATION E2.2 / SCALE: NOT TO SCALE

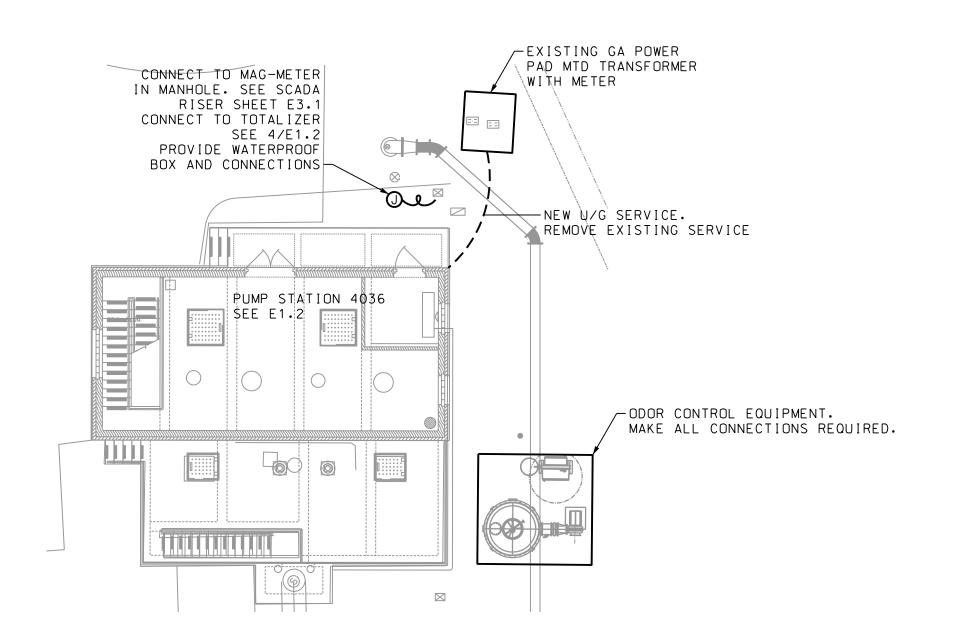

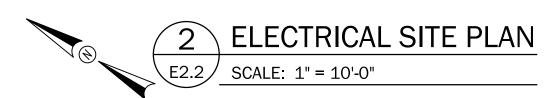

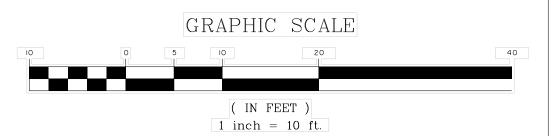

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JOB NO: J-27784.0000 DATE: 01/07/2020 DESIGNED: A.L REVIEWED: P.M. APPROVED: P.M. SCALE: NO SCALE

I. SYSTEM REQUIREMENTS

- A. PROVIDE SCADA SYSTEM THAT MEETS OWNER'S STANDARDS INCLUDING ALL HARDWARE, SOFTWARE, PROGRAMMING, INSTALLATION, TESTING, DEMONSTRATING OPERATION AND
- THE SYSTEM SHALL BE PROVIDED BY ELECTRIC MACHINE CONTROL, INC. (EMC). CONTACT JAMES DENTON (205) 661-3998, CELL (205) 910-8348. EMC SHALL ALSO PROVIDE ALL INSTRUMENTATION, AUTOMATIC TRANSFER SWITCH, AND VFDS.
- C. PROVIDE ALL FIELD WIRING IN CONDUITS AS REQUIRED. COORDINATE ALL CONNECTIONS, ALARMS AND CONTROL WITH EQUIPMENT PROVIDED UNDER OTHER SECTIONS OF THE SPECIFICATIONS. ALL CONTROL WIRING TO BE TIN COATED.

II. PRODUCTS

- A. THE SCADA PANEL SHALL BE PROVIDED IN A NEMA 4X SS ENCLOSURE, PREWIRED OFF-SITE AND TESTED BEFORE INSTALLATION, ALL CONDUCTORS SHALL BE TERMINATED ON IDENTIFIED TERMINAL STRIPS. ALL WIRING AND COMPONENTS SHALL BE IDENTIFIED AND MATCHED TO AS BUILT DRAWING. LABEL ALL FIELD WIRING TO MATCH TERMINAL STRIP.
- B. SCADA PANEL SHALL BE POWERED FROM A 120 VOLT CIRCUIT WITH INTEGRAL SURGE PROTECTION, UPS WITH SOLAR PANEL TO POWER BACKUP BATTERIES, INTEGRAL RECEPTACLE, 24 VDC POWER SUPPLY, MODEM WITH CELLULAR ALARM SYSTEM, AXIOM SEL PLC AND RTAC WITH ALL I/O REQUIRED, DATA SWITCH, SIGNAL ISOLATORS AND CONTROL RELAYS, PROVIDE CONTROL DEVICES ON COVER OF PANEL TO INCLUDE HOA SWITCH, ETM FOR EACH PUMP, HMI PANEL IDENTIFYING STATUS AND ALARMS, FLOAT MODE STATUS LIGHT AND RESET BUTTON AND SILENCE
- C. SCADA PANEL TO BE HOFFMAN 36" X 30" X 12" WITH SUBPANEL. DRAWING POCKET, INTERNAL WIRE DUCT, SQUARE D CONTROL DEVICES, FUSES, TERMINAL BLOCKS, GROUND BUS, LISTED FOR UL 508, AND ALL INTERNAL WIRING.
- D. WETWELL LEVEL SENSOR TO BE RADAR SENSOR RATED FOR CLASS I, DIV I LOCATION VEGAPULS 61 WITH SENSOR CABLE EXTENDING CONTINUOUS TO SCADA PANEL, MOUNT SENSOR ON STAINLESS STEEL BRACKET, CALIBRATE IN FIELD.
- E. FLOATS TO BE MERCURY TYPE WITH CABLES EXTENDING CONTINUOUS TO FIELD JUNCTION BOX, RATED FOR CLASS I, DIV I LOCATION, MOUNT FLOATS ON STAINLESS STEEL BRACKET. SET ELEVATION IN FIELD.
- F. REMOTE ALARM LIGHTS SHALL BE PATLITE, 24 VDC, RATED FOR EXTERIOR LOCATION, MULTI-LIGHT TOWER TO BE GREEN/RED/YELLOW AND HI-LEVEL ALARM TO BE RED, PROVIDE 24 VDC EXTERIOR RATED ALARM HORN SIMILAR TO FEDERAL SIGNAL 450E
- G. DUPLEX PUMP BACKUP CONTROLLER TO BE PRIMEX PC-240 SERIES.
- H. MODEM TO BE SEL #3061 #JBCB FOR VERIZON NETWORK.

III.SYSTEM OPERATION

- A. PUMP CONTROL SHALL BE AS FOLLOWS: THE JOCKEY PUMP SHALL RUN WHEN CALLED UPON AND WITH A CONTROL SCHEME TO MATCH INFLUENT FLOW. (FLOW MATCHING). THE PRIMARY PUMPS WILL BE CALLED UPON ONCE THE JOCKEY PUMP IS AT FULL SPEED AND THE RATE OF RISE OF THE WATER LEVEL EXCEEDS THE PUMPING CAPACITY OF THE JOCKEY. THE JOCKEY SHALL DECELERATE TO STOP PRIOR TO THE FIRST PRIMARY PUMP START UP, TO CURB ANY INSTANCE OF THE JOCKEY PUMP BEING DEAD HEADED AGAINST THE LARGER PUMP, AND TO REDUCE THE POSSIBILITY OF WATER HAMMER. THE FIRST PRIMARY PUMP WILL BE IN ALTERNATION WITH THE OTHER PRIMARY PUMP SO NOT TO ALWAYS HAVE THE SAME PRIMARY AS LEAD IN SEQUENCE. THE SECONDARY PUMP SHALL COME ON AFTER THE PRIMARY PUMP FLOW MATCHES WITH INFLUENT FLOW AND THE PUMP HAS RAMPED TO FULL SPEED BUT THE RATE OF RISE EXCEEDS THE POSSIBLE FLOW OF THE PRIMARY PUMP. THEN THE 2 PRIMARY PUMPS SHALL TRY TO FLOW MATCH UNTIL THE LEVEL HAS REACHED THE ALL OFF POINT, PROVIDE FOR ABILITY TO MODIFY CONTROLS FOR RATE AND FLOW GAIN AND TO AVOID PUMP SPEED CONSTANTLY CHANGING TO MATCH INSTANTANEOUS FLOW CHANGES, PROGRAM FOR ONE JOCKEY PUMP. WHEN SECOND JOCKEY PUMP IS ADDED, REPROGRAM, PROVIDE POINTS FOR JOCKEY PUMP NO.2.
- B. FLOAT MODE CONTROLLER TO BE PRIMEX DUPLEX CONTROLLER TO CONTROL ONLY THE 2 PRIMARY PUMPS. IF THE HIGH FLOAT HAS BECOME ACTIVE AND THE FLOAT CONTROLLER TO TAKE CONTROL OF THE STATION UNLESS OVERRIDDEN BY THE SCADA SYSTEM REMOTELY OR LOCAL HUMAN INTERACTION.
- C. PROVIDE AUDIBLE AND VISUAL ALARMS OUTSIDE STATION, MULTI LIGHT TO BE USED WITH A SEQUENCING FOR DIFFERENT ISSUES.
 MULTI LIGHT TOWER, GREEN, YELLOW, RED.
 - * MOTOR FAULT YELLOW FLASH
 - * MOTOR FAULT TELLOW FLASH

 * BIO-TOWER FAULT YELLOW AND GREEN

 * VENTILATION FAULT GREEN AND RED

 * HIGH LEVEL SEPARATE RED LIGHT STROBE WITH HORN.

 (CONTINUOUS STROBE WHILE ACTIVE ALARM AND CONSTANT ILLUMINATION ALARM ACKNOWLEDGED AND ALARM CONDITION
 - PROVIDE SILENCE SWITCH ON COVER OF SCADA PANEL. PROVIDE ENGRAVED SIGN BELOW ALARM LIGHTS IDENTIFYING ALARMS.
 - SILENCE SWITCH TO BE SQUARE D 9001 SERIES.
- D. CONNECT TO ODOR CONTROL STATION TO MONITOR POINTS AND ALARMS FOR THIS SYSTEM.
- E. CONNECT TO AUTOMATIC TRANSFER SWITCH TO MONITOR STATUS AND TO ALLOW REMOTE TRANSFER OF SWITCH TO NORMAL. INTERMEDIATE OR EMERGENCY POSITION AS LONG AS ATS CONTROLS ARE SATISIFIED, PROVIDE CONTROLS TO GO TO INTERMEDIATE POSITION AND REMAIN THERE EVEN IF NO EMERGENCY POWER EXISTS. INFORMATION FROM TRANSFER SWITCH TO INCLUDE STATUS OF POWER AVAILABLE, SWITCH POSITION, VOLTAGES, CURRENT, POWER (KW).
- F. CONNECT TO FLOWMETER AIR FLOW SWITCHES FOR MONITORING
- G. CONNECT TO LEVEL CONTROLLER AND FLOATS AS REQUIRED FOR CONTROLS SPECIFIED. PROVIDE 'FLOAT MODE' STATUS LIGHT IN SCADA PANEL COVER.
- H. CONNECT TO PUMP VFDS FOR ALL MONITOR AND CONTROL FUNCTIONS, CONNECT HOA SWITCH IN SCADA PANEL TO 'AUTO' POSITION OF VFD. CONNECT ELAPSED TIME METER TO RUN CONTACT IN VFD. CONNECT COMMON FAULT AND 'OVERTEMPERATURE' CONTACTS IN VFD TO SCADA.
- I. FOR VFDS, PROVIDE REMOTE MOUNT KIT TO PLACE DISPLAY IN COVER OF SCADA PANEL.
- J. FOR EACH VFDS, PROVIDE INTERFACE PROTECTION, MOTOR HOUSING MONITOR, SEAL LEAKAGE DETECTOR AND BEARING TEMPERATURE MONITORING.

LEGEND



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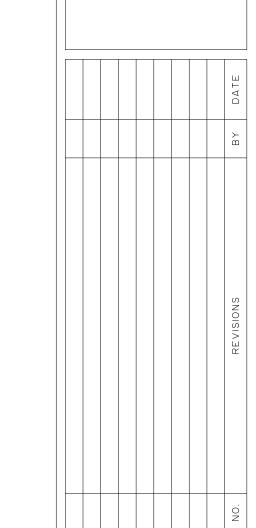
DESIGNED: PM REVIEWED: PM APPROVED: PM SCALE: NOT TO SCALE

HIGH LEVEL VISUAL ALARM-MUL T I -COLOR ALARM LIGHT EXTERIOR HORN-CELLULAR ANTENNA 120V CIRCUIT EXTERNAL __ SILENCE • SWITCH L TOTALIZER SCADA PANEL GROUND AS REQUIRED FOR BATTERY CHARGER TRANSFER ATS AIR FLOW SWITCH.

TYP OF 2 AFS FLOATS - TYP OF 6 LEVEL SENSOR

EXTERIOR





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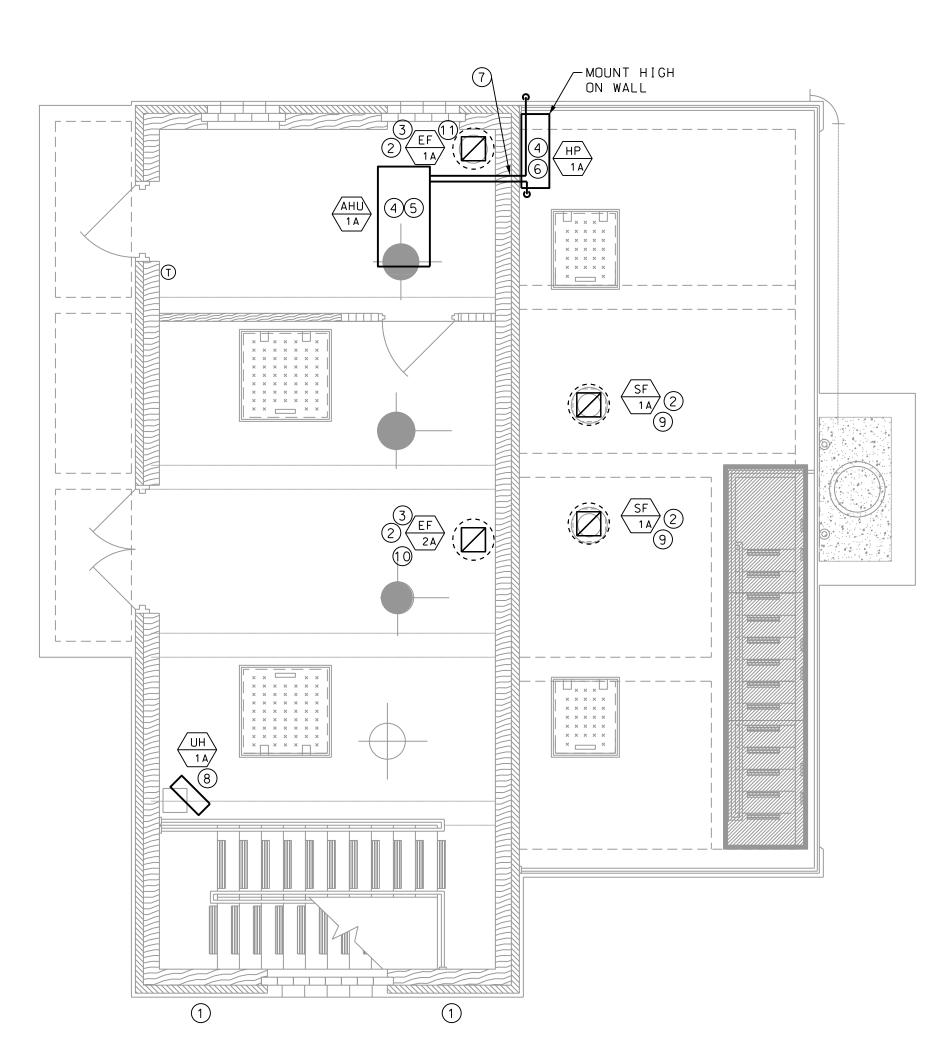
50 Park of Comr Savannah, GA 31405

> AND PHASE II & III OR PLAN - HVAC

WSC NORTH MAINLA

JOB NO: J-27784.0000
DATE: OI/O7/2020
DRAWN: SMP
DESIGNED: SMP
REVIEWED: SMP
APPROVED: SMP
SCALE: AS SHOWN

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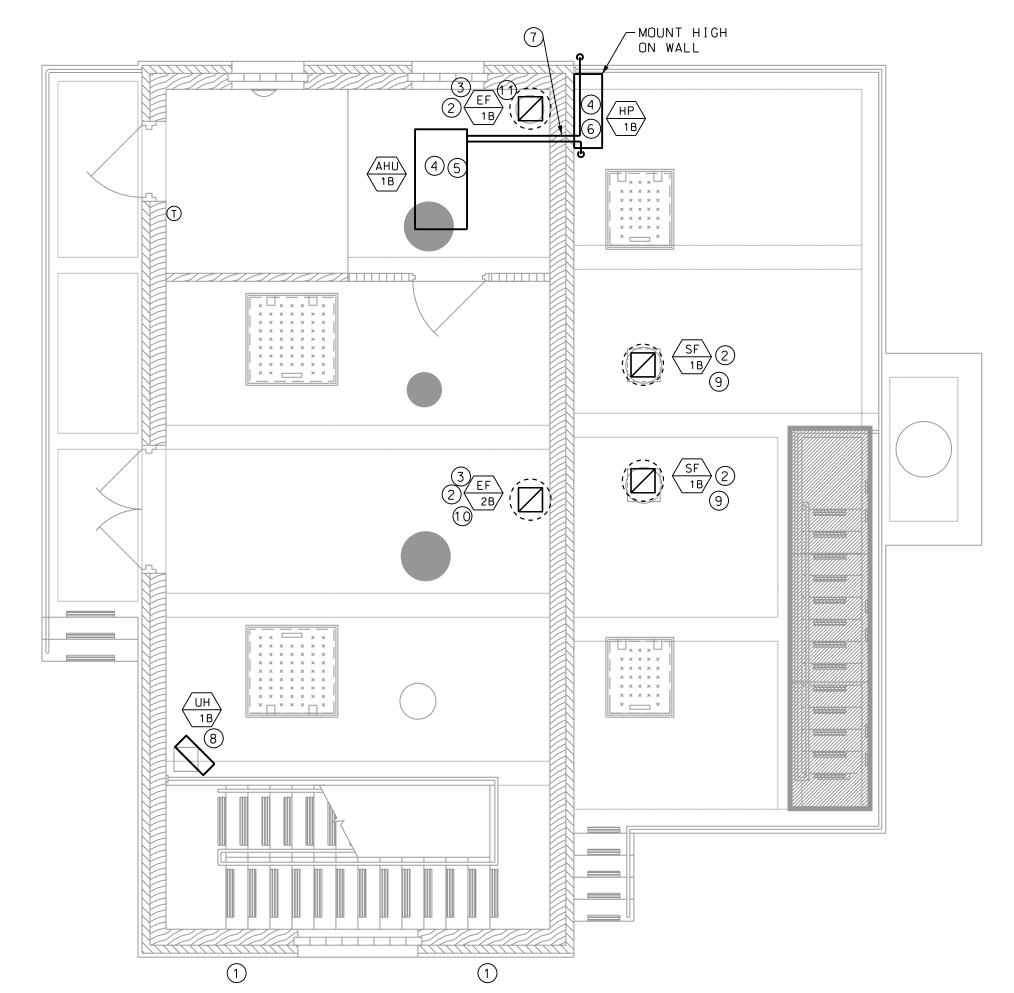


MODIFICATION TO PUMP STATION 4035 ENTRANCE FLOORPLAN - HVAC

M1.1 SCALE: 1/4" = 1'

NOTES:

- 1 EXISTING LOUVERS TO REMAIN FOR INTAKE AIR
- 2) REMOVE EXISTING FAN AND REPLACE WITH NEW AS SHOWN. CONNECT TO EXISTING DUCT. FIELD COORDINATE CONNECTIONS.
- 3 FAN SHALL BE PROVIDED WITH AIR PROVING SAIL SWITCH TO ALARM WHEN THERE IS NO AIR FLOW. COORDINATE WITH ELECTRICAL.
- AHU/HP SHALL BE MITSUBSHI MODEL PCA-A30KA6/PUZ-A30NHA6-BS (SEACOAST COATING) OR APPROVED EQUAL. UNIT SHALL BE PROVIDED WITH DISCONNECT SWITCH, WALL MOUNTING BRACKET FOR OUTDOOR UNIT, AND WIRED THERMOSTAT.
- (5) MOUNT UNIT TIGHT TO STRUCTURE ABOVE
- 6 MOUNT UNIT ON WALL
- CONDENSATE DRAIN LINE AND REFRIGERNAT LINE SET.
 COORDINATE ROUTING WITH EXISTING CONDITIONS AND
 OTHER TRADES. CONDENSATE TO TURN DOWN AND DRIP ON
- 8 UNIT HEATER SHALL BE QMARK MUH OR APPROVED EQUAL. HEATER SHALL BE SIZED FOR 7.5 KW WITH HORIZONTAL DISCHARGE. HEATER SHALL BE PROVIDED WITH MOUNTING BRACKETS. DISCONNECT SWITCH AND BUILT-IN THERMOSTAT.
- 9 SUPPLY FAN SHALL BE GREENHECK MODEL TCBRS-1-10 OR APPROVED EQUAL. FAN SHALL BE SPARK RESISTANT B WITH ALUMINUM WHEEL AND BELT DRIVEN MOTOR OUT OF THE AIR STREAM. FAN SHALL RUN CONTINUOUSLY. COORDINATE WITH EXISTING CONDITIONS AND ELECTRICAL. FAN SHALL BE SIZED FOR 350 CFM AT 0.25 ESP AND 1/4 HP.
- EXHAUST FAN SHALL BE GREENHECK MODEL TCBRU-1-10
 OR APPROVED EQUAL. FAN SHALL BE SPARK RESISTANT
 B WITH ALUMINUM WHEEL AND BELT DRIVEN MOTOR OUT
 OF THE AIR STREAM. FAN SHALL RUN CONTINUOUSLY.
 COORDINATE WITH EXISTING CONDITIONS AND
 ELECTRICAL. FAN SHALL BE SIZED FOR 600 CFM AT
 0.25 ESP AND 1/4 HP.
- EXHAUST FAN SHALL BE GREENHECK MODEL TCBRU-1-10 OR APPROVED EQUAL. FAN SHALL BE SPARK RESISTANT B WITH ALUMINUM WHEEL AND BELT DRIVEN MOTOR OUT OF THE AIR STREAM. FAN SHALL RUN CONTINUOUSLY. COORDINATE WITH EXISTING CONDITIONS AND ELECTRICAL. FAN SHALL BE SIZED FOR 1100 CFM AT 0.375 ESP AND 1/2 HP.



MODIFICATION TO PUMP STATION 4036 ENTRANCE FLOORPLAN - HVAC

M1.1 SCALE: 1/4" = 1'